


**MARBELLA**  
RESIDENCE  
7311 W. Mercer Way  
Mercer Is., WA 98040

SET TITLE:	PERMIT SET
SHEET TITLE:	SITE PLAN

STAMP:

PROJECT #: 20010  
DATE: SEPT. 23, 2020  
DRAWN BY: N.F.W.  
REVISIONS:

Tag	Description
1	M.I. BLDG. DEPT. REVIEW 9/20

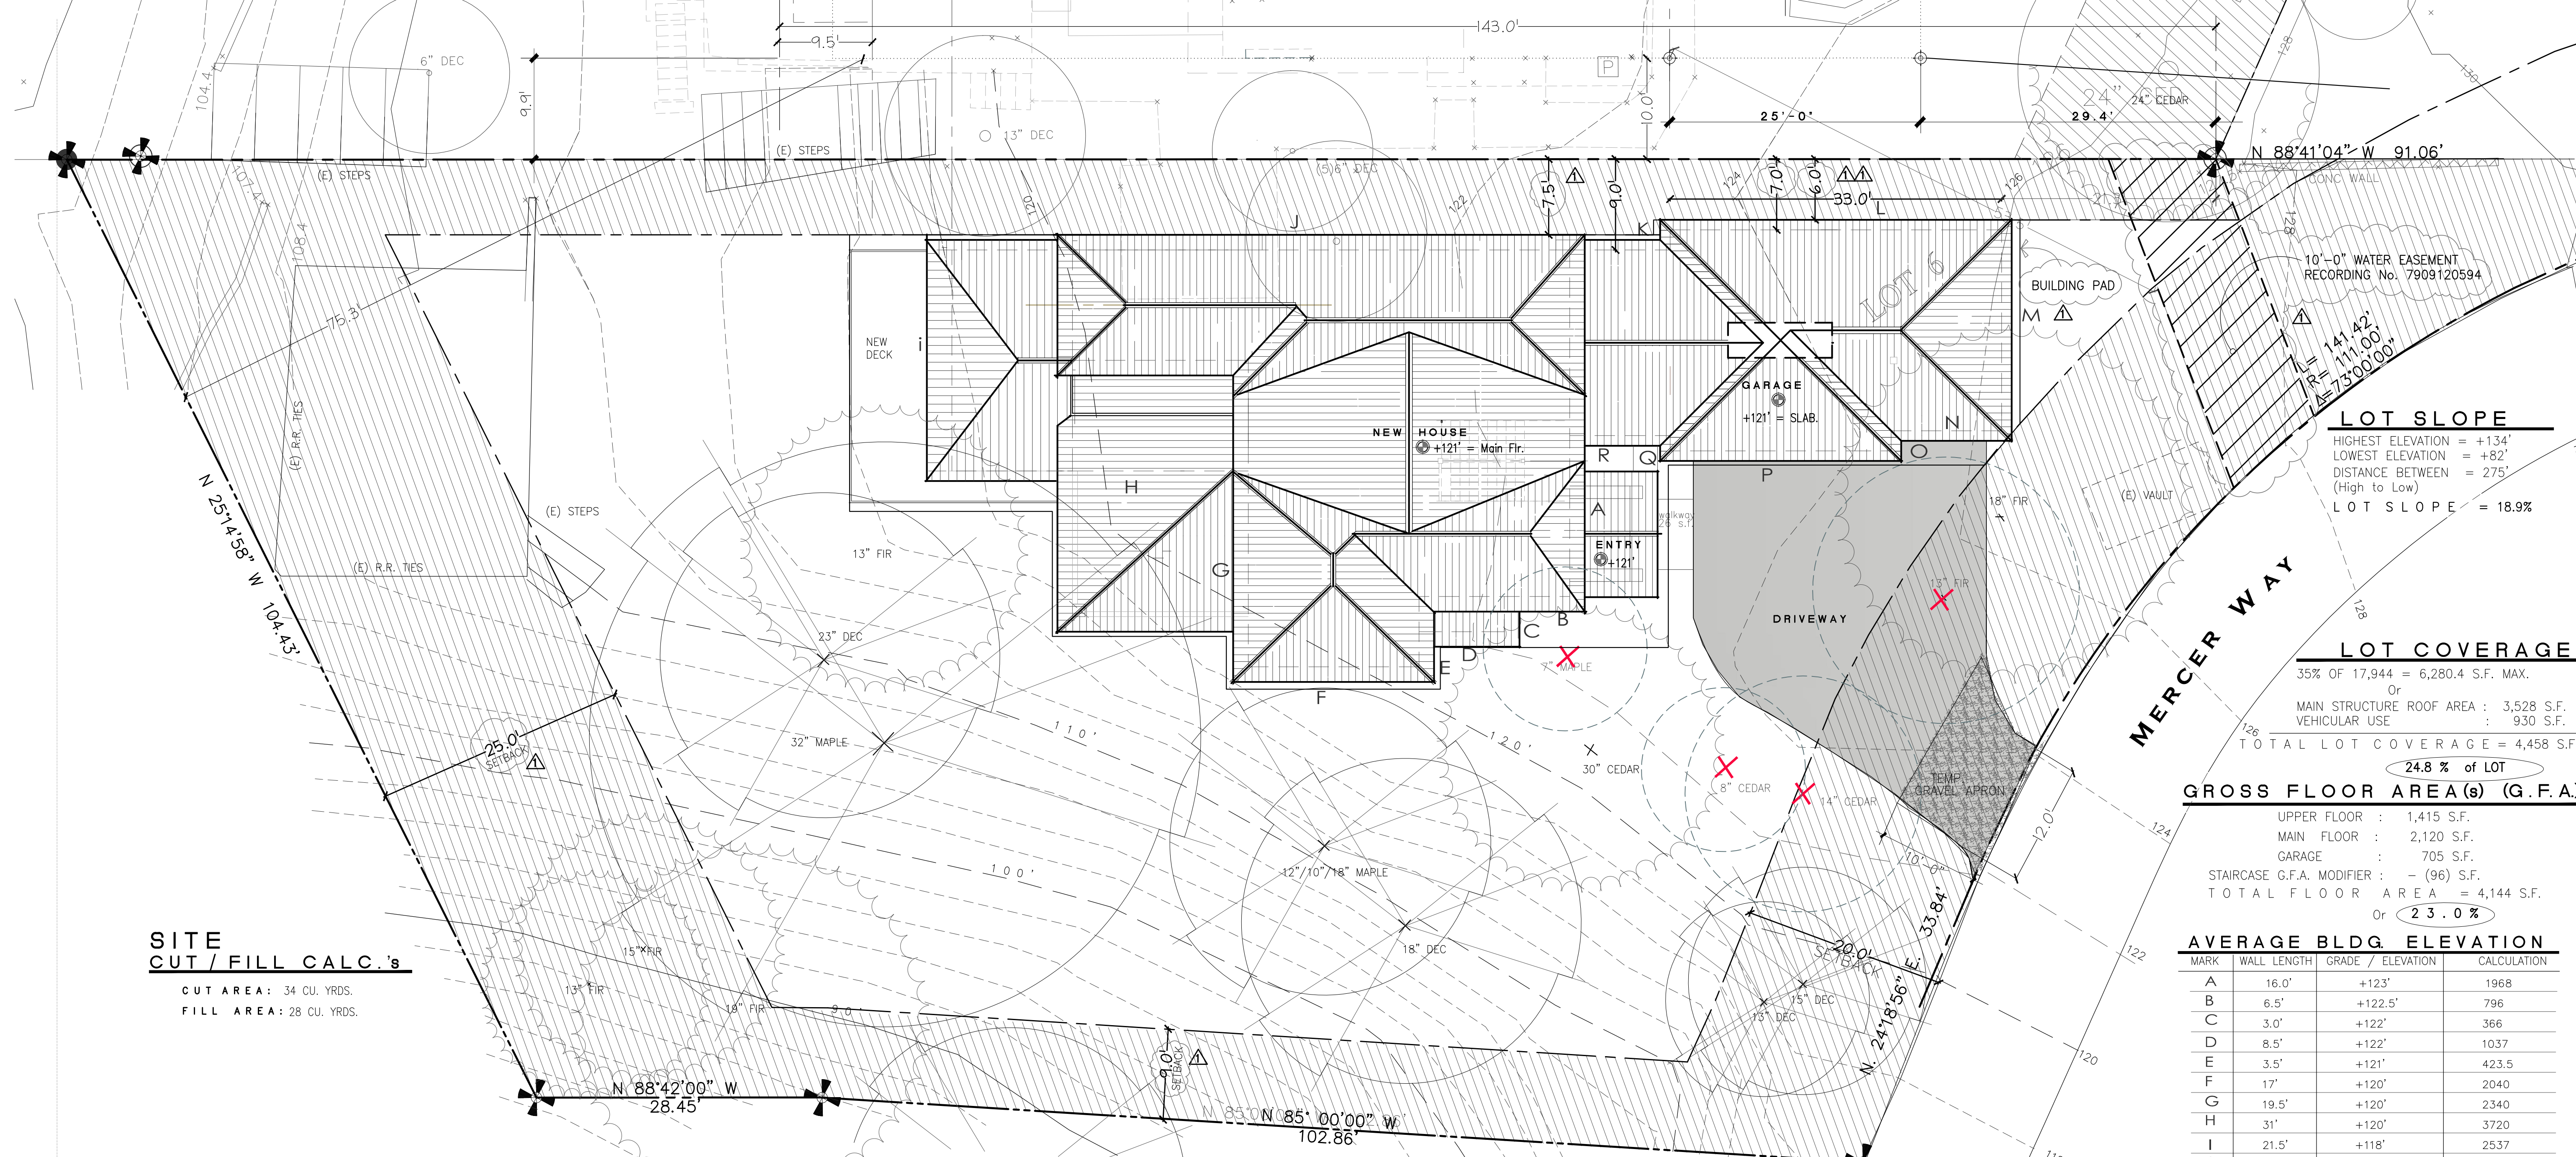

**SITE CUT / FILL CALC.'s**

CUT AREA: 34 CU. YRDS.  
FILL AREA: 28 CU. YRDS.

**LOT SLOPE**  
HIGHEST ELEVATION = +134'  
LOWEST ELEVATION = +82'  
DISTANCE BETWEEN = 275'  
(High to Low)  
LOT SLOPE = 18.9%

**LOT COVERAGE**  
35% OF 17,944 = 6,280.4 S.F. MAX.  
Or  
MAIN STRUCTURE ROOF AREA : 3,528 S.F.  
VEHICULAR USE : 930 S.F.  
TOTAL LOT COVERAGE = 4,458 S.F.

**GROSS FLOOR AREA (G.F.A.)**  
24.8 % of LOT  
UPPER FLOOR : 1,415 S.F.  
MAIN FLOOR : 2,120 S.F.  
GARAGE : 705 S.F.  
STAIRCASE G.F.A. MODIFIER : - (96) S.F.  
TOTAL FLOOR AREA = 4,144 S.F.  
Or **23.0 %**

**AVERAGE BLDG. ELEVATION**

MARK	WALL LENGTH	GRADE / ELEVATION	CALCULATION
A	16.0'	+123'	1968
B	6.5'	+122.5'	796
C	3.0'	+122'	366
D	8.5'	+122'	1037
E	3.5'	+121'	423.5
F	17'	+120'	2040
G	19.5'	+120'	2340
H	31'	+120'	3720
I	21.5'	+118'	2537
J	73'	+121.5'	8869.5
K	2.0'	+123'	246
L	33.0'	+125'	4125
M	20.0'	+126'	2520
N	10.5'	+126'	1323
O	2.0'	+125'	250
P	22.5'	+124'	2790
Q	1.5'	+123'	184.5
R	10.0'	+123'	1230
TOTAL	301		36,765.5

122.14 + 30 = ABE+30' = MAX. HT. = + 152'-1 2/3"

**SITE NOTES**

- PLACE COMPOST SOCKS, COMPOST BERMS, FILTER FABRIC FENCING, STRAW BAILS, STRAW WATTLES, OR OTHER APPROVED PERIMETER CONTROL BMP'S TO ELIMINATE CONSTRUCTION STORMWATER RUN-OFF.
- ELIMINATE UNCONTROLLED CONVEYANCE OF MUD & DIRT INTO THE RIGHT-OF-WAY (R.O.W.)
- COVER BARE SOILS WITH COMPOST BLANKETS, STRAW, MULCH, MATTING, OR OTHER APPROVED EQUAL TO CONTROL CONSTRUCTION STORMWATER RUN-OFF.
- COVER STOCKPILES OF BARE SOILS WITH COMPOST BLANKETS, TAPPS, MATTING OR OTHER APPROVED EQUAL TO CONTROL CONSTRUCTION STORMWATER RUN-OFF.
- MERCER ISLAND - MICC 19.02.030(F)(3)(d) ALL JAPANESE KNOTWEED, (POLYGONUM CUSPIDATUM), & REGULATED CLASS 'A', REGULATED CLASS 'B', REGULATED CLASS 'C' WEEDS, IDENTIFIED ON KING COUNTY NOXIOUS WEED LIST SHALL BE REMOVED FROM PROPERTY.
- ROCK SUPPLIED FOR SITE 'DRAINAGE SWALES' SHALL BE LOCALLY SOURCED

**SITE PLAN**

**SITE KEY**

- SETBACK LINE
- PROPERTY LINE
- CONTINUOUS FILTER FENCE
- SETBACK LINE
- EXISTING SITE CONTOUR LINE
- NEW CONTOUR LINE
- REVISED CONTOUR LINE
- EXISTING TREE TO BE REMOVED
- ELEVATION MARK
- TEMPORARY QUARRY ROCK APRON
- NEW DRIVEWAY SURFACE
- SETBACK AREA
- EXISTING DRIVEWAY AREA REMOVED
- PROPERTY CORNER MARK

**SITE INFORMATION**

ZONE : R-15  
PARCEL No. 894422-0060  
LOT AREA: 17,944 S.F.  
Legal Description: \* LOT 6, VILLA MARBELLA  
(\* See Survey for FULL-LEGAL)

**CONTACT INFORMATION**

RICHARD A. FISHER  
(206) 484-9963

**ENERGY NOTES**

CLIMATE ZONE: 4C - MARINE  
SPACE HEAT TYPE: NATURAL GAS, FORCED AIR.  
INSULATION VALUES: PRESCRIPTIVE METHOD ( ALL NEW AREA )  
WALLS: R-21  
FLAT ATTICS/CEILINGS: R-49/R-38  
FLOORS (OVER UNHEATED SPACES): R-38  
VAULTED CEILINGS: R-38  
SLAB-ON-GRADE: R-10

**VENTILATION:**  
ATTICS WITH BATTS: BAFFLE VENT OPENINGS TO DEFLECT AIR ABOVE INSULATION SURFACE.  
ENCLOSED JOIST OR RAFTER SPACES: PROVIDE MINIMUM OF ONE INCH CLEAR VENTED AIR SPACE ABOVE INSULATION. TAPER OR COMPRESS INSULATION AT PERIMETER TO INSURE PROPER VENTILATION.

**HEATING & COOLING:**  
FORCED AIR NATURAL GAS HEATING SYSTEM.

**TEMP. CONTROL:**  
FOR HEATING AND COOLING, THERMOSTAT SHALL BE CAPABLE OF BEING SET FROM 55-85 DEGREES FARENHEIT AND OF OPERATING THE HEATING/COOLING SYSTEM IN SEQUENCE. THERMOSTAT TO BE AUTOMATIC DAY/NIGHT SETBACK TYPE.

**DUCT INSULATION:**  
THERMALLY INSULATE ALL PLENUMS, DUCTS AND ENCLOSURES IN ACCORDANCE WITH TABLE 406.2 OF THE 2015 WASHINGTON STATE ENERGY CODE.  
o. ALL HEATING DUCTS IN UNCONDITIONED SPACES SHALL BE INSULATED WITH A MIN. OF R-8. ALL SEAM JOINTS SHALL BE TAPED, SEALED AND FASTENED WITH THE MINIMUM OF FASTENERS PER 2015 WSEC.

**ENERGY CREDITS**

**EFFICIENT BUILDING ENVELOPE** (.5 Credit)  
CREDIT OPTION (10) - VERTICAL PENETRATION U = 0.28  
= FLOOR = R-38  
= PROVIDE R-10 INSULATION BELOW ENTIRE SLAB AREA

**AIR LEAKAGE CONTROL & EFFICIENT VENTILATION** (.5 Credit)  
CREDIT OPTION (20) - COMPLIANCE BASE ON R402.4.1.2: REDUCE THE TEST & WHOLE HOUSE VENTILATION REQUIREMENTS AS DETERMINED BY SECTION M1507.3 OF THE EFFICIENCY FAN (MAX 0.35 WATTS/CFM) NOT INTERLOCKED WITH THE SURFACE FAN. VENTILATION SYSTEMS USING A FURNACE INCLUDING A ECM MOTOR ARE ALLOWED, PROVIDED THAT THEY ARE IN VENTILATION MODE ONLY.

**HIGH EFFICIENT HVAC EQUIPMENT** (1.0 Credit)  
CREDIT OPTION (30) - GAS, FURNACE WITH A MINIMUM 'AFUE' OF 94%. HEATING OPTION: 3a, 3b, 3c, OR 3d. WHEN A HOUSING UNIT HAS TWO PIECES OF EQUIPMENT, (IE, TWO FURNACES) BOTH MUST MEET THE STANDARD TO RECEIVE CREDIT. FURNACE(S) TO BE 'DIRECT-VENTED' PER IRC SECT. G2406.2

**HIGH EFFICIENT WATER HEATING** (1.5 Credits)  
CREDIT OPTION (50) - WATER HEATING SYSTEM SHALL BE GAS HEATED  
- WATER HEATER(S) SHALL BE MINIMUM 91% EFFICIENCY.

**GENERAL NOTES**


- CODE COMPLIANCE:** ALL WORK SHALL COMPLY WITH THE 2015 IRC, 2015 IRC, 2015 IMC, 2015 IFGC, 2015 NATIONAL FUEL GAS CODE, NFPA 54, 2015 LIQUEFIED PETROLEUM GAS CODE, NFPA 58, 2015 IFC, 2015 UPC, 2015 WSEC, WAC 51-11, 2015 WAO, WAC 51-13, 2015 NEC, AND WITH ALL LOCAL CODES AND ORDINANCES.
- DIMENSIONS:** A. DO NOT SCALE DRAWINGS. VERIFY ALL DIMENSIONS PRIOR TO STARTING CONSTRUCTION. NOTIFY THE ARCHITECT OF DISCREPANCIES. IF WORK IS STARTED PRIOR TO NOTIFICATION, THE GENERAL AND SUBCONTRACTOR PROCEED AT THEIR OWN RISK. B. UNLESS OTHERWISE NOTED, PLAN DIMENSIONS ARE TO FACE OF STUDS OR FACE OF CONCRETE WALLS. FACE OF STONE VENEER LIES 6" +/- OUTSIDE THE FACE OF FRAMING. INTERIOR PLAN DIMENSIONS ARE TO FACE OF STUDS UNLESS OTHERWISE NOTED. C. VERIFY ALL ROUGH-IN DIMENSIONS FOR WINDOWS, DOORS, PLUMBING, ELECTRICAL FIXTURES AND APPLIANCES PRIOR TO COMMITMENT OF WORK. NOTIFY ARCHITECT OF ANY DISCREPANCIES OF DIMENSIONAL TOLERANCES REQUIRED.
- DOCUMENT REVIEW/VERIFICATION:** CONSULT WITH ARCHITECT REGARDING ANY SUSPECTED ERRORS, OMISSIONS, OR CHANGES ON PLANS BEFORE PROCEEDING WITH THE WORK.
- ROUGH OPENINGS/BACKINGS:** VERIFY SIZE AND LOCATION, AS WELL AS PROVIDE ALL OPENINGS THROUGH FLOORS AND WALLS, FURRING, CURBS, ANCHORS, INSERTS, EQUIPMENT BASES AND ROUGH BUCKS/BACKING FOR SURFACE-MOUNTED ITEMS.
- FURRING:** PROVIDE FURRING AS REQUIRED TO CONCEAL MECHANICAL AND/OR ELECTRICAL EQUIPMENT IN FINISHED AREAS. FURRING NOT SHOWN ON PLANS SHALL BE APPROVED BY ARCHITECT PRIOR TO CONSTRUCTION.
- GRADES:** VERIFY ALL GRADES AND THEIR RELATIONSHIP TO THE BUILDING(S).
- FLOOR LINES:** "FLOOR LINE" REFERS TO TOP OF CONCRETE SLAB OR TOP OF WOOD SUBFLOOR.
- REPETITIVE FEATURES:** OFTEN DRAWN ONLY ONCE AND SHALL BE COMPLETELY PROVIDED AS IF DRAWN IN FULL.
- DOORS:** DOORS NOT DIMENSIONALLY LOCATED SHALL BE 6" FROM STUD FACE TO EDGE OF DOOR, ROUGH OPENING OR CENTERED BETWEEN WALLS AS SHOWN.
- WOOD ON CONCRETE:** WOOD MEMBERS IN CONTACT WITH CONCRETE AND/OR EXPOSED TO WEATHER, PROVIDE PRESSURE TREATED SILL PLATES.
- FRAMING:** INTERIOR FURRING & PARTITION WALLS TO BE 2x4 @ 16" O.C.
- VENTILATION:** VENT ALL BATHROOM FANS, LAUNDRY FANS, RANGE HOODS AND DRYERS TO OUTSIDE ATMOSPHERE. BATHROOM/UTILITY ROOM FANS SHALL BE VENTED DIRECTLY TO THE OUTSIDE THROUGH SMOOTH, RIGID, NON-CORROSIVE METAL, 24 GA. DUCTWORK. FLEX DUCTING IS NOT ALLOWED.
- FLUES:** FLUES TO BE LOCATED MINIMUM 2" FROM ALL COMBUSTIBLE MATERIALS.
- BASEMENT:** NO LPG PROPANE GAS APPLIANCES ARE ALLOWED IN THE BASEMENT.
- OTHER DOCUMENTATION:** REFER TO STRUCTURAL, MECHANICAL, ELECTRICAL AND/OR LANDSCAPE DRAWINGS FOR ADDITIONAL DRAWINGS, NOTES, SCHEDULES AND SYMBOLS.
- PROTECTION:** PROTECT ALL EXISTING FINISHES & SURFACES. ANY DAMAGE TO BE REPAIRED @ NO ADDITIONAL EXPENSE TO OWNER.
- PERMITS:** SEPARATE ELECTRICAL, MECHANICAL AND PLUMBING PERMITS ARE REQUIRED IN ADDITION TO THE BASIC BUILDING PERMIT.
- ROOFING:** SHEET METAL ROOFING PER IRC TABLE 905.10.3(1) & LOCAL ROOFING STANDARDS.
- FIREPLACE:** PREFABRICATED GAS FIREPLACE SHALL BE PROVIDED WITH THE FOLLOWING: A. PREFABRICATED FIREPLACE TO BEAR STAMP OF APPROVED TESTING LAB. B. TIGHT FITTING GLASS OR METAL DOORS C. OUTSIDE SOURCE OF COMBUSTION AIR DUCTED INTO THE FIREBOX, PER PREFAB. GAS FIREPLACE REQUIREMENTS. (6 SQ. INCHES MIN. W/OPERABLE OUTSIDE AIR DUCT DAMPER.) D. TIGHT FITTING FLUE DAMPERS, OPERATED BY A READILY ACCESSIBLE MANUAL.
- GAS WATER HEATER:** GAS WATER HEATER SHALL BE STRAPPED TO PREVENT DISPLACEMENT IN AN EARTHQUAKE PER UMC 304.4.
- EXHAUST DUCTS:** PROVIDE BACKRAFT DAMPERS AT ALL EXHAUST DUCTS.
- FURNACE ROOM:** PROVIDE COMBUSTION AIR OPENINGS INTO FURNACE RM. PER UMC 703.
- APPLIANCES:** CLEARANCES OF UL LISTED APPLIANCES FROM COMBUSTIBLE MATERIALS SHALL BE AS SPECIFIED IN UL LISTING.
- WATER FLOW:** SHOWER SHALL BE EQUIPPED WITH FLOW CONTROL DEVICE TO LIMIT WATER FLOW TO 2.5 GALLONS PER MINUTE.
- SMOKE DETECTORS:** S.D. THROUGHOUT NEW CONSTRUCTION PER 2006 IRC R313. TO BE MONITORED PER FIRE DEPT. REQUIREMENTS

**HARDSCAPE CALCULATION**

DECK: 238 SQ. FT.  
ENTRY / WALKS: 28 SQ. FT.  
TOTAL HARDSCAPE: 266 S.F.  
Or **1.48 %**

**ENERGY CODE**

-HEATING SYSTEM IS A NATURAL GAS FURNACE FORCED AIR SYSTEM.  
-CONSTRUCTION SHALL ADHERE TO:  
**GLAZING RATIO**  
CLIMATE ZONE: 4C - MARINE  
-PERSCRIPTIVE PATH  
MARINE IV  
WINDOWS - 0.28 U-FACTOR  
DOORS - 0.20 U-FACTOR

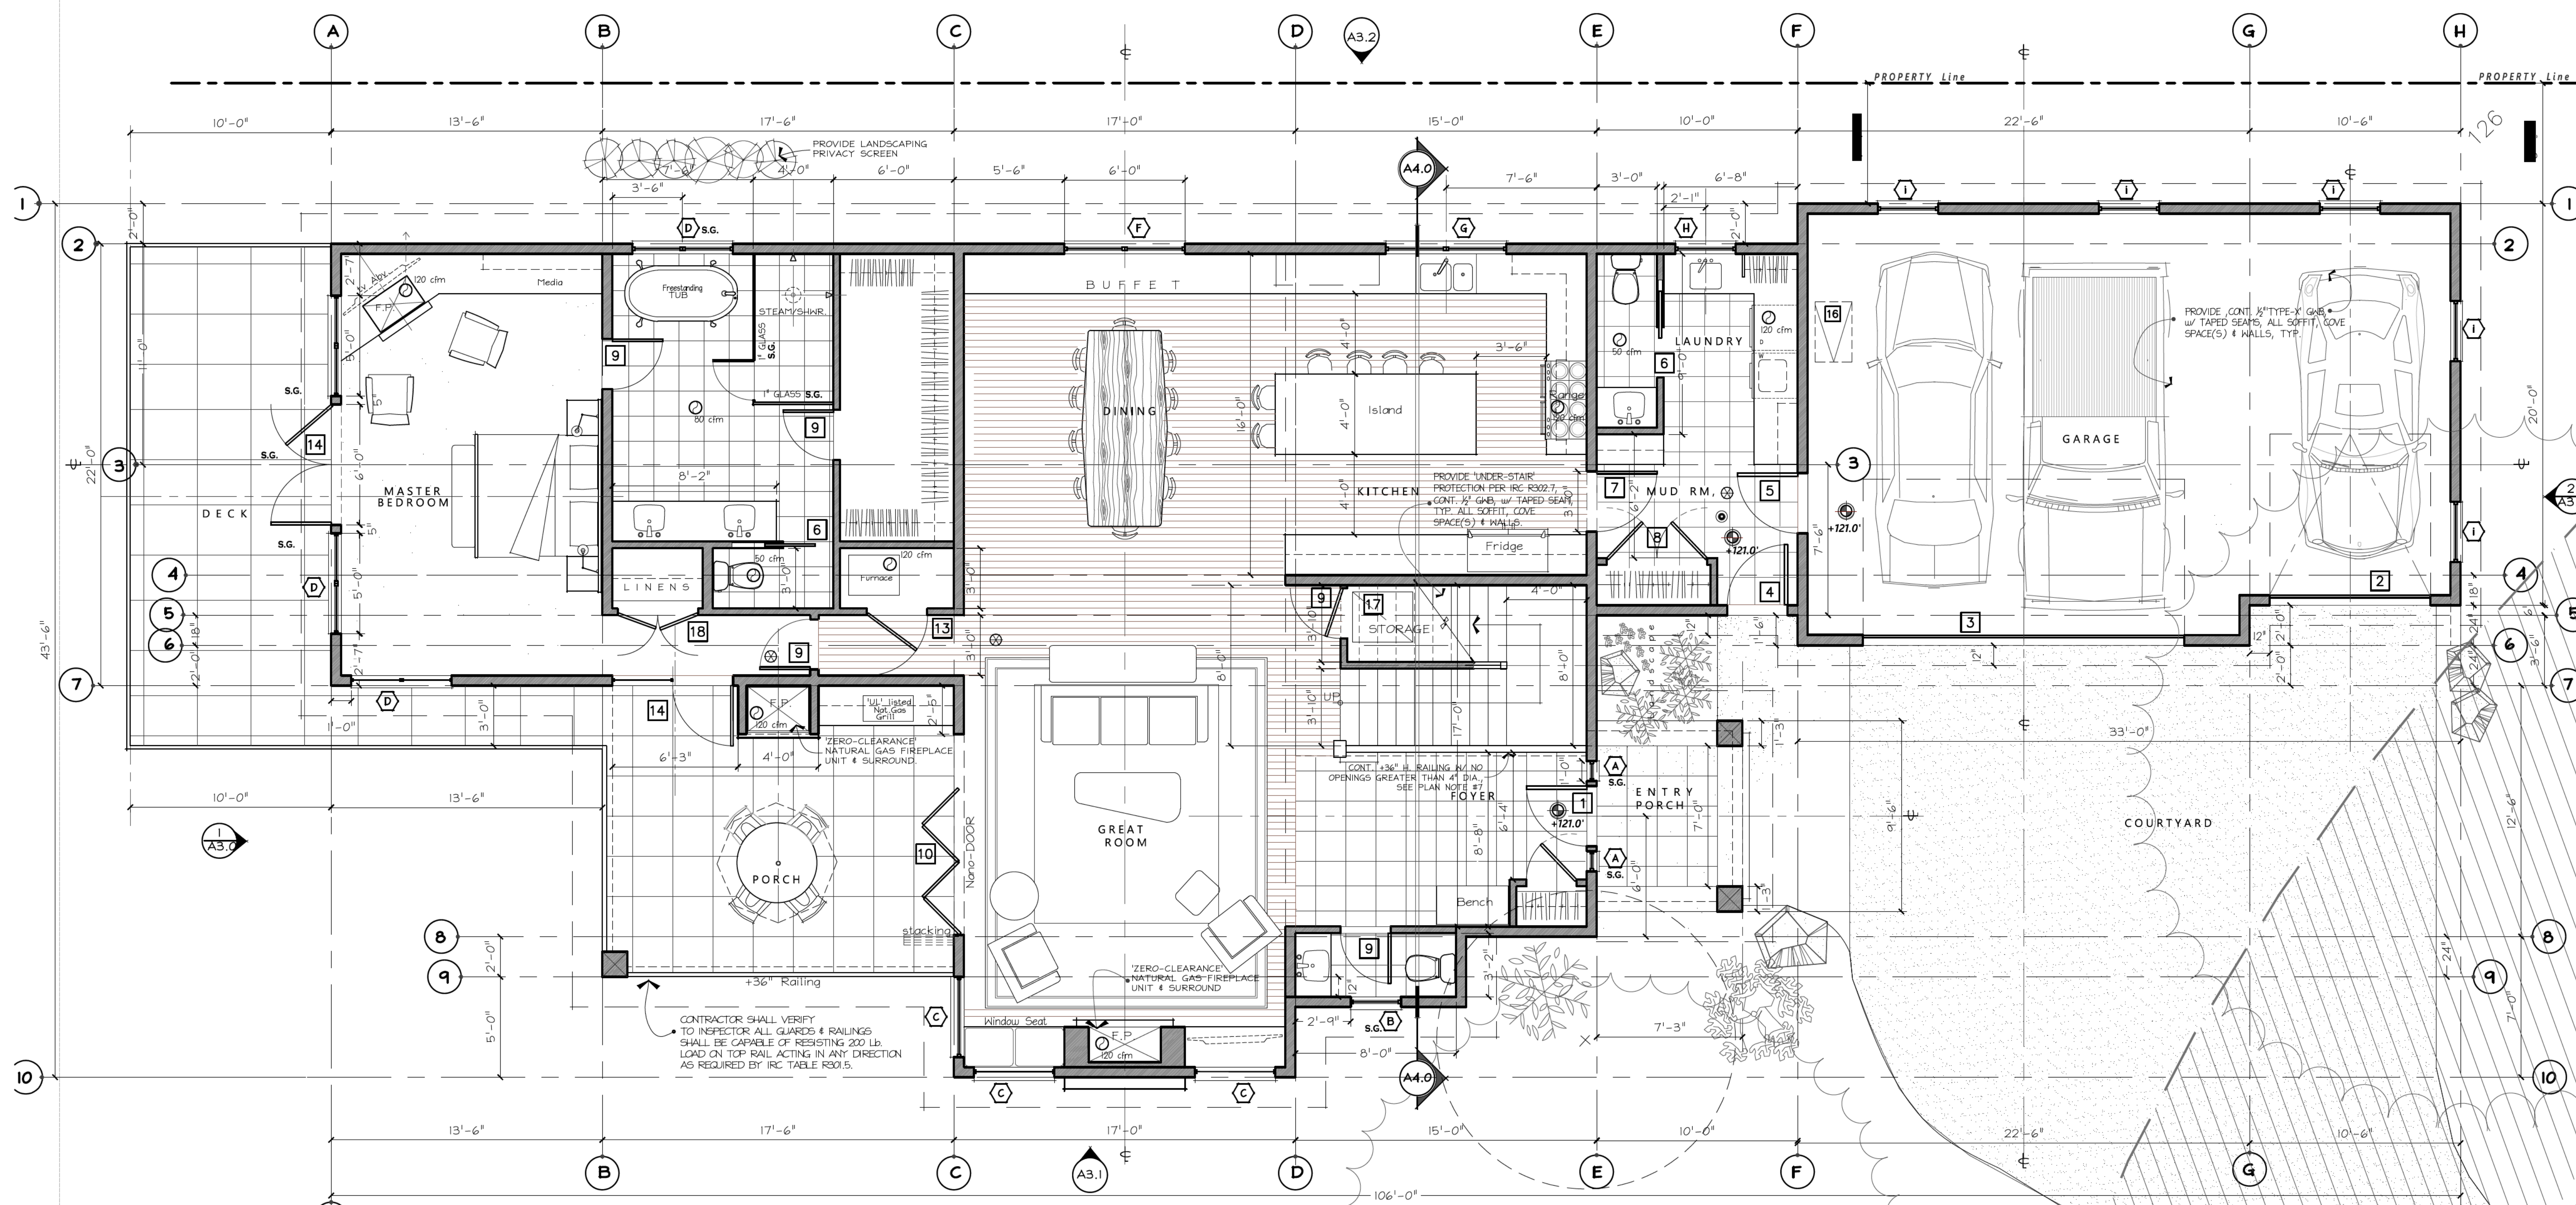

**WINDOW SCHEDULE**

TAG	DIMENSIONS (RO=WXH)	TYPE	NOTES
A	1'-0" X 6'-0"	SIDELITE	SAFETY GLAZE / (2) LITES Ea.
B	2'-6" X 5'-0"	CASEMENT	SAFETY GLAZE
C	4'-0" X 6'-0"	CASEMENT	SAFETY GLAZE
D	(2) 2'-6" X 6'-0"	CSMNT/CSMNT	SAFETY GLAZE
E	(2) 2'-6" X 4'-0"	CASEMENT	(4) LITES
F	(2) 3'-0" X 4'-6"	CSMNT/CSMNT	
G	(2) 3'-0" X 4'-6"	CSMNT/CSMNT	(4) LITES
H	3'-0" X 4'-6"	CASEMENT	(4) LITES
I	3'-0" X 3'-0"	CASEMENT	
J	2'-6" X 3'-0"	CASEMENT	SAFETY GLAZE / (4) LITES Ea.
K	2'-6" X 4'-0"	CASEMENT	SAFETY GLAZE / (4) LITES Ea.
L	3'-0" X 4'-6"	CASEMENT	(2) LITES
M	(2) 2'-6" X 4'-6"	CSMNT/CSMNT	
N	(2) 2'-6" X 3'-6"	CSMNT/CSMNT	
O	(2) 2'-0" X 3'-6"	CSMNT/CSMNT	SAFETY GLAZE / (4) LITES Ea.
P	3'-0" X 6'-0"	PICTURE	SAFETY GLAZE / (8) LITES Ea.
Q	2'-6" X 4'-6"	CASEMENT	

NOTES:  
1. 'S.G.' = SAFETY GLAZING.  
2. DOOR 'U-FACTOR' = 0.20  
3. WINDOW 'U-FACTOR' = 0.28

**DOOR SCHEDULE**

TAG	DIMENSIONS (RO=WXH)	TYPE	NOTES
1	3'-0" X 8'-0"	ENTRY	SOLID WD./SAFETY GLAZE / LOCKSET
2	8'-0" X 8'-0"	GARAGE	'CARRAIGE STYLE'
3	16'-0" X 8'-0"	GARAGE	'CARRAIGE STYLE'
4	3'-0" X 8'-0"	HALF-GLASS	SAFETY GLAZE
5	3'-0" X 6'-8"	SEPARATION	1-HOUR FIRE RATED w/ INTEGRAL SMOKE GASKETS
6	2'-6" X 6'-8"	POCKET	SLIDER HARDWARE
7	3'-0" X 6'-8"	STND. WOOD	
8	(2) 2'-6" X 6'-8"	STND. WOOD	
9	2'-6" X 6'-8"	STND. WOOD	
10	(4) 2'-6" X 8'-0"	FOLDING	'Nano Door' - SAFETY GLAZE
11	(3) 3'-0" X 6'-8"	HALF-GLASS	SAFETY GLAZE
12	3'-0" X 6'-8"	HALF-GLASS	SAFETY GLAZE
13	3'-0" X 6'-8"	SOLID WOOD	LOUVERED MECH. DOOR - SEE PLAN NOTE 18
14	(2) 3'-0" X 8'-0"	GLASS	EXT. FRENCH HUNG /SAFETY GLAZE / LOCK
15	(2) 2'-0" X 6'-8"	STND. WOOD	
16	22.5" X 4'-0"	ATTIC ACCESS	DROP DOWN LADDER
17	2'-6" X 3'-0"	CRANKSPACE ACCESS	HINGED - INSULATED PANEL

NOTES:  
1. 'S.G.' = SAFETY GLAZING.  
2. DOOR 'U-FACTOR' = 0.20  
3. WINDOW 'U-FACTOR' = 0.28  
4. OWNER OPTION-1 : All interior doors on the main floor may be 8'-0" tall.

**PLAN NOTES**

- WHOLE HOUSE VENTILATION TO BE PROVIDED BY FORCED AIR FURNACE WITH DIRECT OUTSIDE AIR.
- SMOKE DETECTORS SHALL BE HARD-WIRED & PROVIDED IN EXISTING SPACES w/ BATTERY BACK-UP PER IRC 313 & INSTALLED PER IRC 314.2.2
- STAIR HANDRAILS TO CONFORM TO I.R.C. SECT. 311.5.6. w/ 36" ht. FROM TREAD NOSING, TYP.
- ALL OUTLETS @ COUNTER HEIGHT, (BATHS, KITCHEN, LAUNDRY) SHALL BE G.F.C.I.
- DO NOT SCALE OFF DRAWINGS, NOTED DIMENSIONS SHALL @ ALL TIMES TAKE PRECEDENT. DIMS. ARE TO FACE OF FRAMING, TYP. -WDN. & DOOR DIMS. ARE TO ROUGH OPENING
- SEE SHEET A2.1 FOR WINDOW SCHEDULE.
- CONTRACTOR SHALL VERIFY TO INSPECTOR ALL GUARDS & RAILINGS SHALL BE CAPABLE OF RESISTING 200 LB. LOAD ON TOP RAIL ACTING IN ANY DIRECTION AS REQUIRED BY IRC TABLE R301.5.
- MECHANICAL RM. DOOR PER IMC SECTION 303.3. ALL COMBUSTIBLE AIR MUST BE TAKEN FROM OUTDOORS IN ACCORDANCE WITH IMC CHAPTER 7. MECHANICAL RM. DOORS SHALL BE SOLID CORE WITH EXTERIOR WEATHER STIPPIING & APPROVED SELF-CLOSING DEVICE.
- SEE STRUCTURAL FOUNDATION PLAN FOR CRANKSPACE VENTING

**PLAN KEY**

- 6" EXTERIOR WALL
- 4" PARTITION WALL
- SMOKE DETECTOR
- MECHANICAL VENT FAN (CUBIC FEET PER MINUTE)
- ELEVATION MARKER
- SAFETY-GLAZING
- CARBON MONOXIDE DETECTOR (APPROVED PER IRC315.1)
- CENTERLINE
- SETBACK LINE
- DRIVEWAY SURFACE

**MAIN FLOOR PLAN**

MAIN FLOOR AREA: 2,120 S.F.  
GARAGE AREA: 705 S.F.  
SCALE: 1/4" = 1'-0"

PROJECT NAME:	PROJECT ADDRESS:
<b>MARBELLA</b>	<b>7311 W. Mercer Way</b>
RESIDENCE	<b>-Mercer Is., WA 98040</b>

SET TITLE:	PERMIT SET
SHEET TITLE:	UPPER FLOOR


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PROJECT #: 20010  
DATE: SEPT. 23, 2020  
DRAWN BY: N.F.W.  
REVISIONS:

Tag	Description

SHEET No.:

**A2.1**

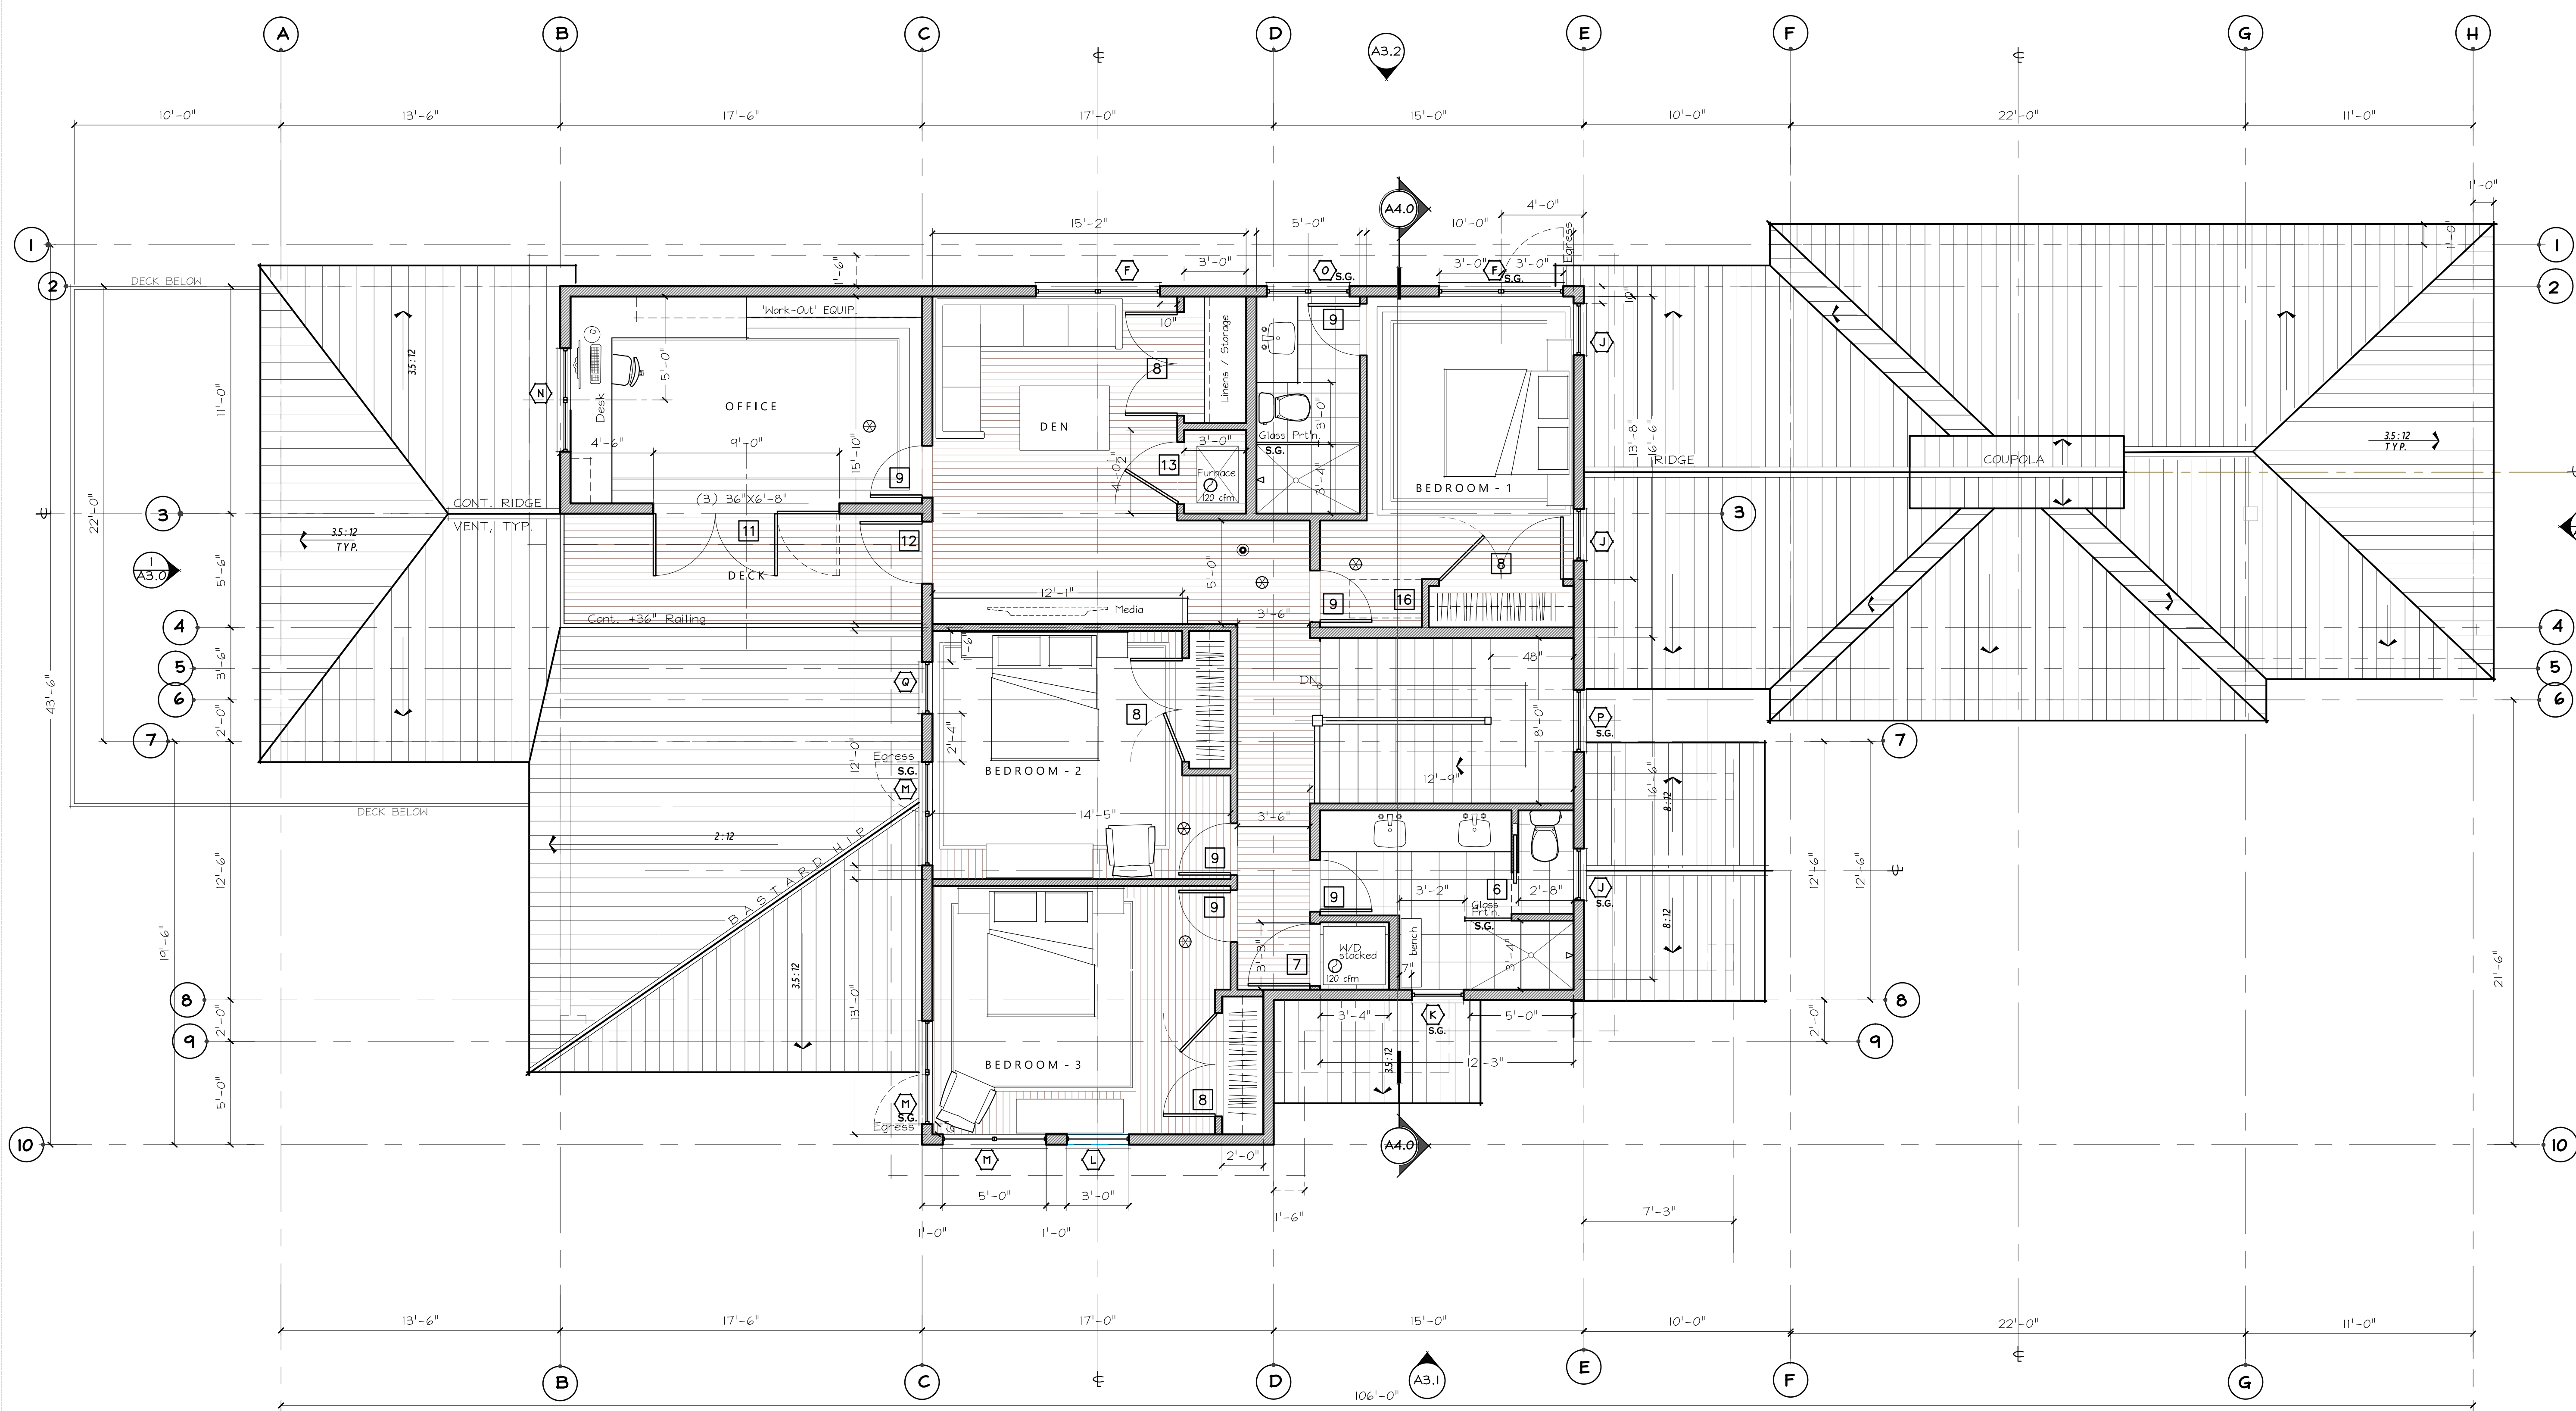


**PLAN NOTES**

- WHOLE HOUSE VENTILATION TO BE PROVIDED BY FORCED AIR FURNACE WITH DIRECT OUTSIDE AIR.
- SMOKE DETECTORS SHALL BE HARD-WIRED & PROVIDED IN EXISTING SPACES W/ BATTERY BACK-UP PER IRC 313 & INSTALLED PER IRC 314.2.2
- STAIR HANDRAILS TO CONFORM TO I.R.C. SECT. 311.5.6. w/ 36" ht. FROM TREAD NOSING, TYP.
- ALL OUTLETS @ COUNTER HEIGHT, (@BATHS, KITCHEN, LAUNDRY) SHALL BE G.F.C.I.
- DO NOT SCALE OFF DRAWINGS. NOTED DIMENSIONS SHALL @ ALL TIMES TAKE PRECEDENT. DIMS. ARE TO FACE OF FRAMING, TYP. -WDW. & DOOR DIMS. ARE TO ROUGH OPENING
- SEE SHEET A2.1 FOR WINDOW SCHEDULE.

**PLAN KEY**

- 6" EXTERIOR WALL
- 4" PARTITION WALL
- SMOKE DETECTOR
- MECHANICAL VENT FAN (CUBIC FEET PER MINUTE)
- ELEVATION MARKER
- SAFETY-GLAZING
- CARBON MONOXIDE DETECTOR (APPROVED PER IRC315.1)
- CENTERLINE

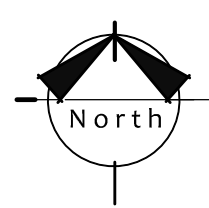

**UPPER FLR./ LOW ROOF PLAN**


AREA: 1,415 S.F.

SCALE: 1/4" = 1'-0"

PROJECT NAME:	PROJECT ADDRESS:
<b>MARBELLA</b>	<b>7311 W. Mercer Way</b>
RESIDENCE	<b>-Mercer Is., WA 98040</b>

SET TITLE:	PERMIT SET
SHEET TITLE:	ROOF PLAN

STAMP:

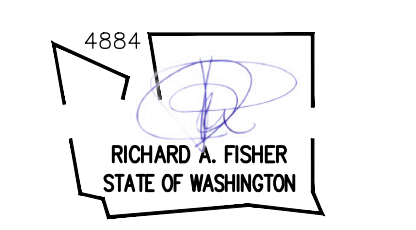


PROJECT #: 20010  
DATE: SEPT. 23, 2020  
DRAWN BY: N.F.W.  
REVISIONS:

Tag	Description

SHEET No.:

**A2.2**

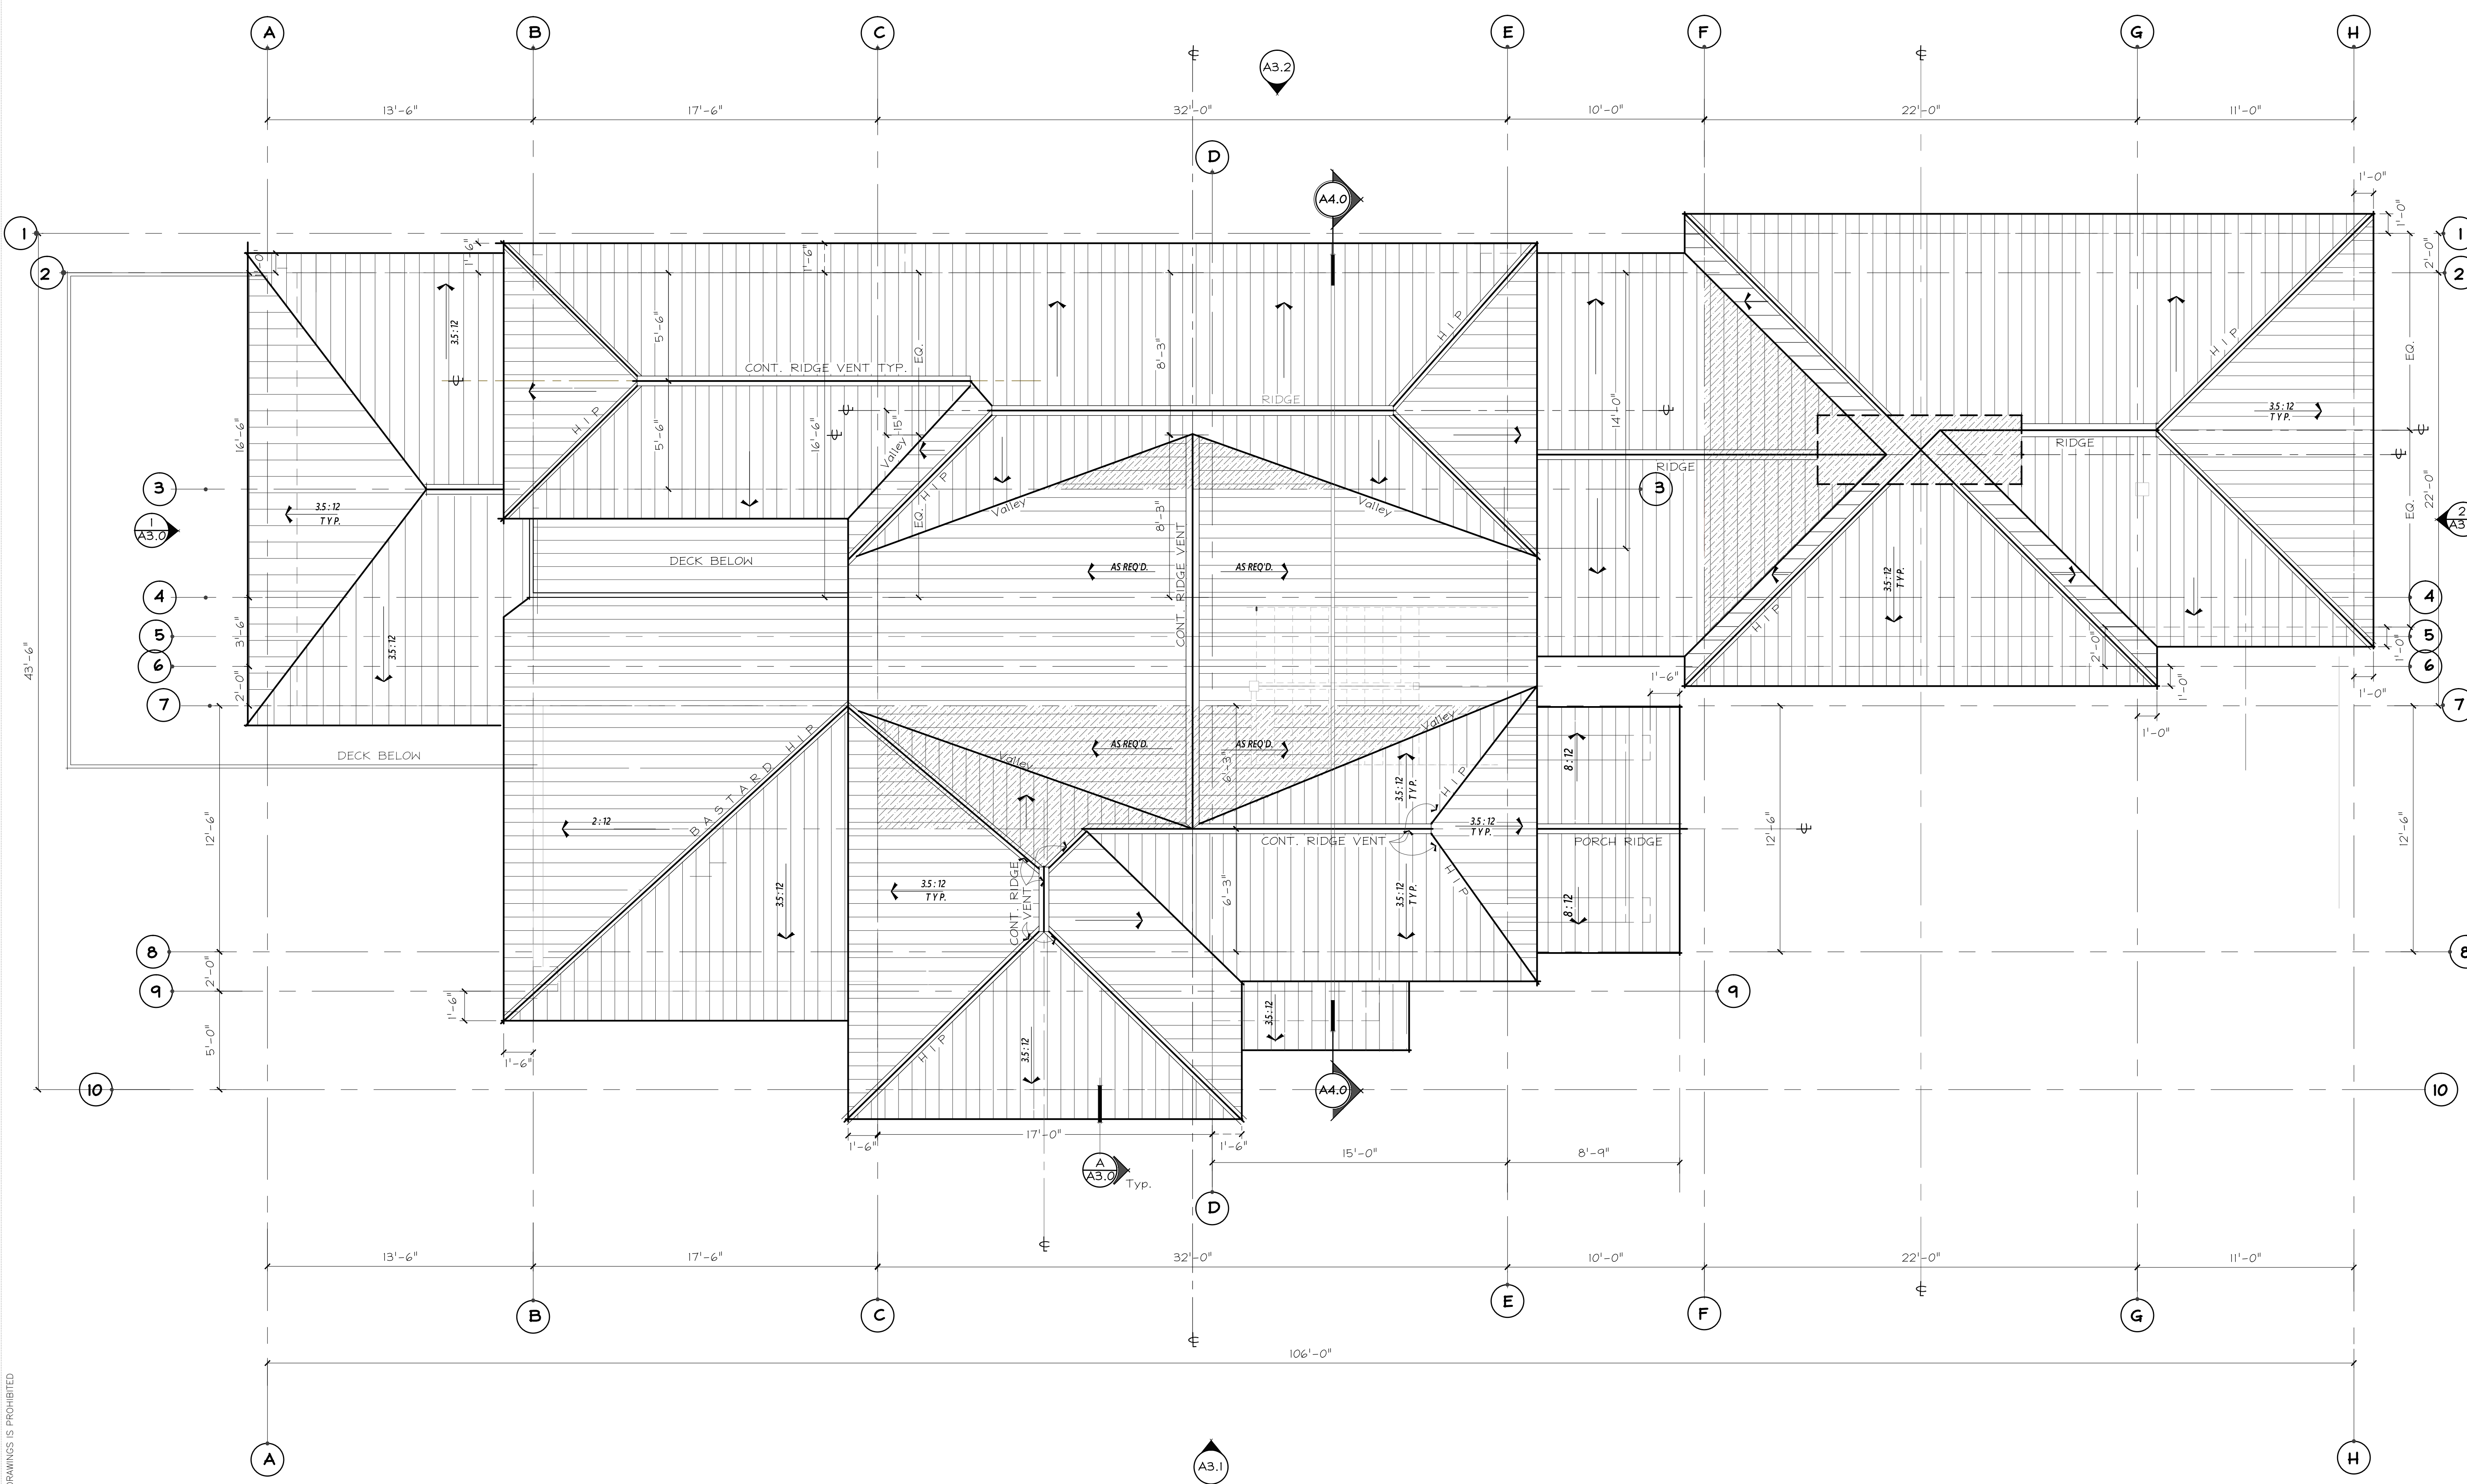

**ROOF PLAN** SCALE: 1/4" = 1'-0"

NOTES:  
1. ALL ROOF PITCHES = 3 1/2 : 12  
2. TYPICAL OVERHANG AT GARAGE : 12"  
TYPICAL OVERHANG AT UPPER FLOORS : 18"

**PLAN KEY**

	STRUCTURE BELOW		AREA OF ROOF OVER-FRAME
	AREA OF METAL ROOFING		CONTINUOUS RIDGE VENT

**ATTIC VENTING CALCULATION**

HOUSE ATTIC AREA = 2,120 S.F.

CALCULATION  
 $2120 / 300 = 7.07$  sq.ft. or 1,018 sq.in. REQUIRED VENTING

RIDGE VENTS PROVIDED = 134 Linear Feet X 16 sq.in. = 2,144 sq.in.  
SOFFIT VENTS PROVIDED = 218 Linear Feet X 24 sq.in./ft. = 5,232 sq.in.



PROJECT NAME: **MARBELLA**  
PROJECT ADDRESS: **RESIDENCE**  
**7311 W. Mercer Way**  
**-Mercer Is., WA 98040**


SET TITLE: **PERMIT SET**  
SHEET TITLE: **EXTERIOR ELEVATION**

STAMP:  
4884  
RICHARD A. FISHER  
STATE OF WASHINGTON

PROJECT #: **20010**  
DATE: **SEPT. 23, 2020**  
DRAWN BY: **N. F. W.**  
REVISIONS:

Tag	Description

SHEET No.: **A3.1**

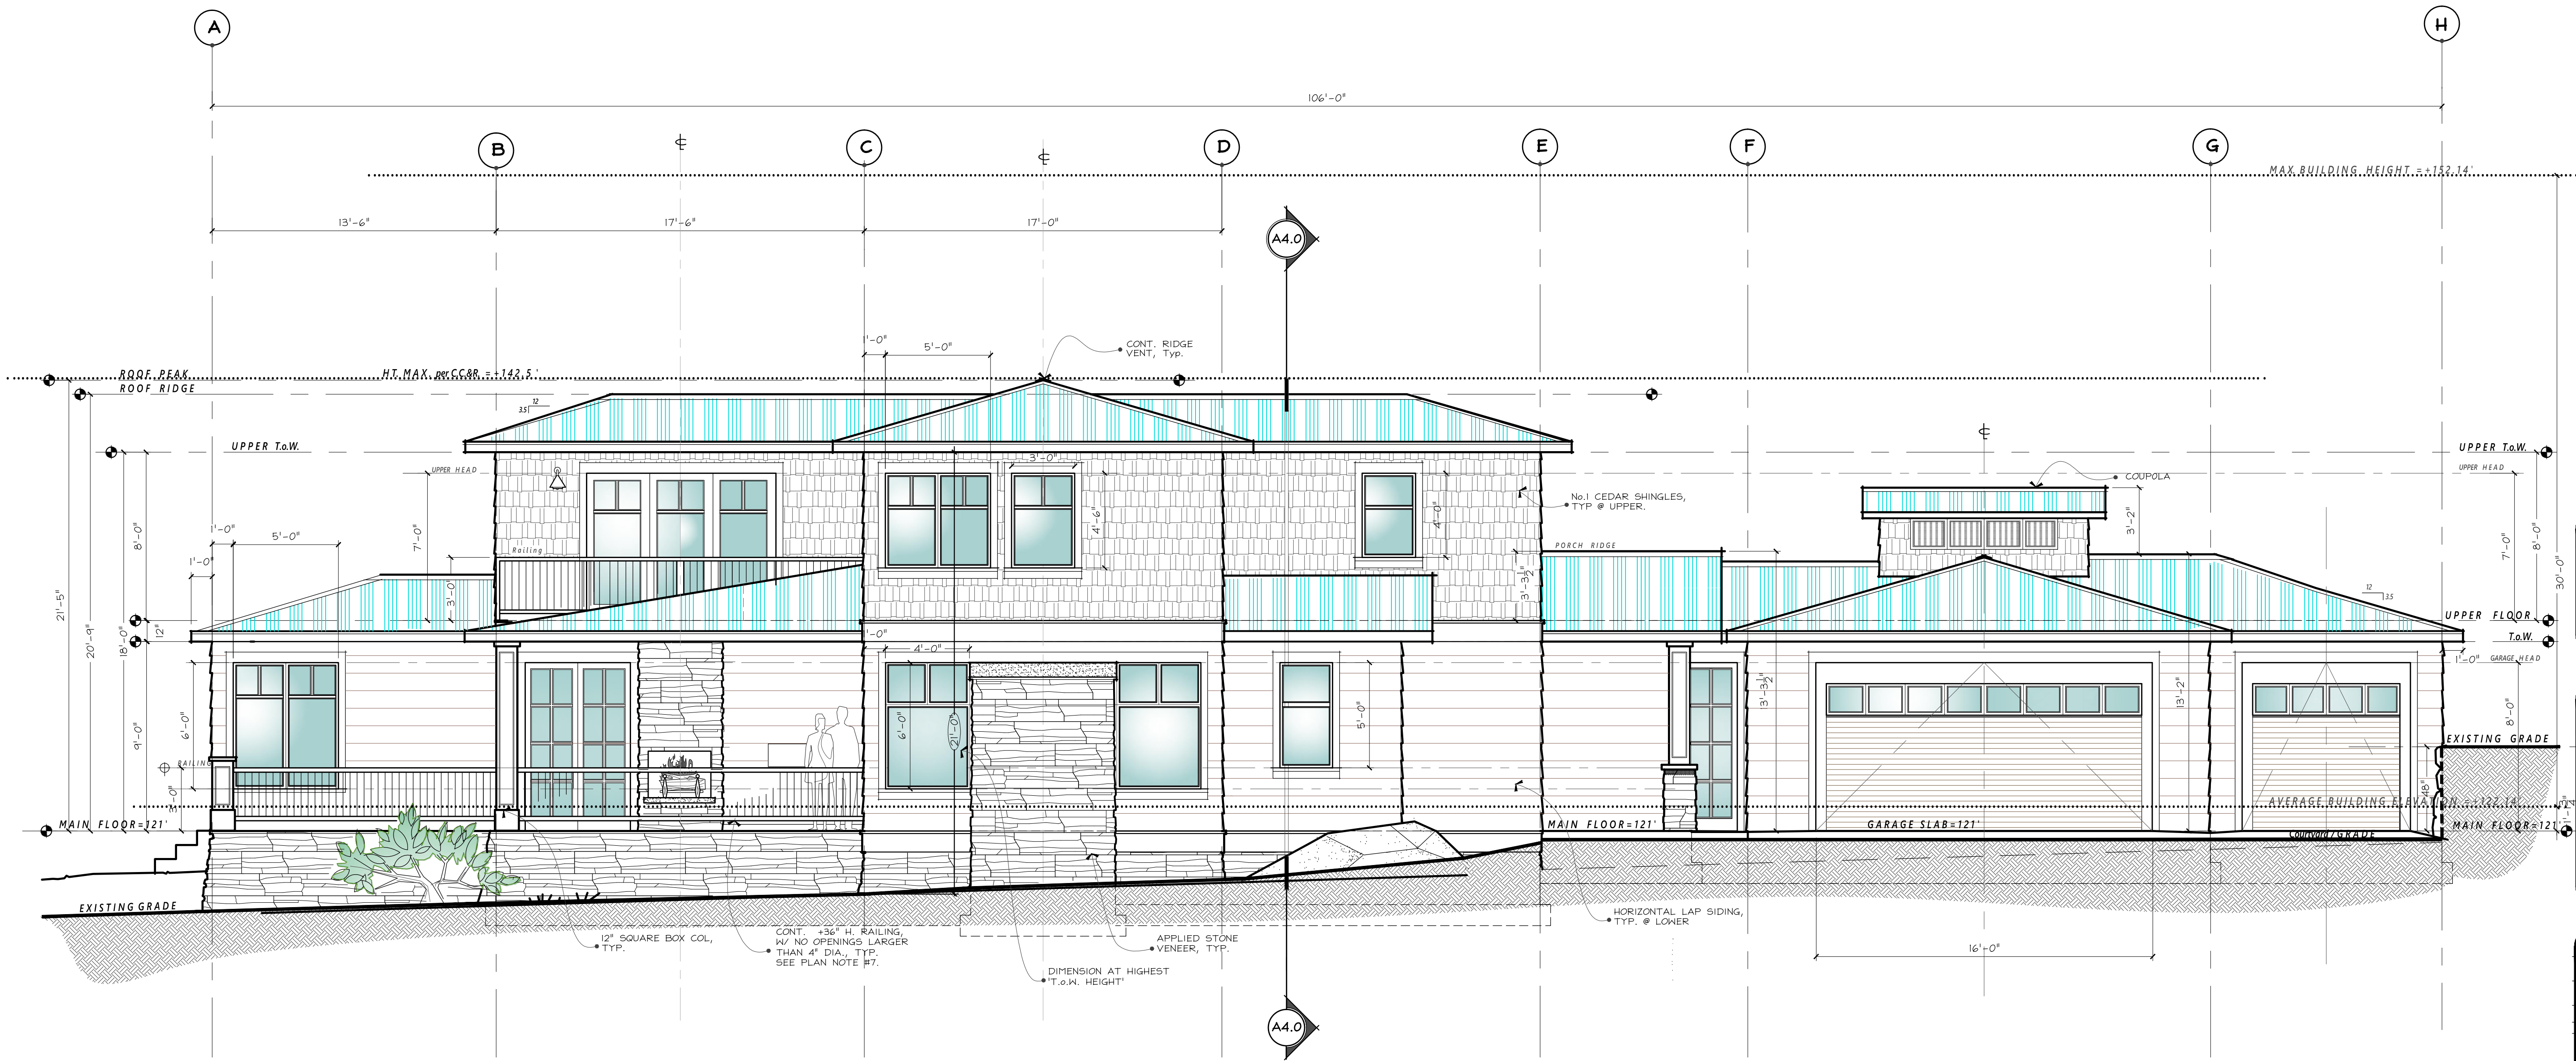

**SOUTH ELEVATION**

SCALE: 1/4" = 1'-0"

PROJECT NAME:	PROJECT ADDRESS:
<b>MARBELLA</b>	<b>7311 W. Mercer Way</b>
RESIDENCE	<b>-Mercer Is., WA 98040</b>

SET TITLE:	PERMIT SET
SHEET TITLE:	EXTERIOR ELEVATION


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4884

RICHARD A. FISHER  
STATE OF WASHINGTON

PROJECT #:	2010
DATE:	SEPT. 23, 2020
DRAWN BY:	N. F. W.
REVISIONS:	
Tag	Description

SHEET No.:	<b>A3.2</b>
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**NORTH ELEVATION**

SCALE: 1/4" = 1'-0"
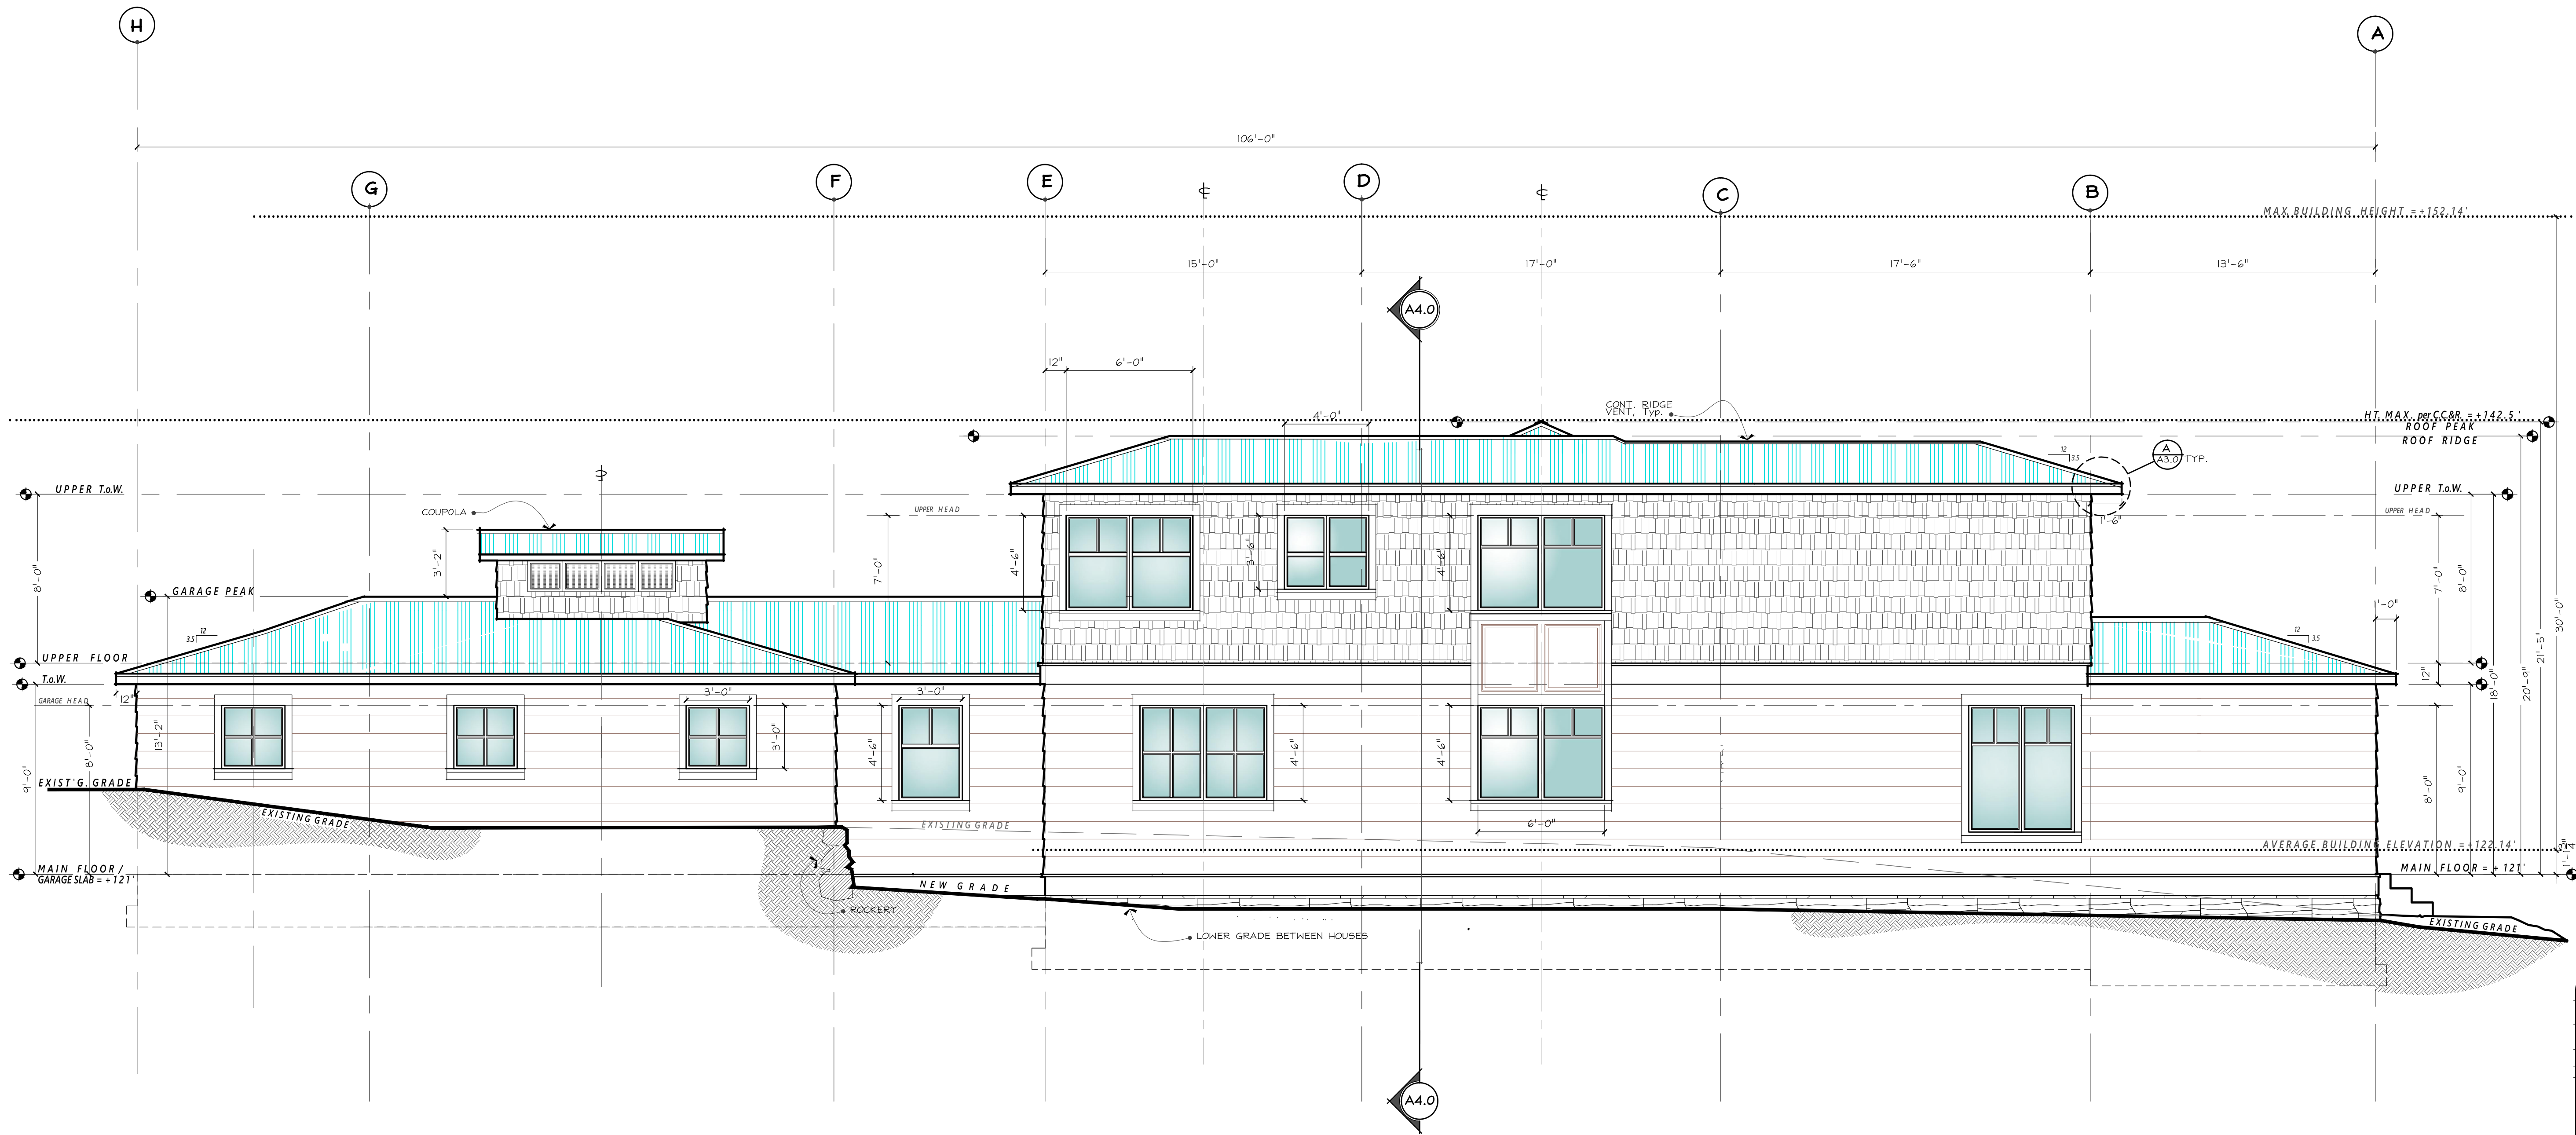
### LEGAL DESCRIPTION

(PER QUIT CLAIM DEED RECORDING #20090107000338)  
EXHIBIT B


PARCEL A:  
LOT 6, VILLA MARBELLA, ACCORDING TO THE PLAT RECORDED IN VOLUME 112 OF PLATS, PAGES 23 THROUGH 25, IN KING COUNTY, WASHINGTON; TOGETHER WITH AN UNDIVIDED ONE-SEVENTH INTEREST IN TRACT A OF SAID PLAT; TOGETHER WITH AN UNDIVIDED ONE-SEVENTH INTEREST IN TRACT B OF SAID PLAT; TOGETHER WITH AN UNDIVIDED ONE-SIXTH INTEREST IN TRACT C OF SAID PLAT, AND TOGETHER WITH AN UNDIVIDED INTEREST IN SECOND CLASS SHORELANDS ADJOINING SAID TRACT C.

PARCEL B:  
AN EASEMENT FOR INGRESS AND EGRESS ESTABLISHED UNDER KING COUNTY RECORDING NO. 7903130959, AND DESCRIBED AS FOLLOWS: THAT PORTION OF THE EAST 923.57 FEET OF THE NORTH 13.00 FEET OF THE SOUTH 114.00 FEET OF THE NORTH 945.50 FEET OF GOVERNMENT LOT 4, SECTION 25, TOWNSHIP 24 NORTH, RANGE 4 EAST, W.M., IN KING COUNTY, WASHINGTON, LYING WEST OF WEST MERCER WAY; THAT PORTION OF THE EAST 1,218.57 FEET OF THE NORTH 25.00 FEET OF THE SOUTH 114.00 FEET OF THE NORTH 945.50 FEET OF GOVERNMENT LOT 4, SECTION 25, TOWNSHIP 24, NORTH, RANGE 4 EAST, W.M., IN KING COUNTY, WASHINGTON; EXCEPT THE EAST 1,133.57 FEET THEREOF; THAT PORTION OF THE-EAST 1,368.57 FEET OF THE NORTH 5.00 FEET OF THE SOUTH 114.00 FEET OF THE NORTH 945.50 FEET OF GOVERNMENT LOT 4, SECTION 25, TOWNSHIP 24 NORTH, RANGE 4 EAST, W.M., IN KING COUNTY, WASHINGTON; EXCEPT THE EAST 1,263.57 FEET THEREOF.

# TOPOGRAPHIC & BOUNDARY SURVEY

### STEEP SLOPE/BUFFER DISCLAIMER:

THE LOCATION AND EXTENT OF STEEP SLOPES SHOWN ON THIS DRAWING ARE FOR INFORMATIONAL PURPOSES ONLY AND CANNOT BE RELIED ON FOR DESIGN AND/OR CONSTRUCTION. THE PITCH, LOCATION, AND EXTENT ARE BASED SOLELY ON OUR GENERAL OBSERVATIONS ON SITE AND OUR CURSORY REVIEW OF READILY AVAILABLE PUBLIC DOCUMENTS; AS SUCH, TERRANE CANNOT BE LIABLE OR RESPONSIBLE FOR THE ACCURACY OR COMPLETENESS OF ANY STEEP SLOPE INFORMATION. ULTIMATELY, THE LIMITS AND EXTENT OF ANY STEEP SLOPES ASSOCIATED WITH ANY SETBACKS OR OTHER DESIGN OR CONSTRUCTION PARAMETERS MUST BE DISCUSSED AND APPROVED BY THE REVIEWING AGENCY BEFORE ANY CONSTRUCTION CAN OCCUR.

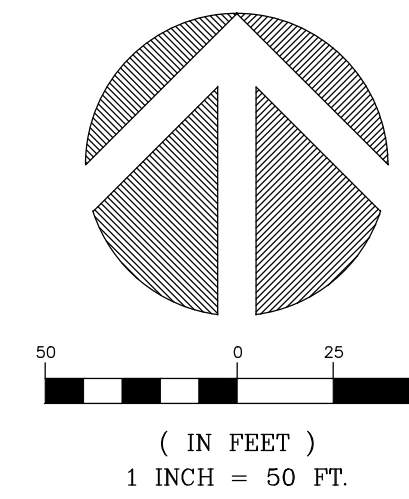

### LEGEND

MONUMENT IN CASE (FOUND)	OIL FILL CAP
AREA DRAIN	POST
ASPHALT SURFACE	WATER BLOWOFF
BOLLARD	POWER METER
BUILDING	POWER (OVERHEAD)
CLEANOUT	REBAR AS NOTED (FOUND)
CONCRETE SURFACE	REBAR & CAP (SET)
RETAINING WALL	ROCKERY
EASEMENT AREA	SEWER LINE
DECK	SEWER MANHOLE
FENCE LINE (WOOD)	STORM DRAIN LINE
GAS LINE	TREE (AS NOTED)
GRAVEL SURFACE	WATER LINE
HEDGE FOLIAGE LINE	HAND RAIL FENCE
INLET (TYPE 1)	WATER METER
IRON PIPE (FOUND)	WATER VALVE
AC UNIT	HOSE BIB RISER

### VICINITY MAP N.T.S.





# TOPOGRAPHIC & BOUNDARY SURVEY

## LEGEND

	MONUMENT IN CASE (FOUND)		OIL FILL CAP
	AREA DRAIN		POST
	ASPHALT SURFACE		WATER BLOWOFF
	BOLLARD		POWER METER
	BUILDING		POWER (OVERHEAD)
	CLEANOUT		REBAR AS NOTED (FOUND)
	CONCRETE SURFACE		REBAR & CAP (SET)
	RETAINING WALL		ROCKERY
	EASEMENT AREA		SEWER LINE
	DECK		SEWER MANHOLE
	FENCE LINE (WOOD)		STORM DRAIN LINE
	GAS LINE		TREE (AS NOTED)
	GRAVEL SURFACE		WATER LINE
	HEDGE FOLIAGE LINE		HAND RAIL FENCE
	INLET (TYPE 1)		WATER METER
	IRON PIPE (FOUND)		WATER VALVE
	AC UNIT		HOSE BIB RISER

## BASIS OF BEARINGS

A BEARING OF N 88°41'04" W BETWEEN FOUND MONUMENTS ON CENTERLINE OF 72ND ST PER R3 & R4.

## VERTICAL DATUM



NAVD88 PER CITY OF MERCER ISLAND BENCHMARK 3185 FOUND "3 1/2" BRASS CAP IN CONC (DN 1.0') STAMPED "WA COUNTY SURVEY MON W/ CHISLED " 50FT E. OF INTX SE 72ND ST & W. MERCER WAY. ELEVATION ON CAP = 175.374'

## REFERENCES

- R1. UNRECORDED PLAT OF SUNDOWN ESTATES & ASSOCIATED SURVEYS BY E.A. LAWVER CIRCA 1957.
- R2. VILLA MARBELLA, VOL. 112, PGS. 23-25, RECORDS OF KING COUNTY, WASHINGTON.
- R3. WILLIAMS SHORT PLAT, VOL. 79, PGS. 172, 172A & 172B, RECORDS OF KING COUNTY, WASHINGTON.
- R4. RECORD OF SURVEY, VOL. 139, PG. 91, RECORDS OF KING COUNTY, WASHINGTON.


## SURVEYOR'S NOTES

1. THE TOPOGRAPHIC SURVEY SHOWN HEREON WAS PERFORMED IN SEPTEMBER OF 2019. THE FIELD DATA WAS COLLECTED AND RECORDED ON MAGNETIC MEDIA THROUGH AN ELECTRONIC THEODOLITE. THE DATA FILE IS ARCHIVED ON DISC OR CD. WRITTEN FIELD NOTES MAY NOT EXIST. CONTOURS ARE SHOWN FOR CONVENIENCE ONLY. DESIGN SHOULD RELY ON SPOT ELEVATIONS.
2. ALL MONUMENTS SHOWN HEREON WERE LOCATED DURING THE COURSE OF THIS SURVEY UNLESS OTHERWISE NOTED.
3. THE TYPES AND LOCATIONS OF ANY UTILITIES SHOWN ON THIS DRAWING ARE BASED ON INFORMATION PROVIDED TO US, BY OTHERS OR GENERAL INFORMATION READILY AVAILABLE IN THE PUBLIC DOMAIN INCLUDING, AS APPLICABLE, IDENTIFYING MARKINGS PLACED BY UTILITY LOCATE SERVICES AND OBSERVED BY TERRANE IN THE FIELD. AS SUCH, THE UTILITY INFORMATION SHOWN ON THESE DRAWINGS ARE FOR INFORMATIONAL PURPOSES ONLY AND SHOULD NOT BE RELIED ON FOR DESIGN OR CONSTRUCTION PURPOSES; TERRANE IS NOT RESPONSIBLE OR LIABLE FOR THE ACCURACY OR COMPLETENESS OF THIS UTILITY INFORMATION. FOR THE ACCURATE LOCATION AND TYPE OF UTILITIES NECESSARY FOR DESIGN AND CONSTRUCTION, PLEASE CONTACT THE SITE OWNER AND THE LOCAL UTILITY LOCATE SERVICE (800-424-5555).
4. SUBJECT PROPERTY TAX PARCEL NO. 894422-0060.
5. SUBJECT PROPERTY UPLAND AREA PER THIS SURVEY IS 17,944 SF (0.41 ACRES)
6. THIS SURVEY WAS PERFORMED WITHOUT THE BENEFIT OF A TITLE REPORT. EASEMENTS AND OTHER ENCUMBRANCES MAY EXIST THAT ARE NOT SHOWN HEREON.
7. FIELD DATA FOR THIS SURVEY WAS OBTAINED BY DIRECT FIELD MEASUREMENTS WITH A CALIBRATED ELECTRONIC 5-SECOND TOTAL STATION AND/OR SURVEY GRADE GPS OBSERVATIONS. ALL ANGULAR AND LINEAR RELATIONSHIPS ARE ACCURATE AND MEET THE STANDARDS SET BY WAC 332-130-090.

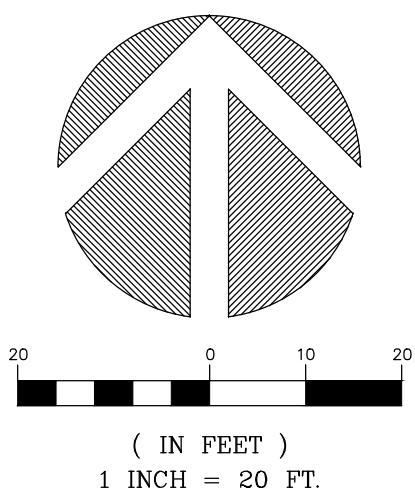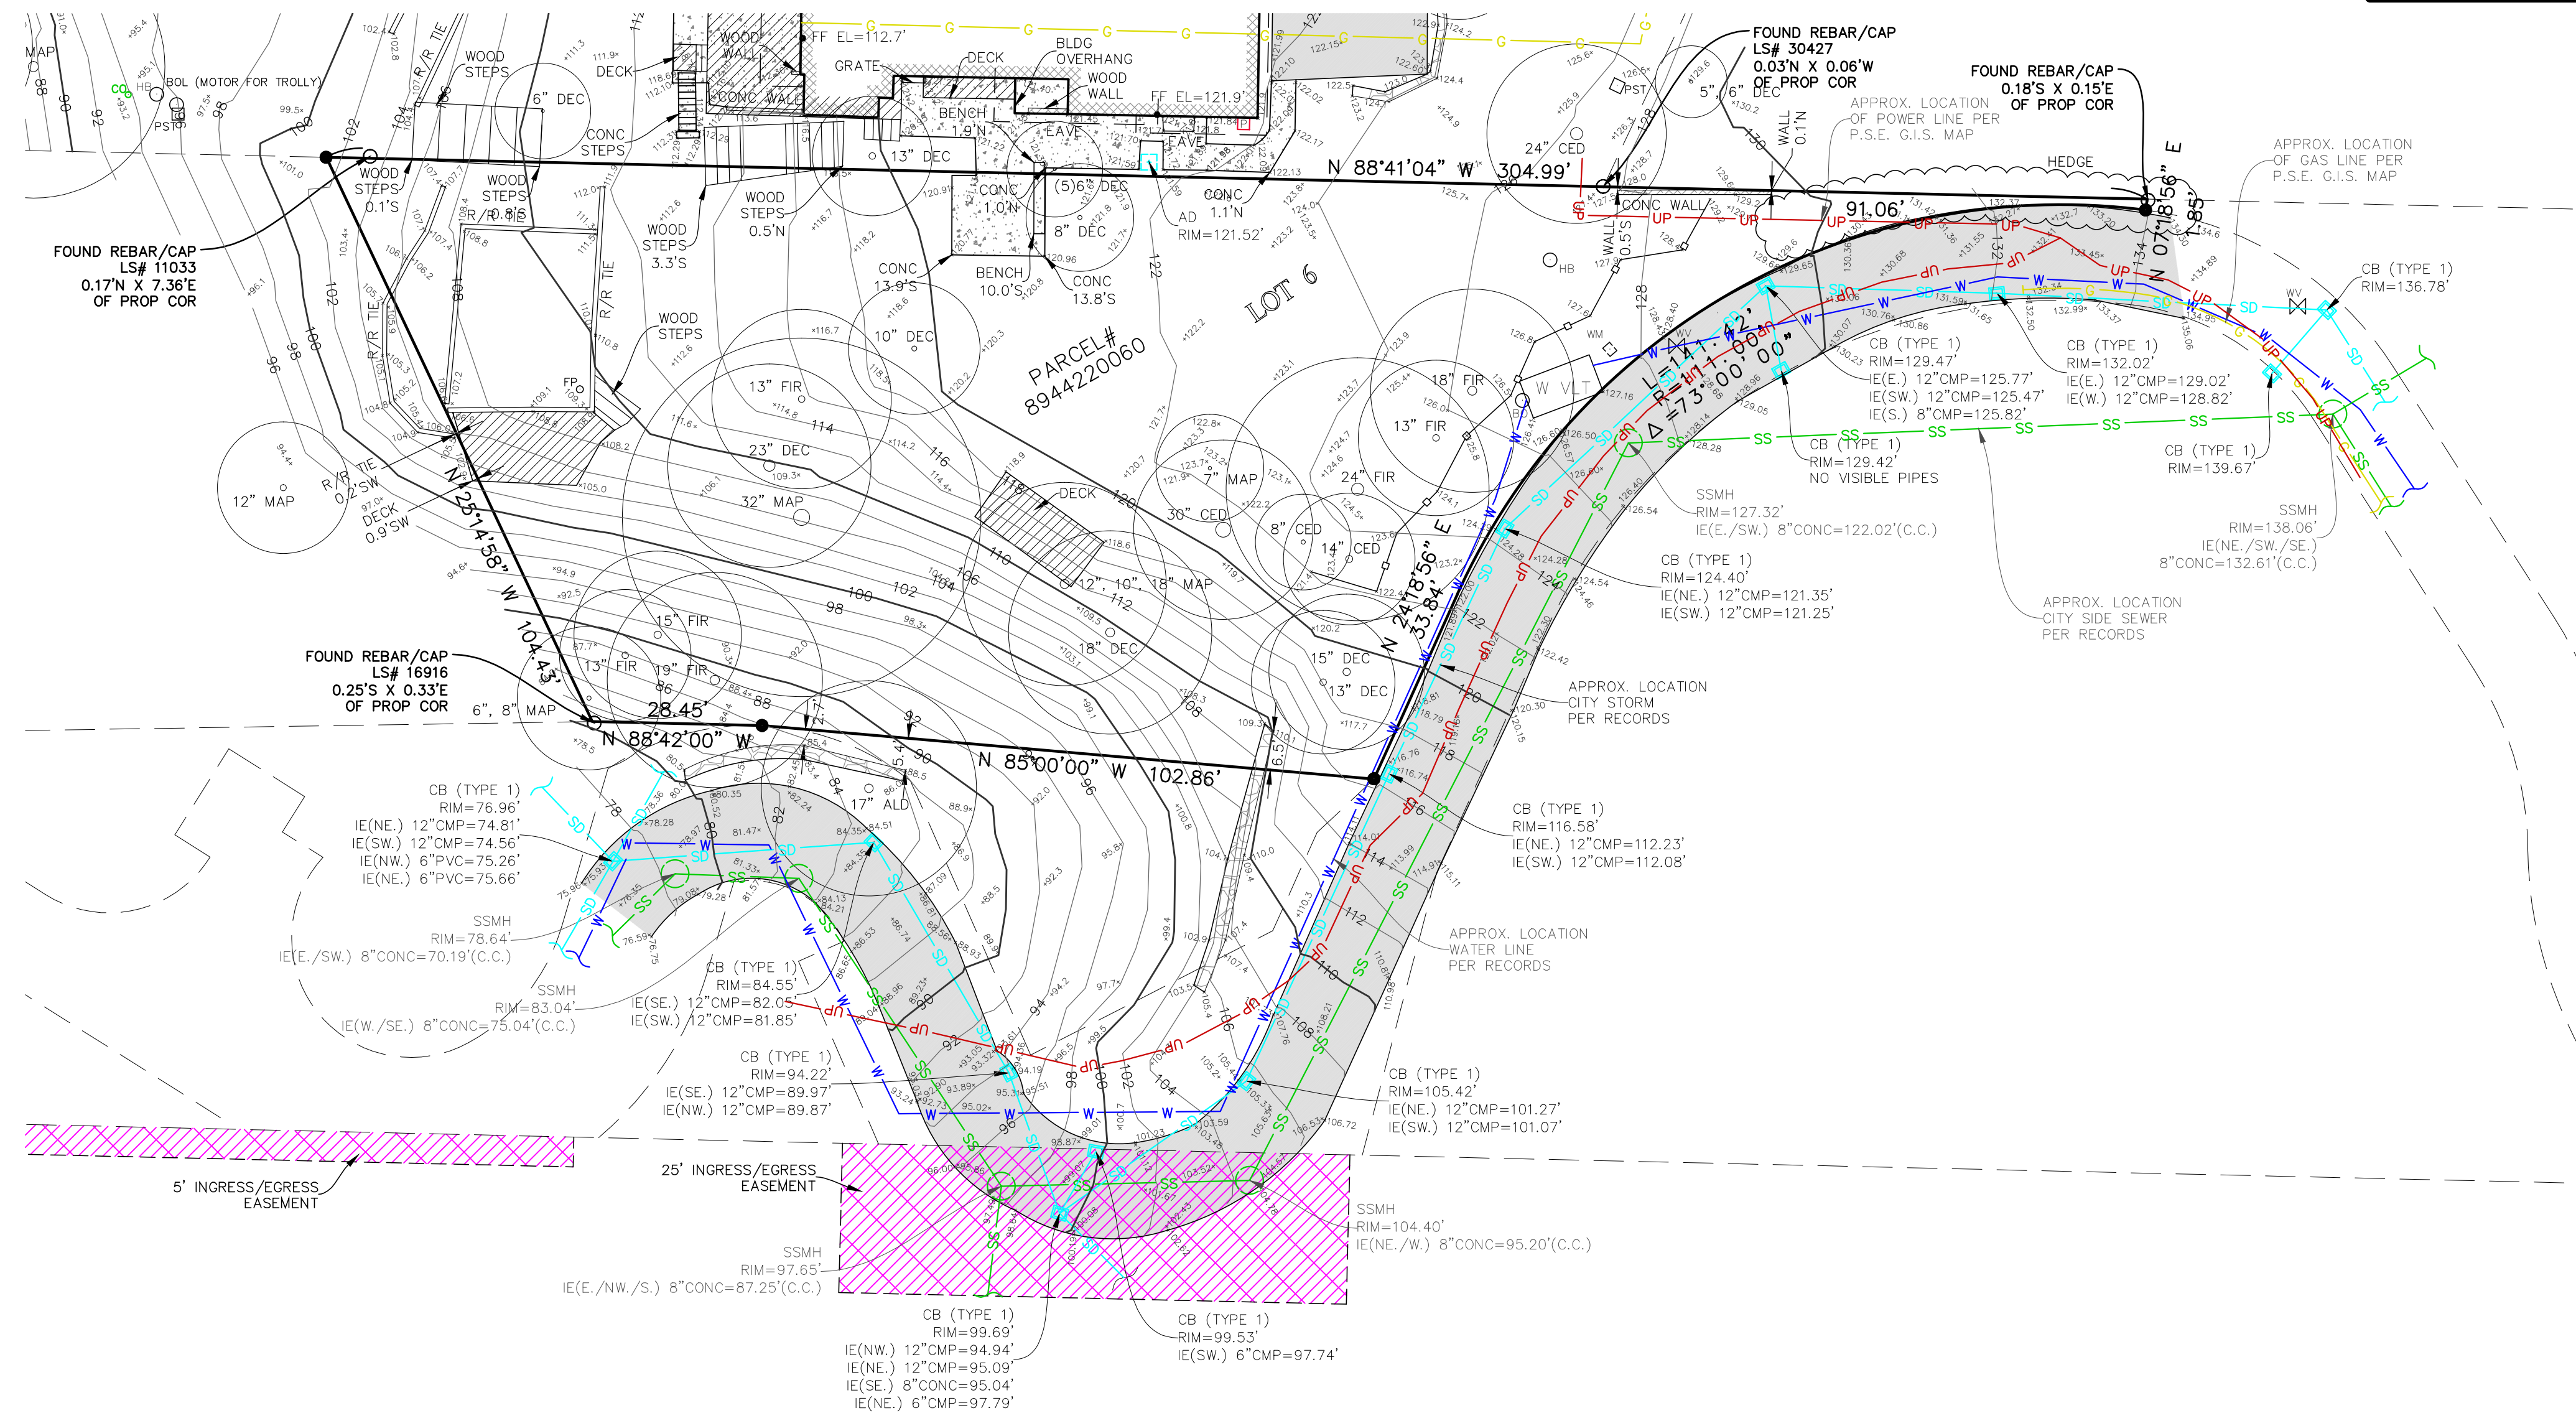

TOPOGRAPHIC & BOUNDARY SURVEY  
NE 1/4 OF NW1/4 SEC 25, TWP. 24N., RGE 04E., W.M.  
PARCEL NO. 894422-0060

7275 MERCER LLC  
W MERCER WAY  
MERCER ISLAND, WA 98040

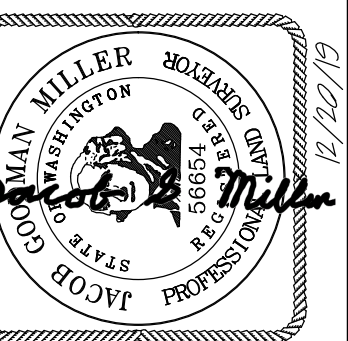

**Terrane**  
10801 Main Street, Suite 102, Bellevue, WA 98004  
phone 425.458.4488 support@terrane.net  
www.terrane.net

JOB NUMBER:	191480
DATE:	09/27/2019
DRAFTED BY:	RSN
CHECKED BY:	JGM
SCALE:	1" = 20'
REVISION HISTORY	
12/20/19	SEPARATE DRAWING
SHEET NUMBER	
2 OF 2	

measure success

**LEGAL DESCRIPTION**

SOURCE: SURVEY

(PER QUIT CLAIM DEED RECORDING #20090107000338) EXHIBIT B

PARCEL A:  
LOT 6, VILLA MARBELLA, ACCORDING TO THE PLAT RECORDED IN VOLUME 112 OF PLATS, PAGES 23 THROUGH 25, IN KING COUNTY, WASHINGTON; TOGETHER WITH AN UNDIVIDED ONE-SEVENTH INTEREST IN TRACT A OF SAID PLAT; TOGETHER WITH AN UNDIVIDED ONE-SEVENTH INTEREST IN TRACT B OF SAID PLAT; TOGETHER WITH AN UNDIVIDED ONE-SIXTH INTEREST IN TRACT C OF SAID PLAT; AND TOGETHER WITH AN UNDIVIDED INTEREST IN SECOND CLASS SHORELANDS ADJOINING SAID TRACT C.

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AN EASEMENT FOR INGRESS AND EGRESS ESTABLISHED UNDER KING COUNTY RECORDING NO. 7903130959, AND DESCRIBED AS FOLLOWS: THAT PORTION OF THE EAST 923.57 FEET OF THE NORTH 13.00 FEET OF THE SOUTH 114.00 FEET OF THE NORTH 945.50 FEET OF GOVERNMENT LOT 4, SECTION 25, TOWNSHIP 24 NORTH, RANGE 4 EAST, W.M., IN KING COUNTY, WASHINGTON, LYING WEST OF WEST MERCER WAY; THAT PORTION OF THE EAST 1,218.57 FEET OF THE NORTH 25.00 FEET OF THE SOUTH 114.00 FEET OF THE NORTH 945.50 FEET OF GOVERNMENT LOT 4, SECTION 25, TOWNSHIP 24 NORTH, RANGE 4 EAST, W.M., IN KING COUNTY, WASHINGTON; EXCEPT THE EAST 1,133.57 FEET THEREOF; THAT PORTION OF THE EAST 1,368.57 FEET OF THE NORTH 5.00 FEET OF THE SOUTH 114.00 FEET OF THE NORTH 945.50 FEET OF GOVERNMENT LOT 4, SECTION 25, TOWNSHIP 24 NORTH, RANGE 4 EAST, W.M., IN KING COUNTY, WASHINGTON; EXCEPT THE EAST 1,263.57 FEET THEREOF.

**EROSION CONTROL NOTES**



SHEET C1.2

**EROSION CONTROL DETAILS**

SHEET C1.2

**EROSION CONTROL LEGEND**

- FILTER FABRIC FENCE (SILT FENCE) (SF)
  - STABILIZED CONSTRUCTION ENTRANCE (CE)
  - CATCH BASIN INLET PROTECTION (IP)
  - INTERCEPTOR SWALE SEE COR DWG 504, TYPE A TEMPORARY SWALE (IS)
  - TREE PROTECTION FENCING (TP)
  - STOCKPILE (ST)
  - STRAW WATTLES (SW)
  - PLASTIC COVERING (PC)
  - COMPOST SOCK (CS)
  - COMPOST BERM (CB)
- USE AS NEEDED
- COVER EXPOSED AREAS WITHIN MERCER ISLAND TIME LIMIT
  - SEDIMENT CONTROL OPTION RECOMMENDED IN LIEU OF SILT FENCE
  - SEDIMENT CONTROL OPTION RECOMMENDED IN LIEU OF SILT FENCE

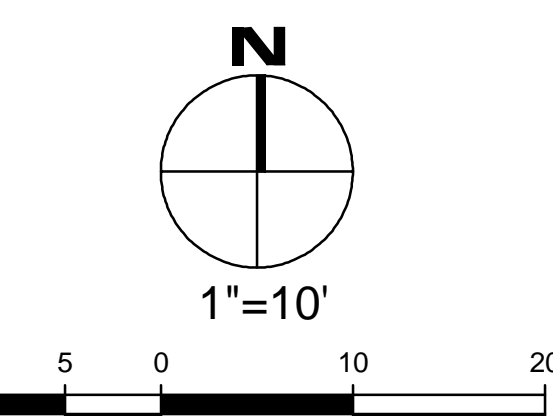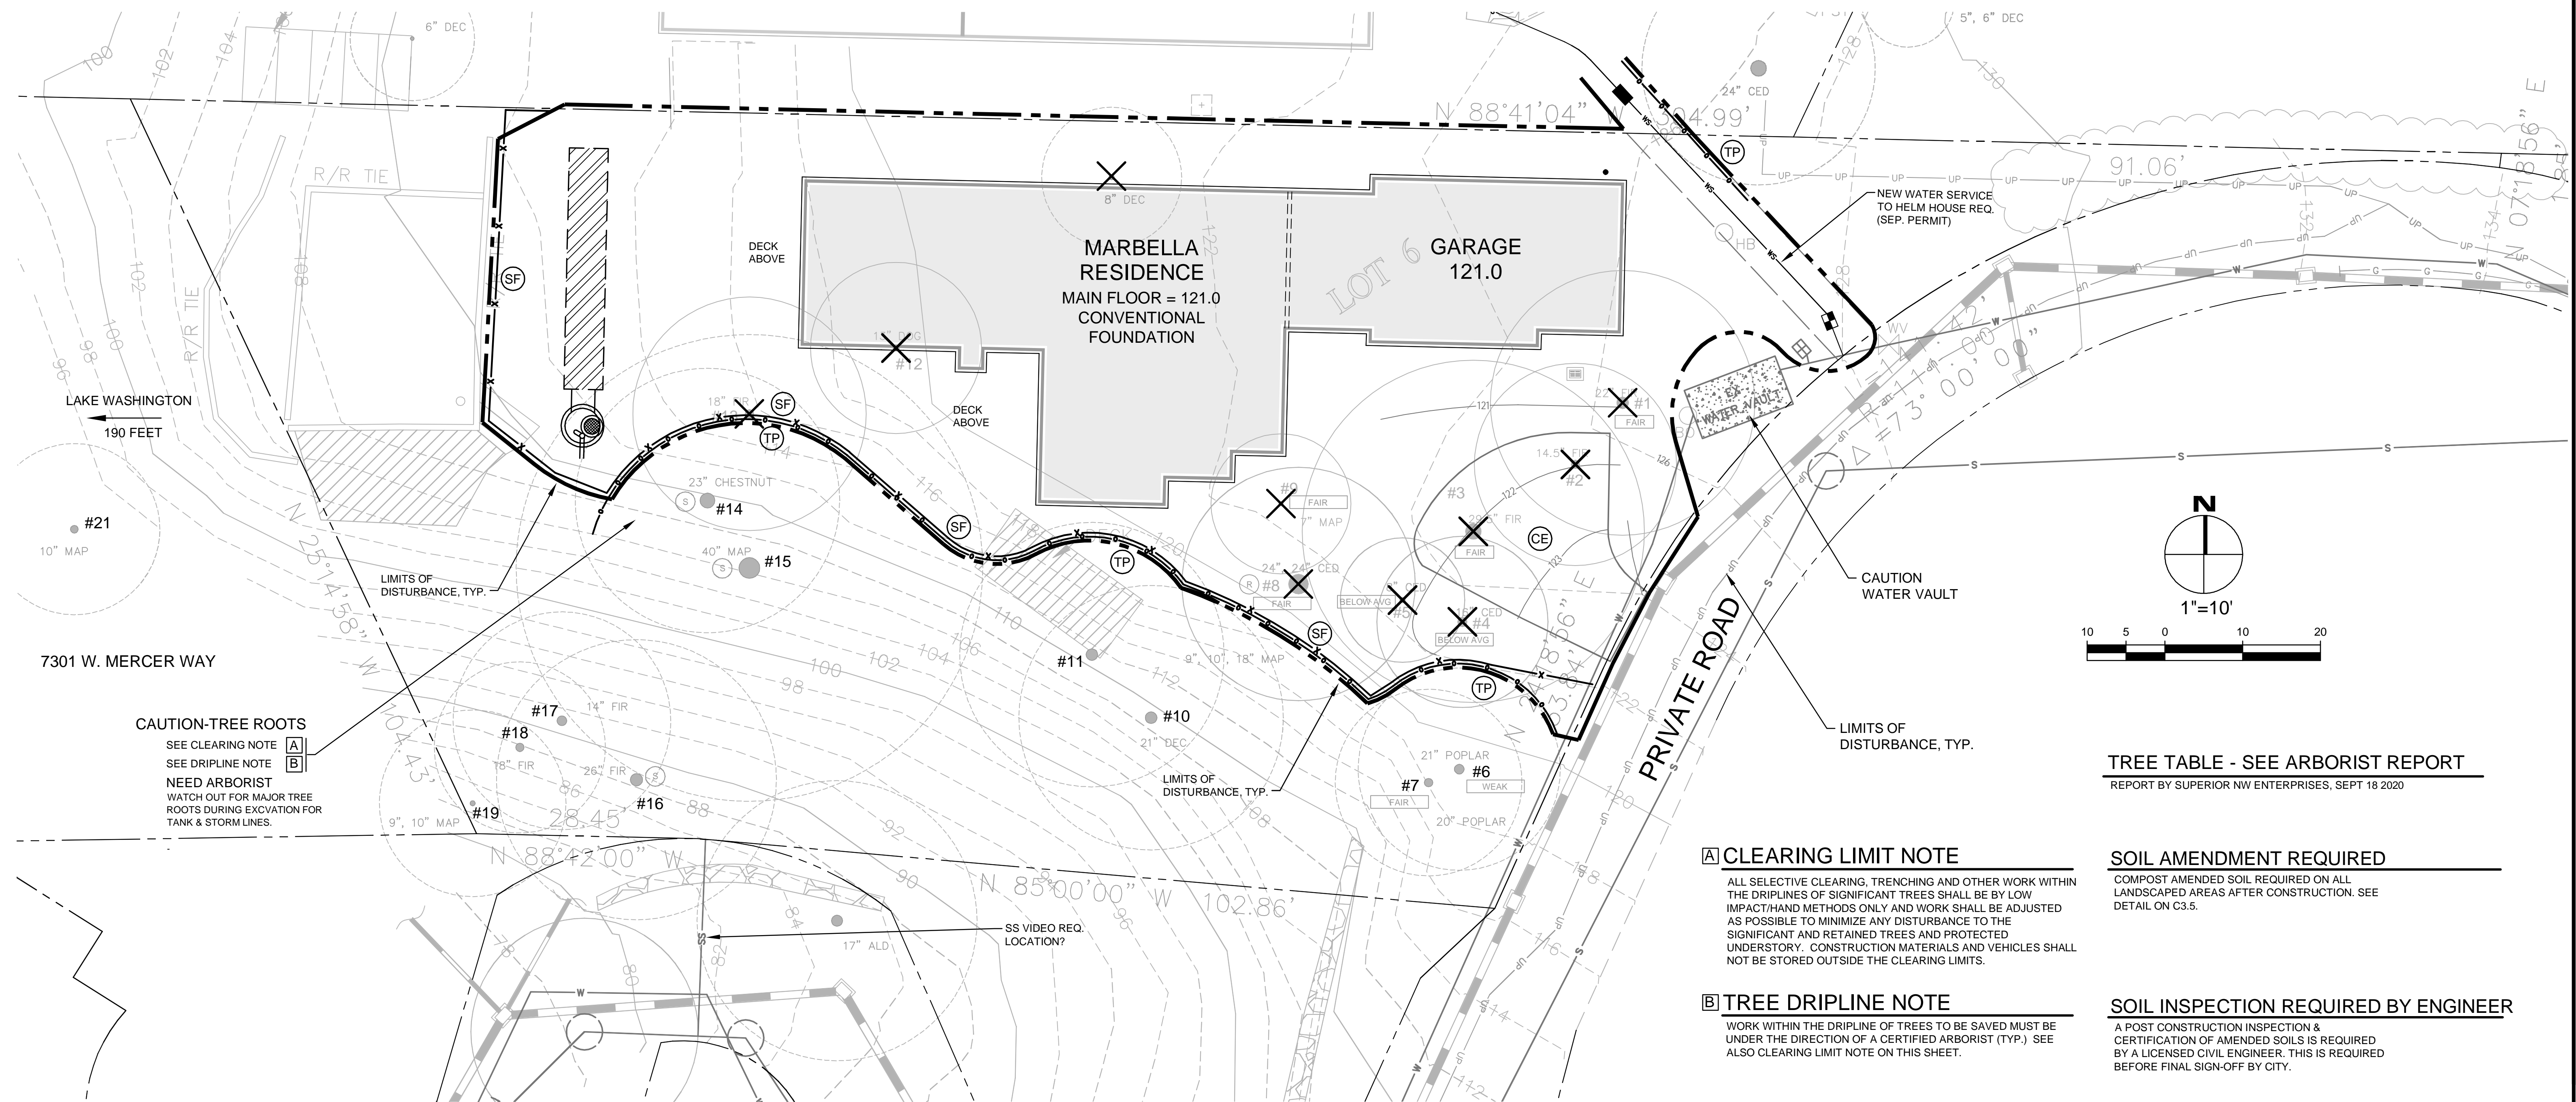

**TREE TABLE - SEE ARBORIST REPORT**  
REPORT BY SUPERIOR NW ENTERPRISES, SEPT 18 2020

**[A] CLEARING LIMIT NOTE**

ALL SELECTIVE CLEARING, TRENCHING AND OTHER WORK WITHIN THE DRIPLINES OF SIGNIFICANT TREES SHALL BE BY LOW IMPACT/HAND METHODS ONLY AND WORK SHALL BE ADJUSTED AS POSSIBLE TO MINIMIZE ANY DISTURBANCE TO THE SIGNIFICANT AND RETAINED TREES AND PROTECTED UNDERSTORY. CONSTRUCTION MATERIALS AND VEHICLES SHALL NOT BE STORED OUTSIDE THE CLEARING LIMITS.

**[B] TREE DRIPLINE NOTE**

WORK WITHIN THE DRIPLINE OF TREES TO BE SAVED MUST BE UNDER THE DIRECTION OF A CERTIFIED ARBORIST (TYP.) SEE ALSO CLEARING LIMIT NOTE ON THIS SHEET.

**SOIL AMENDMENT REQUIRED**

COMPOST AMENDED SOIL REQUIRED ON ALL LANDSCAPED AREAS AFTER CONSTRUCTION. SEE DETAIL ON C3.5.

**SOIL INSPECTION REQUIRED BY ENGINEER**


A POST CONSTRUCTION INSPECTION & CERTIFICATION OF AMENDED SOILS IS REQUIRED BY A LICENSED CIVIL ENGINEER. THIS IS REQUIRED BEFORE FINAL SIGN-OFF BY CITY.

NO.	DATE	BY	REVISIONS

APPLICANT:  
MASON HELMS  
JASON KOEHLER



DATE: September 14, 2020  
JOB# 1896-2  
DRAFTED: CH DESIGN: DE  
DIGITAL SIGNATURE

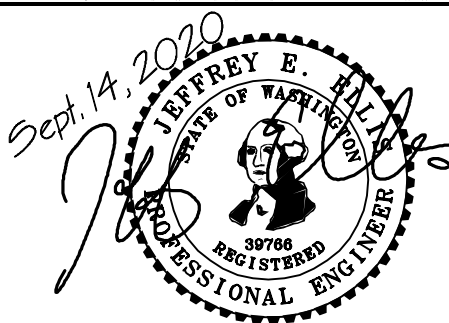

**CIVIL ENGINEERING SOLUTIONS**

102 NW CANAL STREET SEATTLE, WA 98107  
PHONE: 206.930.0342 DUFFY@CESOLUTIONS.US

**EROSION CONTROL PLAN**


MARBELLA RESIDENCE  
7311 W. MERCER WAY, MERCER ISLAND, WA 98040

DRAWING NO:  
**C1.0**  
APN 894422-0060

**SILT FENCE DETAIL**

DOE

Figure II-3.22: Silt Fence

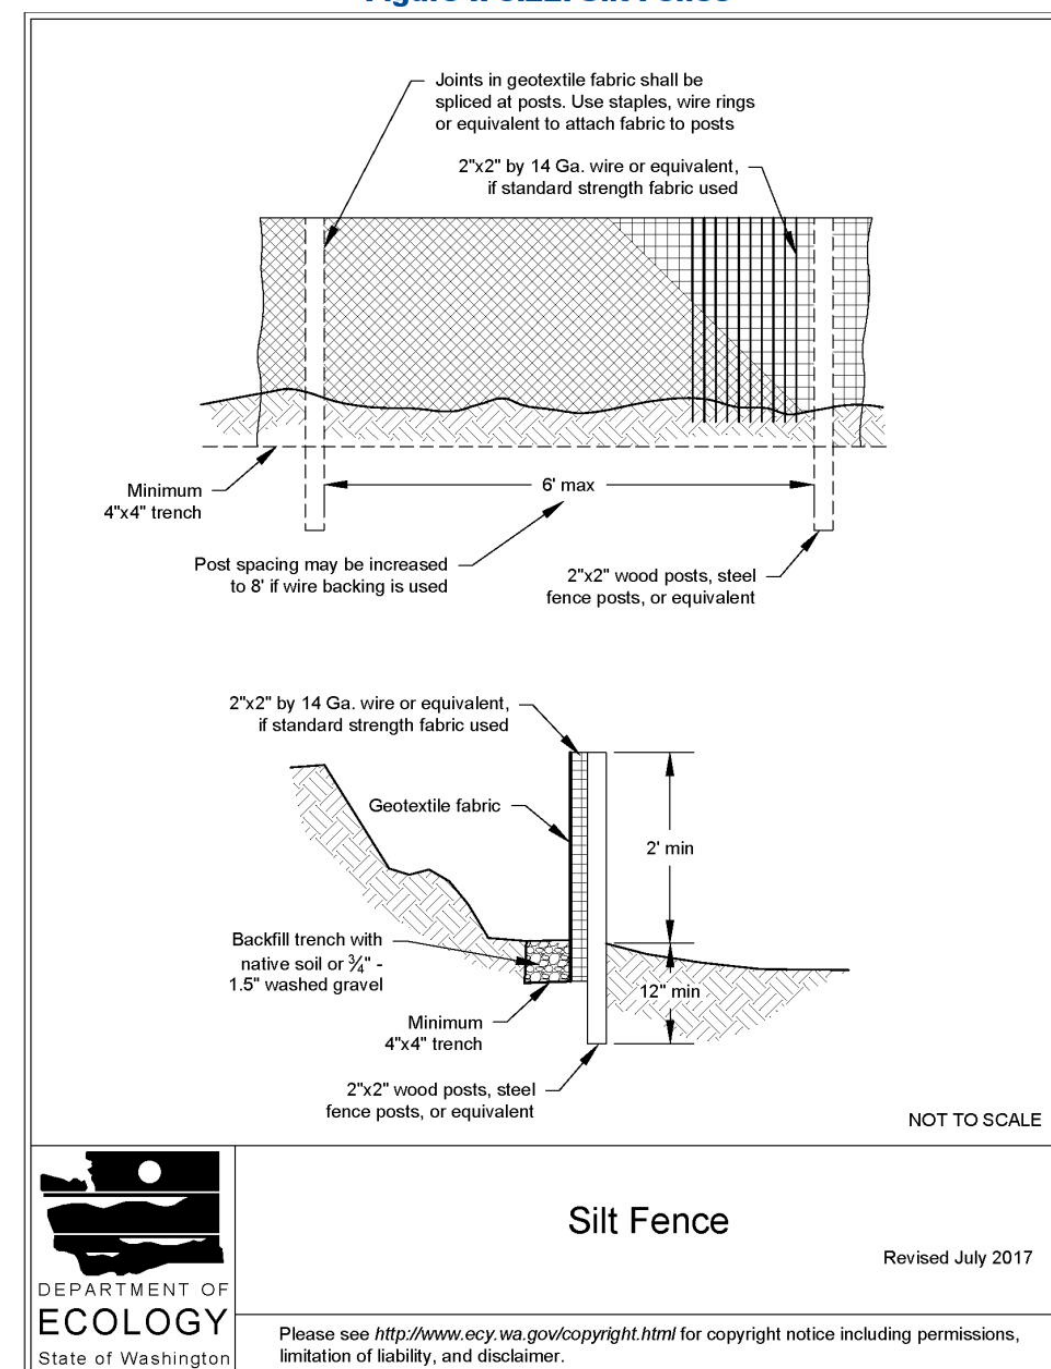

Silt Fence

Revised July 2017

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**RECOMMENDED CONSTRUCTION SEQUENCE**

A DETAILED CONSTRUCTION SEQUENCE IS NEEDED TO ENSURE THAT EROSION AND SEDIMENT CONTROL MEASURES ARE APPLIED AT THE APPROPRIATE TIMES. A RECOMMENDED CONSTRUCTION SEQUENCE IS PROVIDED BELOW:

- HOLD AN ONSITE PRE-CONSTRUCTION MEETING.
- POST SIGN WITH NAME AND PHONE NUMBER OF ESC SUPERVISOR (MAY BE CONSOLIDATED WITH THE REQUIRED NOTICE OF CONSTRUCTION SIGN).
- FLAG OR FENCE CLEARING LIMITS.
- INSTALL CATCH BASIN PROTECTION, IF REQUIRED.
- GRADE AND INSTALL CONSTRUCTION ENTRANCE(S).
- INSTALL PERIMETER PROTECTION (SILT FENCE, BRUSH BARRIER, ETC.).
- CONSTRUCT SEDIMENT PONDS AND TRAPS.
- GRADE AND STABILIZE CONSTRUCTION ROADS.
- CONSTRUCT SURFACE WATER CONTROLS (INTERCEPTOR DIKES, PIPE SLOPE DRAINS, ETC.) SIMULTANEOUSLY WITH CLEARING AND GRADING FOR PROJECT DEVELOPMENT.
- MAINTAIN EROSION CONTROL MEASURES IN ACCORDANCE WITH CITY OF MERCER ISLAND STANDARDS AND MANUFACTURER'S RECOMMENDATIONS.
- RELOCATE SURFACE WATER CONTROLS OR TESC MEASURES, OR INSTALL NEW MEASURES SO THAT AS SITE CONDITIONS CHANGE, THE TESC IS ALWAYS IN ACCORDANCE WITH CITY OF MERCER ISLAND TESC REQUIREMENTS.
- COVER ALL AREAS THAT WILL BE UN-WORKED FOR MORE THAN SEVEN DAYS DURING THE DRY SEASON (MAY 1 TO SEPT 30) OR TWO DAYS DURING THE WET SEASON (OCT 1 TO APRIL 30) WITH STRAW, WOOD FIBER MULCH, COMPOST, PLASTIC SHEETING, OR EQUIVALENT.
- STABILIZE ALL AREAS WITHIN SEVEN DAYS OF REACHING FINAL GRADE.
- SEED, SOD, STABILIZE, OR COVER ANY AREAS TO REMAIN UNWORKED FOR MORE THAN 30 DAYS.
- UPON COMPLETION OF THE PROJECT, STABILIZE ALL DISTURBED AREAS AND REMOVE BMPS IF APPROPRIATE.

**EROSION CONTROL NOTES**

- D.8.2 STANDARD ESC PLAN NOTES  
THE STANDARD ESC PLAN NOTES MUST BE INCLUDED ON ALL ESC PLANS. AT THE APPLICANT'S DISCRETION, NOTES THAT IN NO WAY APPLY TO THE PROJECT MAY BE OMITTED; HOWEVER, THE REMAINING NOTES MUST NOT BE RENUMBERED. FOR EXAMPLE, IF ESC NOTE #3 WERE OMITTED, THE REMAINING NOTES SHOULD BE NUMBERED 1, 2, 4, 5, 6, ETC.
- APPROVAL OF THIS EROSION AND SEDIMENTATION CONTROL (ESC) PLAN DOES NOT CONSTITUTE AN APPROVAL OF PERMANENT ROAD OR DRAINAGE DESIGN (E.G., SIZE AND LOCATION OF ROADS, PIPES, RESTRICTORS, CHANNELS, RETENTION FACILITIES, UTILITIES, ETC.).
  - THE IMPLEMENTATION OF THESE ESC PLANS AND THE CONSTRUCTION, MAINTENANCE, REPLACEMENT, AND UPGRADING OF THESE ESC FACILITIES IS THE RESPONSIBILITY OF THE APPLICANT/ESC SUPERVISOR UNTIL ALL CONSTRUCTION IS APPROVED.
  - THE BOUNDARIES OF THE CLEARING LIMITS SHOWN ON THIS PLAN SHALL BE CLEARLY FLAGGED BY SURVEY TAPE OR FENCING, IF REQUIRED, PRIOR TO CONSTRUCTION (SWDM APPENDIX D). DURING THE CONSTRUCTION PERIOD, NO DISTURBANCE BEYOND THE CLEARING LIMITS SHALL BE PERMITTED. THE CLEARING LIMITS SHALL BE MAINTAINED BY THE APPLICANT/ESC SUPERVISOR FOR THE DURATION OF CONSTRUCTION.
  - STABILIZED CONSTRUCTION ENTRANCES SHALL BE INSTALLED AT THE BEGINNING OF CONSTRUCTION AND MAINTAINED FOR THE DURATION OF THE PROJECT. ADDITIONAL MEASURES, SUCH AS CONSTRUCTED WHEEL WASH SYSTEMS OR WASH PADS, MAY BE REQUIRED TO ENSURE THAT ALL PAVED AREAS ARE KEPT CLEAN AND TRACK OUT TO ROAD RIGHT OF WAY DOES NOT OCCUR FOR THE DURATION OF THE PROJECT.
  - THE ESC FACILITIES SHOWN ON THIS PLAN MUST BE CONSTRUCTED PRIOR TO OR IN CONJUNCTION WITH ALL CLEARING AND GRADING SO AS TO ENSURE THAT THE TRANSPORT OF SEDIMENT TO SURFACE WATERS, DRAINAGE SYSTEMS, AND ADJACENT PROPERTIES IS MINIMIZED.
  - THE ESC FACILITIES SHOWN ON THIS PLAN ARE THE MINIMUM REQUIREMENTS FOR ANTICIPATED SITE CONDITIONS. DURING THE CONSTRUCTION PERIOD, THESE ESC FACILITIES SHALL BE UPGRADED AS NEEDED FOR UNEXPECTED STORM EVENTS AND MODIFIED TO ACCOUNT FOR CHANGING SITE CONDITIONS (E.G. ADDITIONAL COVER MEASURES, ADDITIONAL SUMP PUMPS, RELOCATION OF DITCHES AND SILT FENCES, PERIMETER PROTECTION ETC.) AS DIRECTED BY CITY OF MERCER ISLAND.
  - THE ESC FACILITIES SHALL BE INSPECTED DAILY BY THE APPLICANT/ESC SUPERVISOR AND MAINTAINED TO ENSURE CONTINUED PROPER FUNCTIONING. WRITTEN RECORDS SHALL BE KEPT OF WEEKLY REVIEWS OF THE ESC FACILITIES.
  - ANY AREAS OF EXPOSED SOILS, INCLUDING ROADWAY EMBANKMENTS, THAT WILL NOT BE DISTURBED FOR TWO CONSECUTIVE DAYS DURING THE WET SEASON OR SEVEN DAYS DURING THE DRY SEASON SHALL BE IMMEDIATELY STABILIZED WITH THE APPROVED ESC METHODS (E.G., SEEDING, MULCHING, PLASTIC COVERING, ETC.).
  - ANY AREA NEEDING ESC MEASURES THAT DO NOT REQUIRE IMMEDIATE ATTENTION SHALL BE ADDRESSED WITHIN SEVEN (7) DAYS.
  - THE ESC FACILITIES ON INACTIVE SITES SHALL BE INSPECTED AND MAINTAINED A MINIMUM OF ONCE A MONTH DURING THE DRY SEASON, BI-MONTHLY DURING THE WET SEASON, OR WITHIN TWENTY FOUR (24) HOURS FOLLOWING A STORM EVENT.
  - AT NO TIME SHALL MORE THAN ONE (1) FOOT OF SEDIMENT BE ALLOWED TO ACCUMULATE WITHIN A CATCH BASIN. ALL CATCH BASINS AND CONVEYANCE LINES SHALL BE CLEANED PRIOR TO PAVING. THE CLEANING OPERATION SHALL NOT FLUSH SEDIMENT-LADEN WATER INTO THE DOWNSTREAM SYSTEM.
  - ANY PERMANENT RETENTION/DETENTION FACILITY USED AS A TEMPORARY SETTLING BASIN SHALL BE MODIFIED WITH THE NECESSARY EROSION CONTROL MEASURES AND SHALL PROVIDE ADEQUATE STORAGE CAPACITY. IF THE FACILITY IS TO FUNCTION ULTIMATELY AS AN INFILTRATION SYSTEM, THE TEMPORARY FACILITY MUST BE ROUGH GRADED SO THAT THE BOTTOM AND SIDES ARE AT LEAST THREE FEET ABOVE THE FINAL GRADE OF THE PERMANENT FACILITY.
  - COVER MEASURES WILL BE APPLIED IN CONFORMANCE WITH APPENDIX D OF THE SURFACE WATER DESIGN MANUAL.
  - PRIOR TO THE BEGINNING OF THE WET SEASON (OCT. 1), ALL DISTURBED AREAS SHALL BE REVIEWED TO IDENTIFY WHICH ONES CAN BE SEEDED IN PREPARATION FOR THE WINTER RAINS. DISTURBED AREAS SHALL BE SEEDED WITHIN ONE WEEK OF THE BEGINNING OF THE WET SEASON.


**CITY NOTES**

- ANY CHANGES TO THE APPROVED PLANS REQUIRES CITY APPROVAL THROUGH A REVISION.
- APPLICANT IS RESPONSIBLE FOR ANY DAMAGES TO UNDERGROUND UTILITIES CAUSED FROM THIS CONSTRUCTION.
- CATCH BASIN FILTERS SHOULD BE PROVIDED FOR ALL STORM DRAIN CATCH BASINS/INLETS DOWNSLOPE AND WITHIN 500 FEET OF THE CONSTRUCTION AREA. CATCH BASIN FILTERS SHOULD BE DESIGNED BY THE MANUFACTURER FOR USE AT CONSTRUCTION SITES AND APPROVED BY THE CITY INSPECTOR. CATCH BASIN FILTERS SHOULD BE INSPECTED FREQUENTLY, ESPECIALLY AFTER STORM EVENTS. IF THE FILTER BECOMES CLOGGED, IT SHOULD BE CLEANED OR REPLACED.
- CONTRACTORS SHALL VERIFY LOCATIONS AND DEPTHS OF UTILITIES.
- AT LEAST 48 HOURS PRIOR TO CONSTRUCTION, CALL 'ONE CALL' AT 1.800.424.5555
- DO NOT BACKFILL WITH NATIVE MATERIAL ON PUBLIC RIGHT-OF-WAY. ALL MATERIAL MUST BE IMPORTED
- EROSION CONTROL: ALL "LAND DISTURBING ACTIVITY" IS SUBJECT TO PROVISIONS OF MERCER ISLAND ORDINANCE 95C-118 "STORM WATER MANAGEMENT." SPECIFIC ITEMS TO BE FOLLOWED AT YOUR SITE:
- PROTECT ADJACENT PROPERTIES FROM ANY INCREASED RUNOFF OR SEDIMENTATION DUE TO THE CONSTRUCTION PROJECT THROUGH THE USE OF APPROPRIATE "BEST MANAGEMENT PRACTICES" (BMP) EXAMPLES INCLUDE, BUT ARE NOT LIMITED TO, SEDIMENT TRAPS, SEDIMENT PONDS, FILTER FABRIC FENCES, VEGETATIVE BUFFER STRIPS OR BIOENGINEERED SWALES.
- CONSTRUCTION ACCESS TO THE SITE SHOULD BE LIMITED TO ONE ROUTE. STABILIZE ENTRANCE WITH QUARRY SPALLS TO PREVENT SEDIMENT FROM LEAVING THE SITE OR ENTERING THE STORM DRAINS.
- PREVENT SEDIMENT, CONSTRUCTION DEBRIS, PAINTS, SOLVENTS, ETC., OR OTHER TYPES OF POLLUTION FROM ENTERING PUBLIC STORM DRAINS. KEEP ALL POLLUTION ON YOUR SITE.
- ALL EXPOSED SOILS SHALL REMAIN DENUDED FOR NO LONGER THAN SEVEN (7) DAYS AND SHALL BE STABILIZED WITH MULCH, HAY, OR THE APPROPRIATE GROUND COVER. ALL EXPOSED SOILS SHALL BE COVERED IMMEDIATELY DURING ANY RAIN EVENT.
- INSTALLATION OF CONCRETE DRIVEWAYS, TREES, SHRUBS, IRRIGATION, BOLLERS, BERMS, WALLS, GATES, AND OTHER IMPROVEMENTS ARE NOT ALLOWED IN THE PUBLIC RIGHT-OF-WAY WITHOUT PRIOR APPROVAL, AND AN ENCROACHMENT AGREEMENT AND RIGHT OF WAY PERMIT FROM THE SENIOR DEVELOPMENT ENGINEER.
- OWNER SHALL CONTROL DISCHARGE OF SURFACE DRAINAGE RUNOFF FROM EXISTING AND NEW IMPERVIOUS AREAS IN A RESPONSIBLE MANNER. CONSTRUCTION OF NEW GUTTERS AND DOWNSPOUTS, DRY WELLS, LEVEL SPREADERS OR DOWNSTREAM CONVEYANCE PIPE MAY BE NECESSARY TO MINIMIZE DRAINAGE IMPACT TO YOUR NEIGHBORS. CONSTRUCTION OF MINIMUM DRAINAGE IMPROVEMENTS SHOWN OR CALLED OUT ON THIS PLAN DOES NOT IMPLY RELIEF FROM CIVIL LIABILITY FOR YOUR DOWNSTREAM DRAINAGE.
- POT HOLING THE PUBLIC UTILITIES IS REQUIRED PRIOR TO ANY GRADING ACTIVITIES LESS THAN 6" OVER THE PUBLIC MAINS (WATER, SEWER AND STORM SYSTEMS). IF THERE IS A CONFLICT, THE APPLICANT IS REQUIRED TO SUBMIT A REVISION FOR APPROVAL PRIOR TO ANY GRADING ACTIVITIES OVER THE PUBLIC MAINS.
- REMEMBER: EROSION CONTROL IS YOUR FIRST INSPECTION.
- ROOF DRAINS MUST BE CONNECTED TO THE STORM DRAIN SYSTEM AND INSPECTED BY THE PUBLIC WORKS DEPARTMENT PRIOR TO ANY BACKFILLING OF PIPE.
- SILENT FENCE: CLEAN AND PROVIDE REGULAR MAINTENANCE OF THE SILT FENCE. THE FENCE IS TO REMAIN VERTICAL AND IS TO FUNCTION PROPERLY THROUGHOUT THE TERM OF THE PROJECT.
- WORK IN PUBLIC RIGHT OF WAY REQUIRES A RIGHT-OF-WAY USE PERMIT.
- REFER TO WATER SERVICE PERMIT FOR ACTUAL LOCATION OF NEW WATER METER AND SERVICE LINE DETERMINED BY MERCER ISLAND WATER DEPARTMENT.
- THE TV INSPECTION OF THE EXISTING SIDE SEWER TO THE CITY SEWER MAIN IS REQUIRED. IF THE RESULT OF THE TV INSPECTION IS NOT IN SATISFACTORY CONDITION, AS DETERMINED BY THE CITY OF MERCER ISLAND INSPECTOR, THE REPLACEMENT OF THE EXISTING SIDE SEWER IS REQUIRED. ALTERNATELY, A PRESSURE TEST OF THE SIDE SEWER, FROM SEWER MAIN TO POINT OF CONNECTION, MAY BE SUBSTITUTED FOR THE VIDEO INSPECTION.
- NEWLY INSTALLED SIDE SEWER REQUIRES A 4 P.S.I. AIR TEST OR PROVIDE 10' OF HYDROSTATIC HEAD TEST.
- POT HOLING THE PUBLIC UTILITIES IS REQUIRED PRIOR TO ANY GRADING ACTIVITIES LESS THAN 6" OVER THE PUBLIC MAINS (WATER, SEWER AND STORM SYSTEMS). IF THERE IS A CONFLICT, THE APPLICANT IS REQUIRED TO SUBMIT A REVISION FOR APPROVAL PRIOR TO ANY GRADING ACTIVITIES OVER THE PUBLIC MAINS.
- THE LIMITS AND EXTENDS OF THE PAVEMENT IN THE PUBLIC RIGHT OF WAY SHALL BE DETERMINED BY THE CITY ENGINEER PRIOR TO FINALIZE THE PROJECT.

**CONSTRUCTION ENTRANCE**

DOE

Figure II-3.1: Stabilized Construction Access

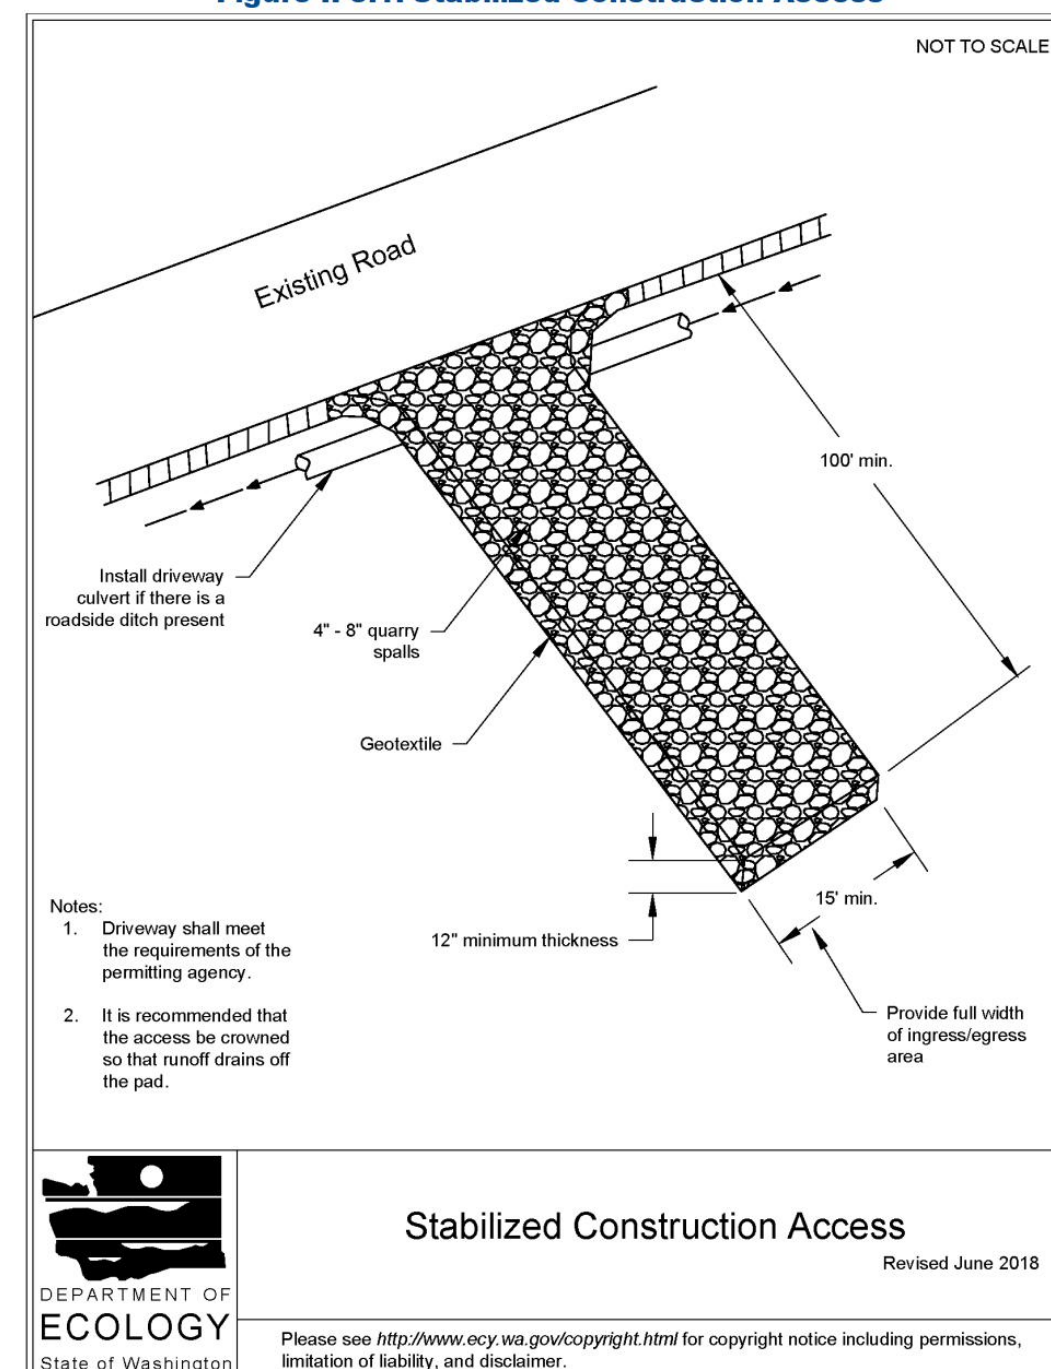

Stabilized Construction Access

Revised June 2018

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**DENUDED AREAS REQUIREMENTS**


- APRIL 1 TO SEPT 30  
ALL DENUDED AREAS MUST BE STABILIZED WITHIN 7 DAYS OF CONSTRUCTION. PLEASE READ ALL CITY TESC NOTES ON SHEET C1.2.
- OCT 1 TO MARCH 31  
ALL DENUDED AREAS MUST BE STABILIZED WITHIN 2 DAYS OF GRADING. IF AN EROSION PROBLEM ALREADY EXISTS ON THE SITE, OTHER COVER PROTECTION AND EROSION CONTROL WILL BE REQUIRED.

NO.	DATE	BY	REVISIONS

APPLICANT:  
MASON HELMS  
JASON KOEHLER



DATE: September 8, 2020  
JOB# 1896-2  
DRAFTED: SS DESIGN: DE  
DIGITAL SIGNATURE

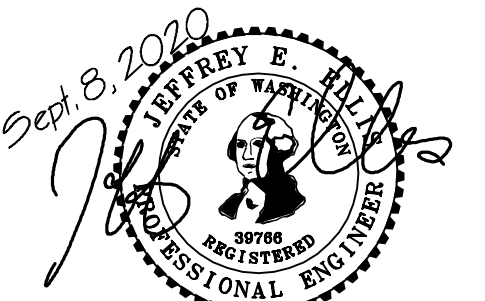

**CIVIL ENGINEERING SOLUTIONS**  
102 NW CANAL STREET SEATTLE, WA 98107  
PHONE: 206.930.0342 DUFFY@CESOLUTIONS.US

**TESC & CITY NOTES**  
**TESC DETAILS**  
MARBELLA RESIDENCE  
7311 W. MERCER WAY, MERCER ISLAND, WA 98040

DRAWING NO:  
**C1.2**  
APN 894422-0060

**SANITARY SEWER IMPROVEMENTS**

- 1 -
- 2 - 6" SDR 35 PVC SANITARY SEWER(SS) @ MIN 1.0 %.
- 3 - BACKWATER VALVE ASSEMBLY INSTALLED TO EXISTING SIDE SEWER. SEE DETAIL S-26. VALVE ELEVATION MIN. 2- FEET ABOVE HIGH WATER ELEVATION.
- 4 -
- 7 - LOCATE AND VIDEO CONDITION OF EXISTING SANITARY SIDE SEWER. REPLACE LINE IF FOUND DEFECTIVE AS DETERMINED BY CITY INSPECTOR.

**WATER IMPROVEMENTS**

- 10 -
- 11 - PRIVATE WATER SERVICE FROM METER TO HOUSE. SEE PLAN FOR SIZE. CONFIRM ADEQUATE TO MEET FIRE FLOW REQUIREMENTS. HDPE WATER (ASTM D2239). RECOMMENDED DEPTH=36".
- 13 - REDUCED PRESSURE BACKFLOW ASSEMBLY (RPBA) REQUIRED. PROVIDE FROST PROTECTION IN ACCORDANCE WITH UPC (UNIFORM PLUMBING CODE)
- 14 -

**STORM DRAIN STRUCTURES**

- 30 -
- 31 -
- 32 -
- 33 -
- 34 -
- 35 -
- 36 -
- 39 -
- 40 - TYPE 40 CATCH BASIN OR EQUAL. FOR WQ, ADD WATER QUALITY TEE TO EXITING PIPE (OR DOWNTURNED ELBOW).
- 41 - 54" ID TYPE 2 MH CONTROL STRUCTURE WITH SOLID LID. SEE ALL DETAILS AND PROFILE C4.0.
- 43 -
- 46 -
- 47 - DETENTION PIPE: ALUMINIZED CMP @ 0.5 % GRADE. SEE PLAN FOR SIZE AND CONFIGURATION. SEE PROFILE, NOTES, AND DETAILS ON C4.0.

**STORM BMP's**

COMPOSTED AMENDED SOIL IS REQUIRED FOR DISTURBED AREAS. SEE DETAIL ON C3.5.

STORM BMP'S ARE NOT PROPOSED FOR PROJECT. SEE STORM REPORT.

DETENTION IS NOT PROPOSED DUE TO THE PROXIMITY OF THIS LOT TO LAKE WASHINGTON (LESS THAN 1/4 MILE WITH NO CAPACITY CONSTRAINTS).

**STORM DRAIN**

- 20 - 4" STORM DRAIN (3034 PVC) @ MIN 2 % GRADE
- 21 - 4" FOUNDATION DRAIN (3034 PVC) @ MIN 1 % GRADE
- 22 - 6" STORM DRAIN (3034 PVC) @ MIN 2 % GRADE
- 23 -
- 24 -
- 25 -
- 26 - 6" SURFACE MOUNTED PIPE AFTER DAYLIGHTING FROM CATCH BASIN SEE CITY OF SEATTLE SURFACE MOUNT DETAIL ON SHEET C3.5. HILL HUGGERS ANOTHER OPTION. PIN DOWN PIPE MIN 30' INTERVALS. CONSULT ENGINEER OR CITY INSPECTOR FOR ALTERNATIVE PIPE ANCHOR.
- 28 -
- 29 -

**PRIVATE PVC STORM STRUCTURES**

- 103 - 24" NYLOPLAST PVC AREA DRAIN (OR EQUAL). H20 RATED GRATE IN DRIVEWAY LOCATIONS.
- 104 -
- 105 -
- 106 -

**SURVEYOR**

TOPOGRAPHIC & BOUNDARY SURVEY BY:  
TERRANCE  
10801 MAIN STREET, SUITE 102  
BELLEVUE, WA 98004  
PHONE 425.458.4488

**VERTICAL DATUM**

NAVD 88 PER CITY OF MERCER ISLAND BENCHMARK  
3185  
SEE SURVEY

**IMPERVIOUS AREA TABLE**

SEE DETENTION SHEET C4.0

**LEGAL DESCRIPTION**

SEE SHEET C1.0

**SOILS**


SITE IS IN AN AREA MAPPED "INFILTRATING LID FACILITIES ARE NOT PERMITTED" ON THE "LOW IMPACT DEVELOPMENT INFILTRATION FEASIBILITY ON MERCER ISLAND" MAP. INFILTRATION IS NOT PROPOSED.

**SOIL AMENDMENT REQUIRED**

COMPOST AMENDED SOIL REQUIRED ON ALL LANDSCAPED AREAS AFTER CONSTRUCTION. SEE DETAIL ON C3.5.

**SOIL INSPECTION REQUIRED**


A POST CONSTRUCTION INSPECTION & CERTIFICATION OF AMENDED SOILS IS REQUIRED BY A LICENSED CIVIL ENGINEER. THIS IS REQUIRED BEFORE FINAL SIGN-OFF BY CITY.

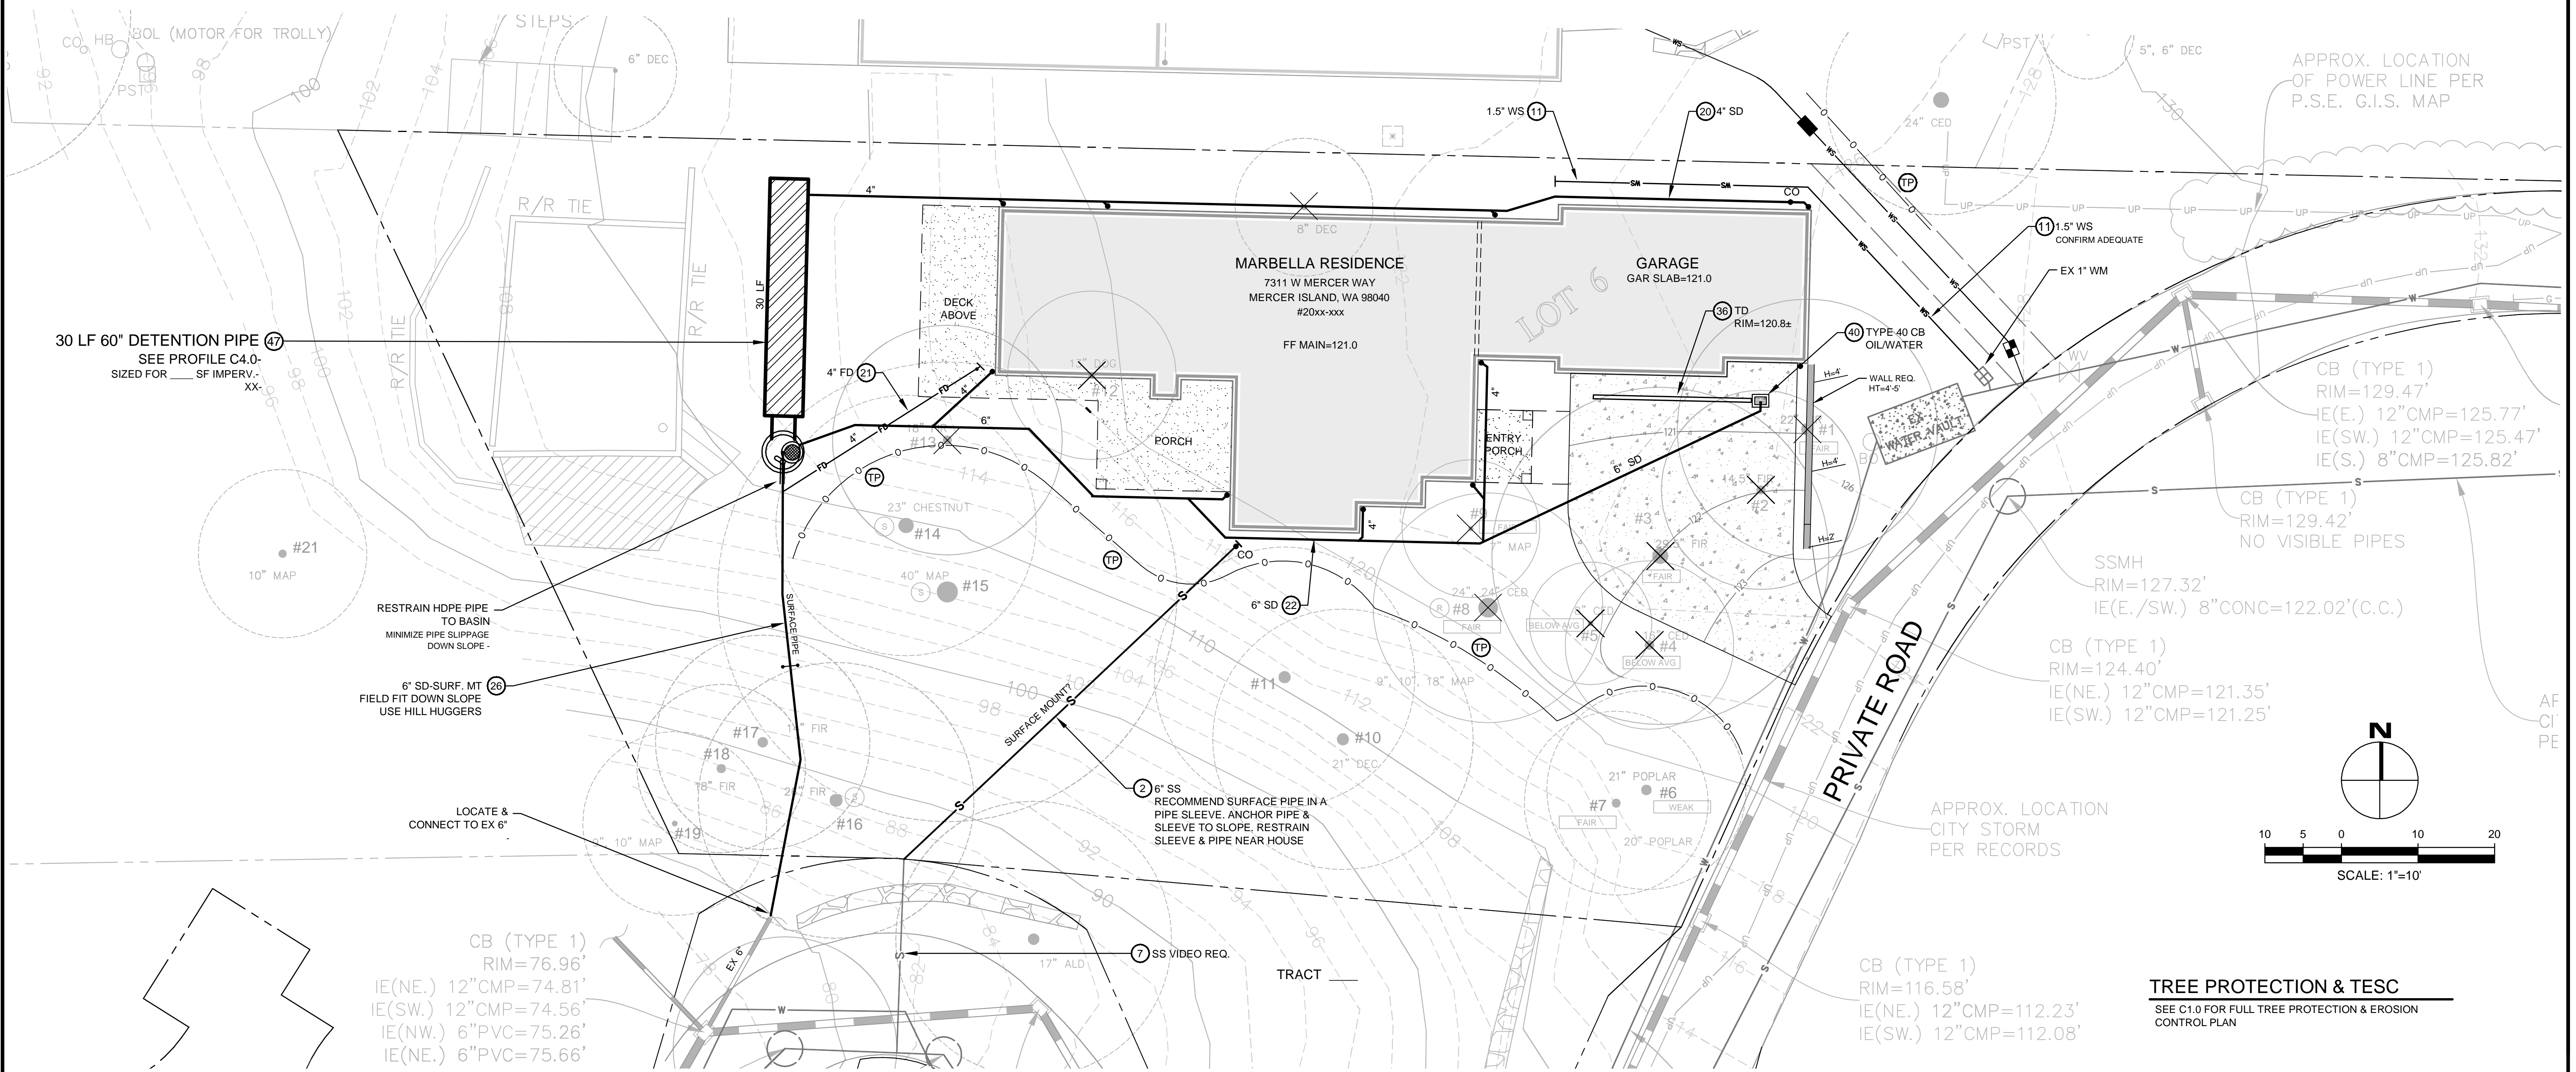

NO.	DATE	BY	REVISIONS

APPLICANT:  
MASON HELMS  
JASON KOEHLER

DATE: September 14, 2020  
JOB# 1896-2  
DRAFTED: SS DESIGN: SS  
DIGITAL SIGNATURE

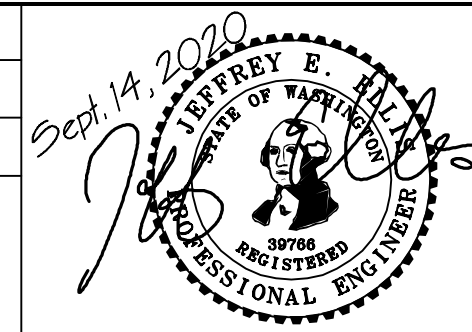

**CIVIL ENGINEERING SOLUTIONS**

102 NW CANAL STREET SEATTLE, WA 98107  
PHONE: 206.930.0342 DUFFY@CESOLUTIONS.US

**DRAINAGE & TREE PLAN**

MARBELLA RESIDENCE  
7311 W. MERCER WAY, MERCER ISLAND, WA 98040

DRAWING NO:  
**C2.0**  
APN 894422-0060



**BUILDING CODE:** 2015 EDITION OF THE INTERNATIONAL BUILDING CODE (IBC), AND BY REFERENCE, THE 2015 INTERNATIONAL RESIDENTIAL CODE (IRC) AS AMENDED BY LOCAL JURISDICTION.  
**ROOF LIVE LOAD:** 25 PSF SNOW (GROUND SNOW = 30 PSF)  
**ROOF DEAD LOAD:** 15 PSF  
**FLOOR LIVE LOAD:** 40 PSF (30 PSF AT SLEEPING AREAS)  
**FLOOR DEAD LOAD:** 15 PSF  
**BALCONIES & DECKS:** 60 PSF (LIVE LOAD) + 10 PSF (DEAD LOAD)  
**WIND SPEED (ULTIMATE / 3 SEC GUST):** 110 MPH (NOMINAL WIND SPEED = 85 MPH) FOR RISK CATEGORY II, EXPOSURE 'C', Kz1=1.00  
**SOIL SITE CLASS:** 'D', SEISMIC CATEGORY D1/D2, Ss=1.412, Sds=0.981  
**OCCUPANCY GROUP:** R-3 CONSTRUCTION TYPE: V-B

CONTRACTOR TO VERIFY ALL DIMENSIONS AND CONDITIONS OF PROJECT AND REPORT ANY OMISSIONS / DISCREPANCIES TO ARCHITECT AND/OR ENGINEER OF RECORD FOR RESOLUTION PRIOR TO COMMENCING WORK. WRITTEN DIMENSIONS TAKE PRECEDENCE OVER SCALED DRAWINGS. ARCHITECT AND/OR ENGINEER OF RECORD ARE NOT RESPONSIBLE FOR DISCREPANT CONDITIONS RESULTING FROM UNAUTHORIZED WORK PERFORMED BY THE CONTRACTOR.

**DEFERRED SUBMITTAL ITEMS**

THE FOLLOWING IS A LIST OF ITEMS THAT ARE NOT INCLUDED IN THIS PLAN AND SHOULD BE PROVIDED BY THE BUILDER AT TIME OF APPLICATION FOR PERMIT OR AS A DEFERRED SUBMITTAL ITEM:  
 - ALTERNATIVE 1-JOIST/BEAM MANUFACTURER PLANS.  
 - MANUFACTURED TRUSS DESIGNS AND LAYOUTS

**GENERAL**

FOUNDATION DESIGN IS BASED ON AN ALLOWABLE SOIL BEARING OF 1500 PSF. EXTERIOR FOOTINGS SHALL BEAR 12" (MINIMUM) BELOW FINISHED GRADE. ALL FOOTINGS TO BE ON FIRM UNDISTURBED EARTH BELOW ORGANIC SURFACE SOILS. BACKFILL TO BE THOROUGHLY COMPACTED.  
 BOLT HEADS AND NUTS BEARING AGAINST WOOD TO BE PROVIDED WITH 0.229"x3"x3" PLATE WASHERS. WOOD BEARING ON OR INSTALLED WITHIN 1" OF MASONRY OR CONCRETE TO BE PRESSURE TREATED WITH AN APPROVED PRESERVATIVE.  
 FOUNDATION SILL BOLTS (MIN. 1" EMBED) TO BE 5/8" DIAMETER AT 6'-0" O.C. (4'-0" AT BUILDINGS OVER 2 STORIES) UNO. METAL FRAMING CONNECTORS TO BE MANUFACTURED BY SIMPSON STRONG-TIE OR USF STEEL CONNECTORS

**CONCRETE**

MINIMUM COMPRESSIVE STRENGTH OF CONCRETE:

TYPE OR LOCATIONS OF CONCRETE CONSTRUCTION	MINIMUM COMPRESSIVE STRENGTH (f'c) AT 28 DAYS
BASEMENT WALLS, FOUNDATION FOOTINGS, BASEMENT SLABS, & INTERIOR SLABS ON GRADE (EXCEPT GARAGE) NOT EXPOSED TO THE WEATHER	2500 psi
BASEMENT WALLS, FOUNDATION WALLS, EXTERIOR WALLS, PORCHES, STEPS, GARAGE & CARPORT SLABS, & OTHER CONCRETE WORK EXPOSED TO THE WEATHER	3,000 psi (6% air entrained w/ 1%)

CONCRETE MIXTURE SHALL CONTAIN AT LEAST OF 5 1/2 BAGS OF CEMENT PER CUBIC YARD. CONCRETE "BATCH TICKET" SHALL BE AVAILABLE ON SITE FOR REVIEW BY BUILDING OFFICIAL. VERTICAL REINFORCING STEEL TO COMPLY WITH ASTM A635 GRADE 40 (GRADE 60 AT WALLS RETAINING MORE THAN 4FT OF SOIL)

**CARPENTRY**

**GENERAL**

ALL NAILING TO COMPLY WITH REQUIREMENTS OF IRC TABLE R602.3(1) AND/OR IBC TABLE 2304.10.1. ALL WOOD IN CONTACT WITH CONCRETE TO BE PRESSURE TREATED. FIELD CUT ENDS, NOTCHES, AND DRILLED HOLES OF PRESSURE TREATED LUMBER SHALL BE RETREATED IN THE FIELD IN ACCORDANCE WITH AWPA M4. PER IRC 303.3, FASTENERS FOR PRESSURE PRESERVATIVE AND FIRE RETARDANT TREATED WOOD SHALL BE OF HOT-DIPPED GALVANIZED STEEL, STAINLESS STEEL, SILICON BRONZE, OR COPPER.  
 6" MIN. CLEARANCE BETWEEN WOOD AND EARTH.  
 12" MIN. CLEARANCE BETWEEN FLOOR BEAMS AND EARTH.  
 18" MIN. CLEARANCE BETWEEN FLOOR JOIST AND EARTH.

**FASTENER DIMENSIONS**

ALL NAILS SPECIFIED ON THIS PLAN SHALL BE OF THE DIAMETER AND LENGTH LISTED BELOW OR AS PER APPROPRIATE DESIGN SPECIFICATION FOR WOOD CONSTRUCTION (NDS).  
 8d COMMON (0.131" DIA, 2-1/2" LENGTH), 8d BOX (0.131" DIA, 2-1/2" LONG), 10d COMMON (0.148" DIA, 3" LONG), 10d BOX (0.128" DIA, 3" LENGTH), 16d COMMON (0.162" DIA, 3-1/2" LONG), 16d SINKER (0.148" DIA, 3-1/4" LONG), 5d COOLER (0.086" DIA, 1-5/8" LONG), 6d COOLER (0.092" DIA, 1-7/8" LONG)

**LUMBER GRADES**

FRAMING LUMBER SHALL COMPLY WITH THE LATEST EDITION OF THE GRADING RULES OF THE WESTERN PRODUCTS ASSOCIATION OR THE BEST COST LUMBER INSPECTION AGENCY. ALL SAWN LUMBER SHALL BE STAMPED WITH THE GRADE MARK OF AN APPROVED LUMBER GRADING AGENCY AND SHALL HAVE THE FOLLOWING UNADJUSTED MINIMUM DESIGN PROPERTIES, UNLESS NOTED OTHERWISE.

JOISTS:	WOOD TYPE:
2x4 to 2x8	DF-L #2 - Fc=1900 psi, Fv=180 psi, Fc=1350 psi, E=1600000 psi
2x10 OR LARGER	DF-L #2 - Fc=300 psi, Fv=180 psi, Fc=1350 psi, E=1600000 psi
BEAM:	WOOD TYPE:
4x4	DF-L #2 - Fc=300 psi, Fv=180 psi, Fc=1350 psi, E=1600000 psi
6x6 OR LARGER	DF-L #2 - Fc=875 psi, Fv=170 psi, Fc=600 psi, E=1300000 psi
STUDS:	WOOD TYPE:
2x4 & 2x6	DF STUD - Fc=1700 psi, Fv=180 psi, Fc=850 psi, E=1400000 psi
2x8 OR LARGER	DF-L #2 - Fc=300 psi, Fv=180 psi, Fc=1350 psi, E=1600000 psi
POSTS:	WOOD TYPE:
4x4	DF-L #2 - Fc=300 psi, Fv=180 psi, Fc=1350 psi, E=1600000 psi
4x6	DF-L #2 - Fc=300 psi, Fv=180 psi, Fc=1350 psi, E=1600000 psi
6x6 OR LARGER	DF-L #1 - Fc=1200 psi, Fv=170 psi, Fc=1000 psi, E=1600000 psi

**GLUED-LAMINATED BEAM (GLB)**

SHALL BE 24F-V4 FOR SINGLE SPANS & 24F-V8 FOR CONTINUOUS OR CANTILEVER SPANS WITH THE FOLLOWING MINIMUM PROPERTIES:  
 Fc = 2,400 PSI, Fv = 165 PSI, Fc = 650 PSI (PERPENDICULAR), E = 1,800,000 PSI.

**ENGINEERED WOOD BEAMS AND 1-JOIST**

CONTRACTOR SHALL SUBMIT SHOP DRAWINGS AND SPECIFICATIONS FOR APPROVAL BY BUILDING OFFICIAL, DESIGN, FABRICATION AND ERECTION IN ACCORDANCE WITH THE LATEST ICC EVALUATION REPORT.

BEAMS DESIGNATED AS "L8L" SHALL HAVE THE MINIMUM PROPERTIES:  
 Fc = 2,325 PSI, Fv = 310 PSI, Fc = 800 PSI (PERPENDICULAR), E = 1,550,000 PSI.

BEAMS DESIGNATED AS "LVL" SHALL HAVE THE MINIMUM PROPERTIES:  
 Fc = 2,600 PSI, Fv = 285 PSI, Fc = 750 PSI (PERPENDICULAR), E = 1,900,000 PSI.

BEAMS DESIGNATED AS "EBL" SHALL HAVE THE MINIMUM PROPERTIES:  
 Fc = 2,900 PSI, Fv = 280 PSI, Fc = 750 PSI (PERPENDICULAR), E = 2,000,000 PSI.

CALCULATIONS SHALL INCLUDE DEFLECTION AND CAMBER REQUIREMENTS. DEFLECTION SHALL BE LIMITED AS FOLLOWS:  
 FLOOR LIVE LOAD MAXIMUM = L/480, FLOOR TOTAL LOAD MAXIMUM = L/240.

**PREFABRICATED WOOD TRUSSES:**



PRE-FABRICATED WOOD TRUSSES SHALL BE DESIGNED TO SUPPORT SELF WEIGHT PLUS LIVE LOADS & IMPOSED DEAD LOADS AS STATED IN THE GENERAL NOTES. TRUSSES SHALL BE DESIGNED & STAMPED BY A REGISTERED DESIGN PROFESSIONAL AND FABRICATED ONLY FROM THOSE DESIGNS. NON-BEARING WALLS SHALL BE HELD AWAY FROM THE TRUSS BOTTOM CHORD W/ AN APPROVED FASTENER (SUCH AS SIMPSON STC) TO ENSURE THAT THE TRUSS BOTTOM CHORD DOES NOT BEAR ON THE WALL. ALL PERMANENT TRUSS MEMBER BRACING SHALL BE INSTALLED PER THE TRUSS DESIGN DRAWINGS.

**ROOF/WALL/FLOOR SHEATHING**

ROOF SHEATHING SHALL BE MINIMUM 5/8" SHEATHING W/ 3/4" SPAN INDEX UNO. WALL SHEATHING, INCLUDING GABLES, SHALL BE 7/8" SHEATHING W/ 3/4" SPAN INDEX MINIMUM UNO. FLOOR SHEATHING SHALL BE MINIMUM 5/8" 1G SHEATHING W/ 40% SPAN INDEX MINIMUM UNO. MINIMUM NAILING SHALL BE 8d COMMON NAILS @ 6" O.C. @ PANEL EDGES & 12" O.C. IN PANEL FIELD UNO ON SHEAR WALL SCHEDULE. ROOF AND FLOOR SHEATHING SHALL BE LAID OUT W/ LONG DIMENSION PERPENDICULAR TO FRAMING MEMBERS W/ END LAPS STAGGERED. WALL SHEATHING, INCLUDING GABLES, SHALL BE FULLY BLOCKED & EDGE NAILED AT ALL UNSUPPORTED SHEATHING PANEL EDGES.

**STAIR FRAMING**

UNLESS NOTED OTHERWISE SPECIFIED, TYPICAL STAIR FRAMING SHALL CONSIST OF 2X12 STAIR STRINGERS SPACED AT NO MORE THAN 18" O.C. AND REINFORCED W/ 2X6 SCABS ATTACHED W/ 10d COMMON NAILS STAGGERED AT 8" O.C. STRINGERS SHALL BE SUPPORTED AT UPPER END BY BEARING ON TOP PLATE OF WALL OR APPROVED CONNECTOR TO FLOOR BEAM SUCH AS SIMPSON LRU OR LSC. LANDINGS SHALL CONSIST OF CONVENTIONAL PLATFORM FRAMING W/ MINIMUM 2X6 JOISTS @ 16" O.C.

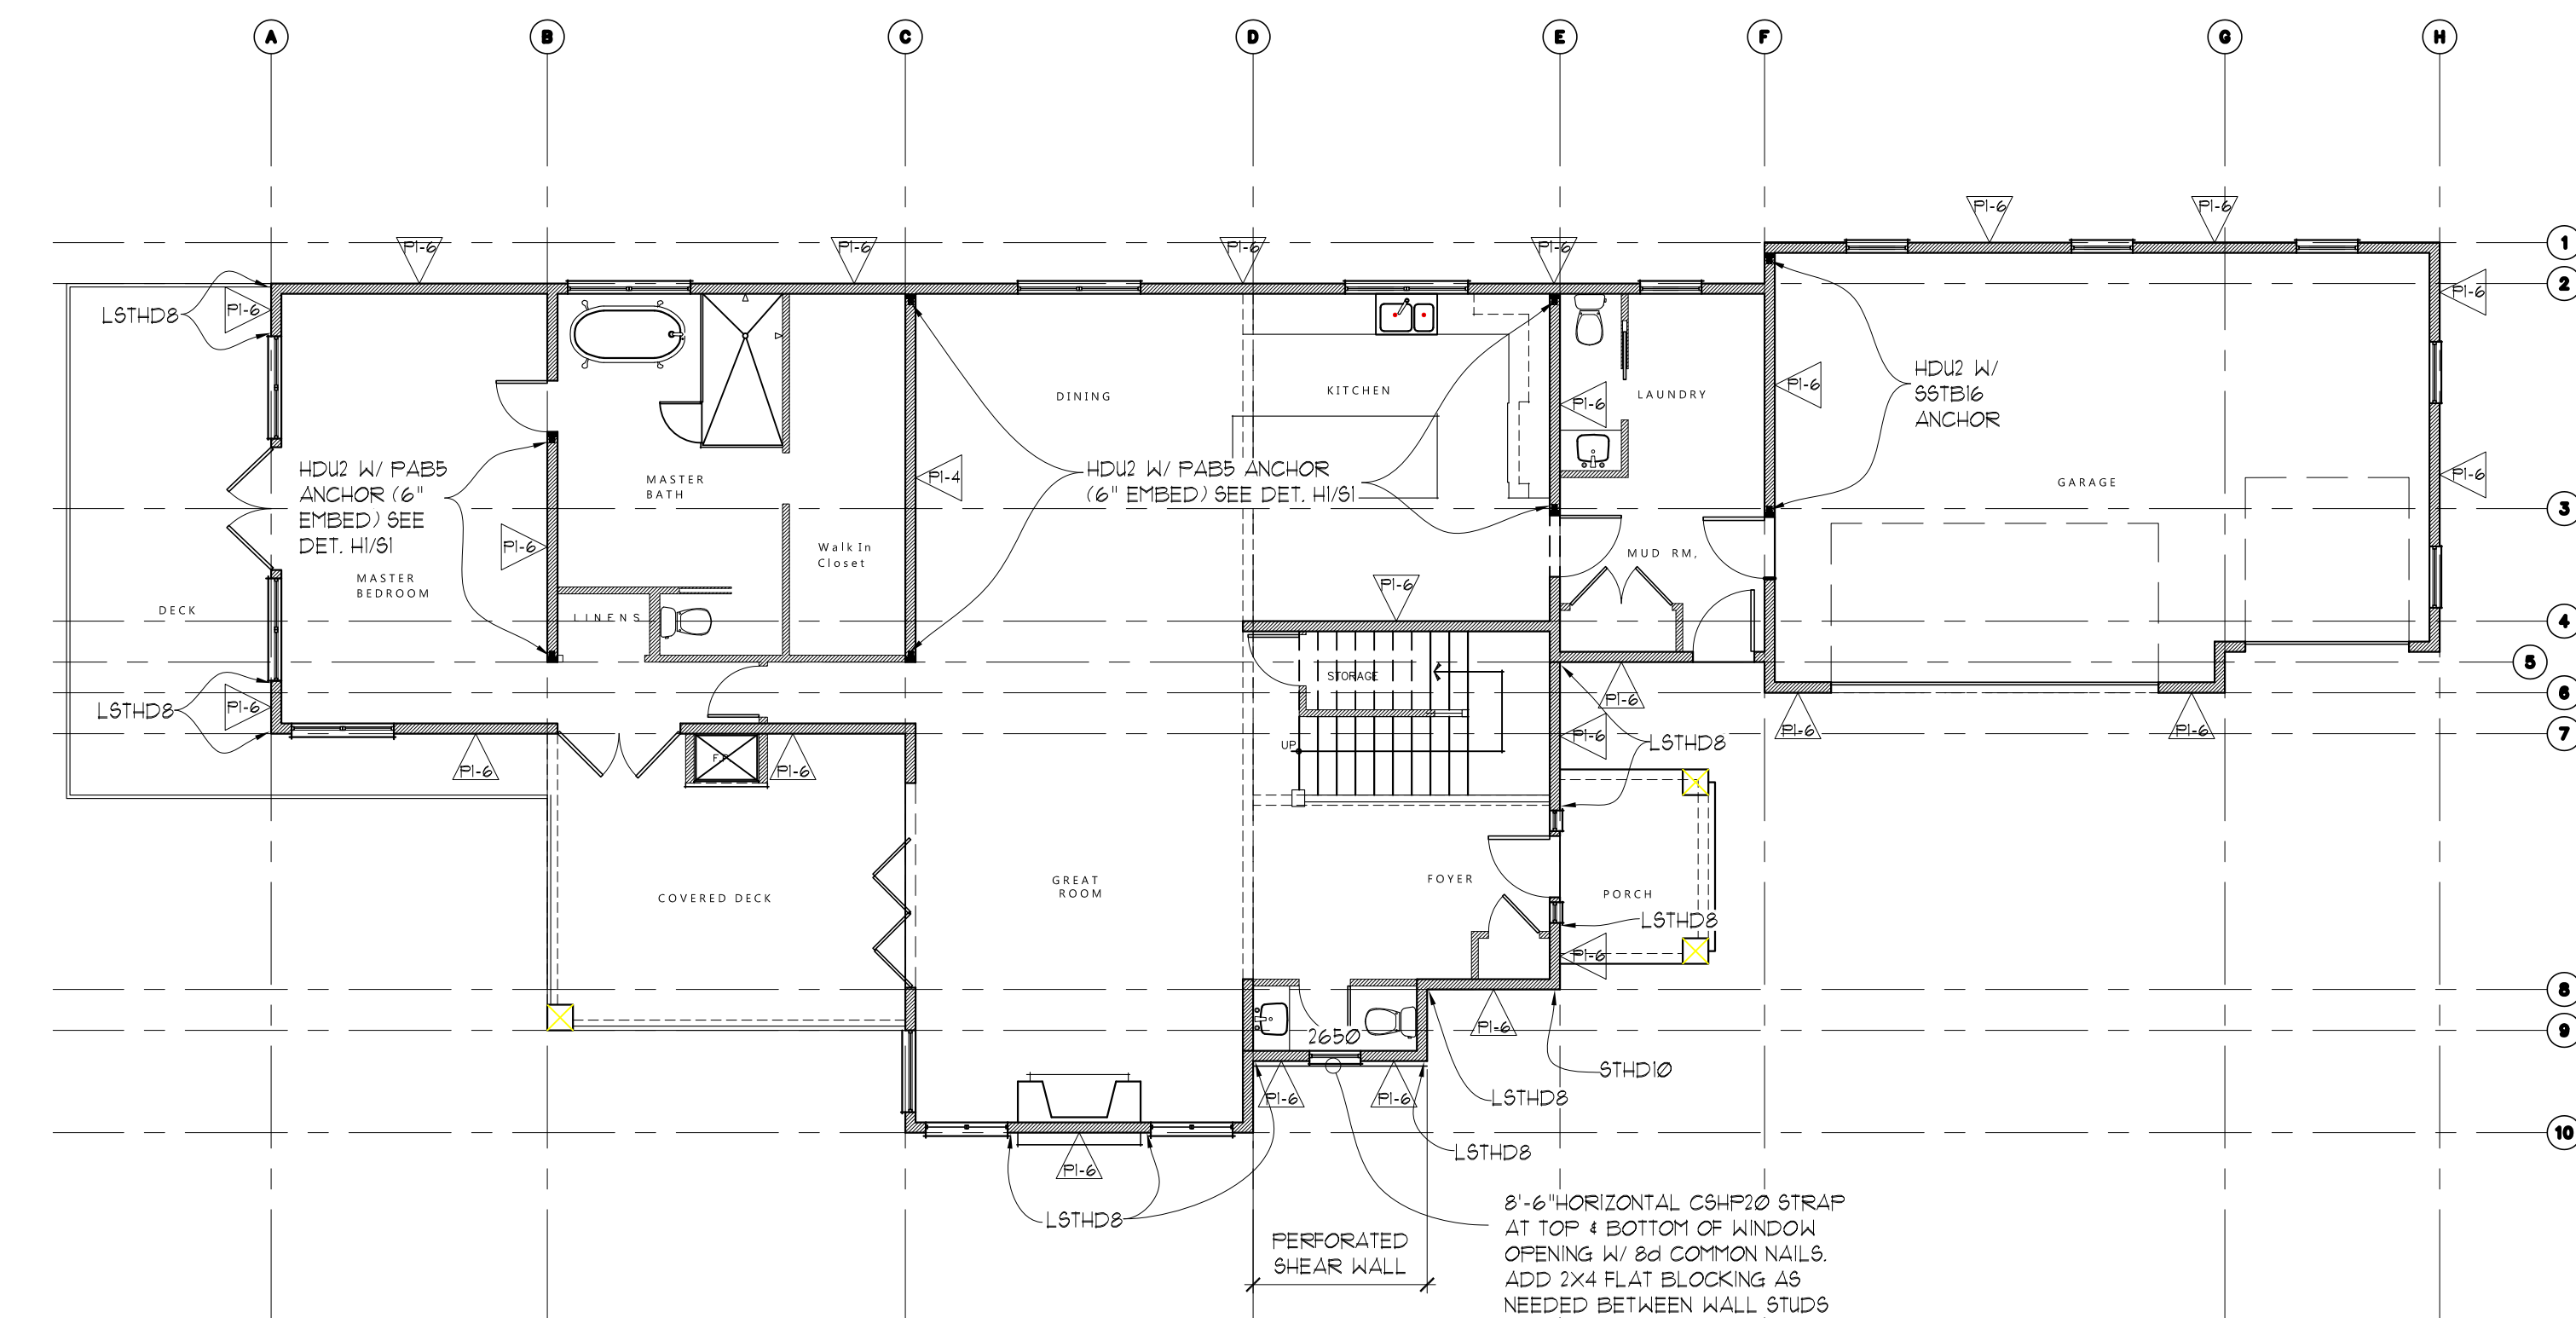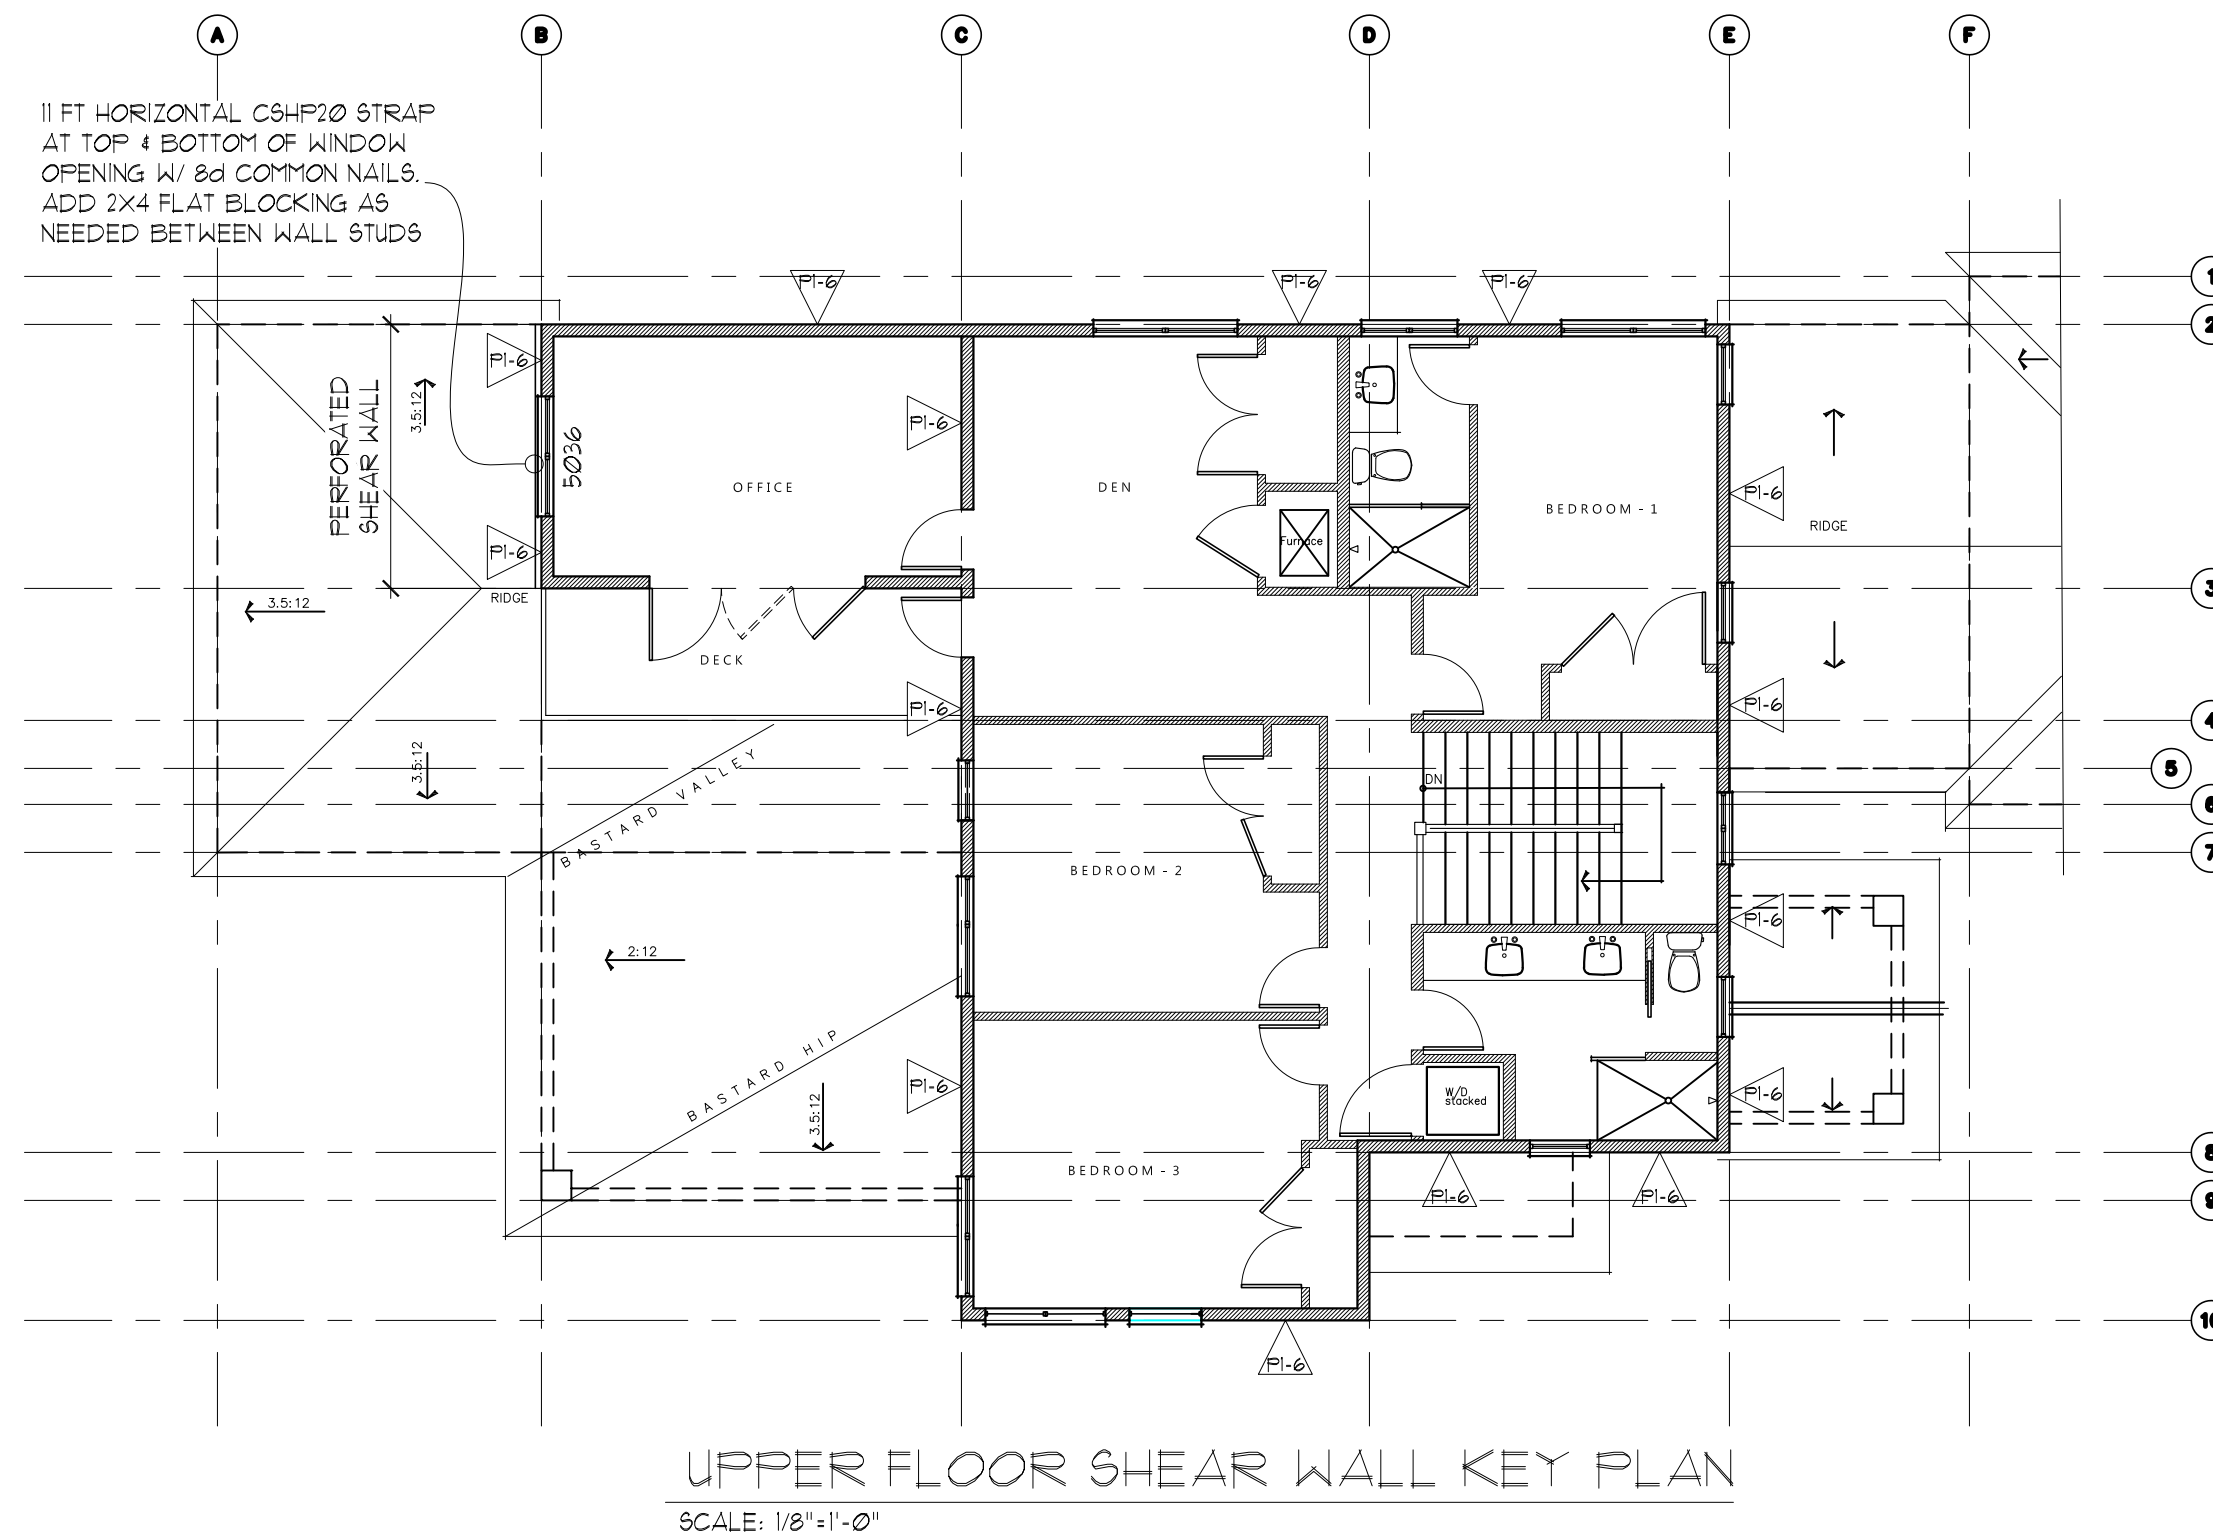

MAIN FLOOR SHEAR WALL KEY PLAN


SCALE: 1/8"=1'-0"

**SHEAR WALL SCHEDULE**

WALL MARK	SHEATHING THICKNESS	SIDES	SHEAR PANEL EDGE NAILING	FIELD NAILING	FRAMING @ ABUTTING PANEL EDGES	SOLE/BASE PLATE NAILING TO JOIST OR BLKG/RIM BELOW	ANCHOR BOLT DIA. & SPACING	SILL PLATE SIZE	POST AT ENDS OF SHEAR WALL/HOLDOWN UNO.
PI-6	7/16"	ONE	8d @ 6" O.C.	12" O.C.	2X	16d SINKER NAILS (0.148"x3 1/2") @ 8" O.C.	5/8" DIA. @ 12" O.C.	2X	(2) 2X POST (FACE NAIL W/ 10d (0.131"x3") NAILS @ 12" O.C. (STAGGERED))
PI-4	7/16"	ONE	8d @ 4" O.C.	12" O.C.	2X	16d SINKER NAILS (0.148"x3 1/2") @ 6" O.C.	5/8" DIA. @ 48" O.C.	2X	(2) 2X POST (FACE NAIL W/ 10d (0.131"x3") NAILS @ 12" O.C. (STAGGERED))


- FRAMING SHALL BE 2X HEM-FIR @ 16" O.C. MAX UNLESS NOTED OTHERWISE IN SCHEDULE.
- SHEATHING PANELS MAY BE LAYED VERTICAL OR HORIZONTAL. BLOCK ALL HORIZONTAL EDGES W/ 2x OR 3x BLOCKING PER SCHEDULE (UNO.)
- ALL EXTERIOR WALLS NOT DESIGNATED AS SHEARWALLS SHALL RECEIVE APA RATED SHEATHING OR ALL VENEER PLYWOOD SIDING OF EQUIVALENT THICKNESS AT POINT OF FASTENING ON PANEL EDGES FULLY BLOCKED WITH MINIMUM NAILING OF 8d @ 6" O.C. EDGE, 12" O.C. FIELD.
- NAILING APPLIES TO ALL STUDS, TOP AND BOTTOM PLATES, AND BLOCKING. PLYWOOD JOINT AND SILL PLATE NAILING SHALL BE STAGGERED.
- ANCHOR BOLT SPACING IS 6'-0" O.C. (4'-0" AT BUILDINGS OVER 2 STORIES) UNLESS NOTED OTHERWISE IN SCHEDULE. MINIMUM OF 2 ANCHOR BOLTS PER PIECE OF FOUNDATION PLATE. ANCHOR BOLTS SPACED NO GREATER THAN 12" AND NO LESS THAN 7 TIMES THE ANCHOR BOLT DIAMETER AT ENDS AND SPLICES. PROVIDE 0.229"x3"x3" WASHERS AT ANCHOR BOLTS. PLATE WASHERS SHALL EXTEND TO WITHIN 1/2" OF THE SHEATHED EDGE OF THE SILL PLATE ON WALLS W/ EDGE NAILING AT 4" O.C. OR TIGHTER. DO NOT RECEIVE BOLTS.
- ALL NAILS FOR SHEAR WALLS SHALL BE COMMON OR GALVANIZED BOX NAILS (UNO.) ALL SPECIFIED NAILS SHALL HAVE THE FOLLOWING DIMENSIONS: 8d COMMON (0.131" DIA, 2 1/2" LONG), 8d BOX (0.131" DIA, 2 1/2" LONG), 10d COMMON (0.148" DIA, 3" LONG), 10d BOX (0.128" DIA, 3" LONG), 16d COMMON (0.162" DIA, 3 1/2" LONG), 16d SINKER (0.148" DIA, 3 1/4" LONG), 5d COOLER (0.086" DIA, 1 5/8" LONG), 6d COOLER (0.092" DIA, 1 7/8" LONG)
- 1 1/2" No. 6 DRYWALL SCREWS (TYPE W OR S) MAY BE SUBSTITUTED FOR NAILS LISTED AS 5d COOLER OR 6d COOLER FOR GYPSUM WALL BOARD SHEARWALLS.
- IN LIEU OF 3x VERTICALS AND BLOCKING AT PANEL EDGES, 2-2x6 W/ 10d (0.131"x3") FACE NAILS STAGGERED AT THE SAME SPACING AS PANEL EDGE NAILING MAY BE SUBSTITUTED. PLYWOOD EDGES TO BE CENTERED BETWEEN THE 2-2x MEMBERS (THIS ALTERNATIVE DOES NOT APPLY TO FOUNDATION SILL PLATES OR TO WALLS WITH 8d EDGE NAILING AT 2" O.C. OR 10d EDGE NAILING AT 3" O.C. OR 2" O.C. OR WALLS SHEATHED ON BOTH SIDES)
- HOLDDOWNS AND STRAPS OF EQUIVALENT UPLIFT CAPACITY WITH CURRENT ICC EVALUATION REPORT OR SIMILAR MAY BE SUBSTITUTED FOR THOSE LISTED IN THE SHEARWALL SCHEDULE WITH PRIOR APPROVAL OF BUILDING OFFICIAL OR ENGINEER OF RECORD.
- SQUASH BLOCKS IN FLOOR JOIST CAVITY ARE REQUIRED AT ENDS OF SHEAR WALLS WHERE FULL BEARING IS NOT PROVIDED BY THE FRAMING BELOW.
- SIMPSON MASAP MUDSILL ANCHORS MAY BE SUBSTITUTED (1) FOR (1) AT 2X SILL PLATES FOR THE 3/8" DIA. SILL PLATE ANCHOR BOLTS SPECIFIED.

PERFORATED SHEAR WALLS: CONTINUE SHEAR WALL SHEATHING ABOVE AND BELOW ALL OPENINGS BETWEEN FULL HEIGHT WALL SEGMENTS WITH NAILING AS SHOWN IN SHEAR WALL SCHEDULE. ANY INCREASE TO HEIGHT OR WIDTH OF WINDOW OPENING MUST BE APPROVED BY ENGINEER OF RECORD.

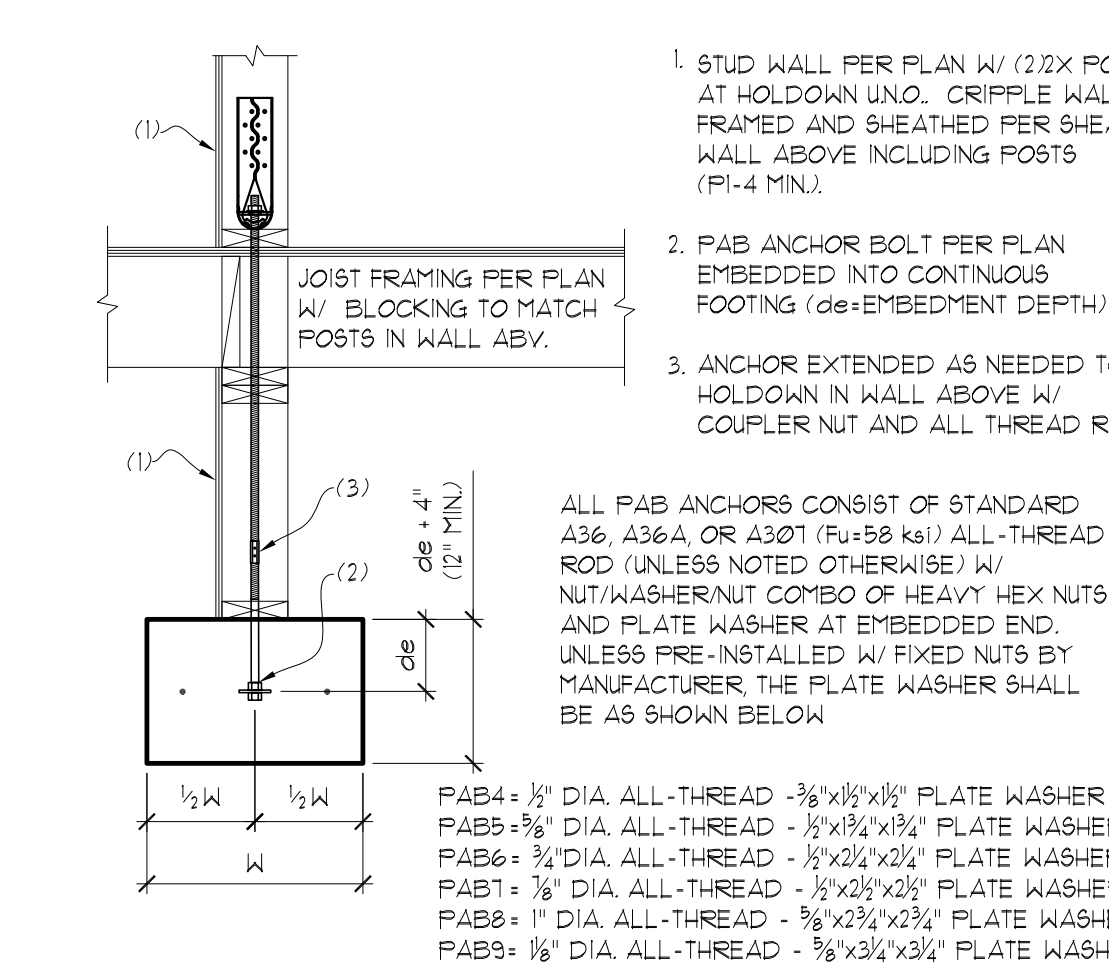


TYPICAL PAB ANCHOR BOLT

SCALE: 3/4"=1'

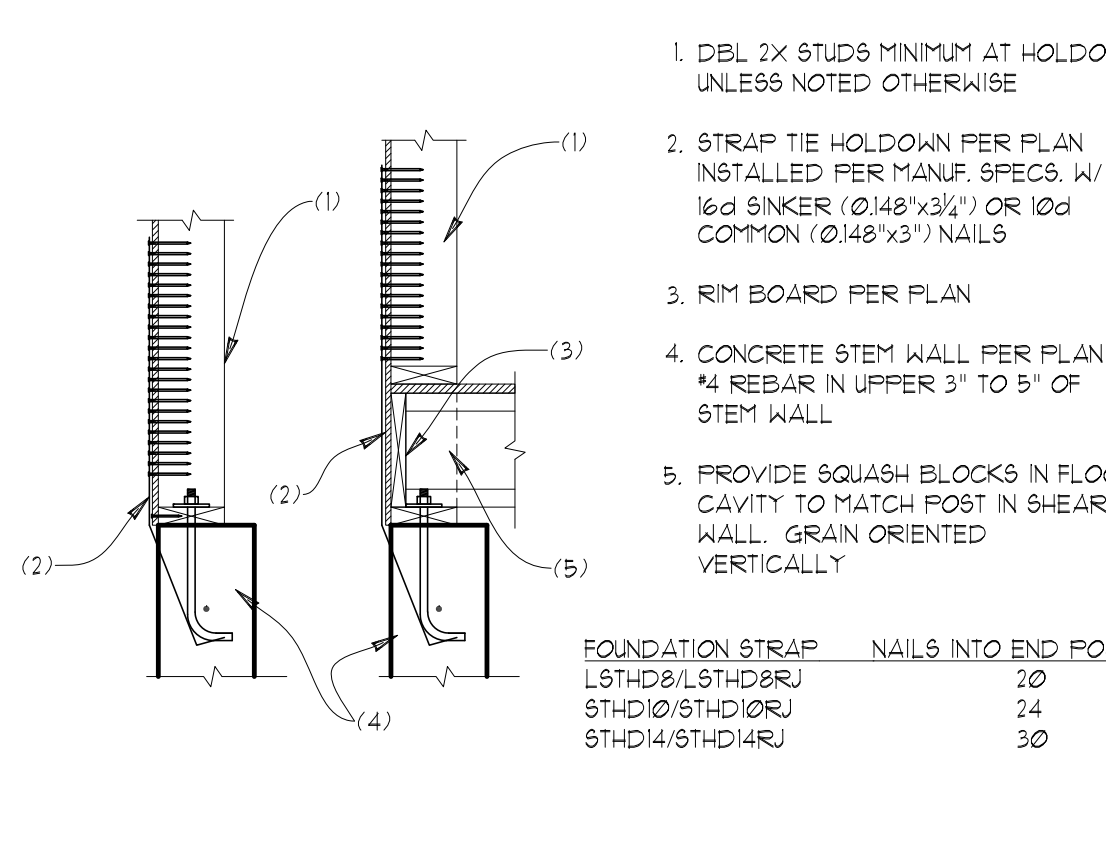

TYPICAL STRAP TIE HOLDOWN

SCALE: 3/4"=1'

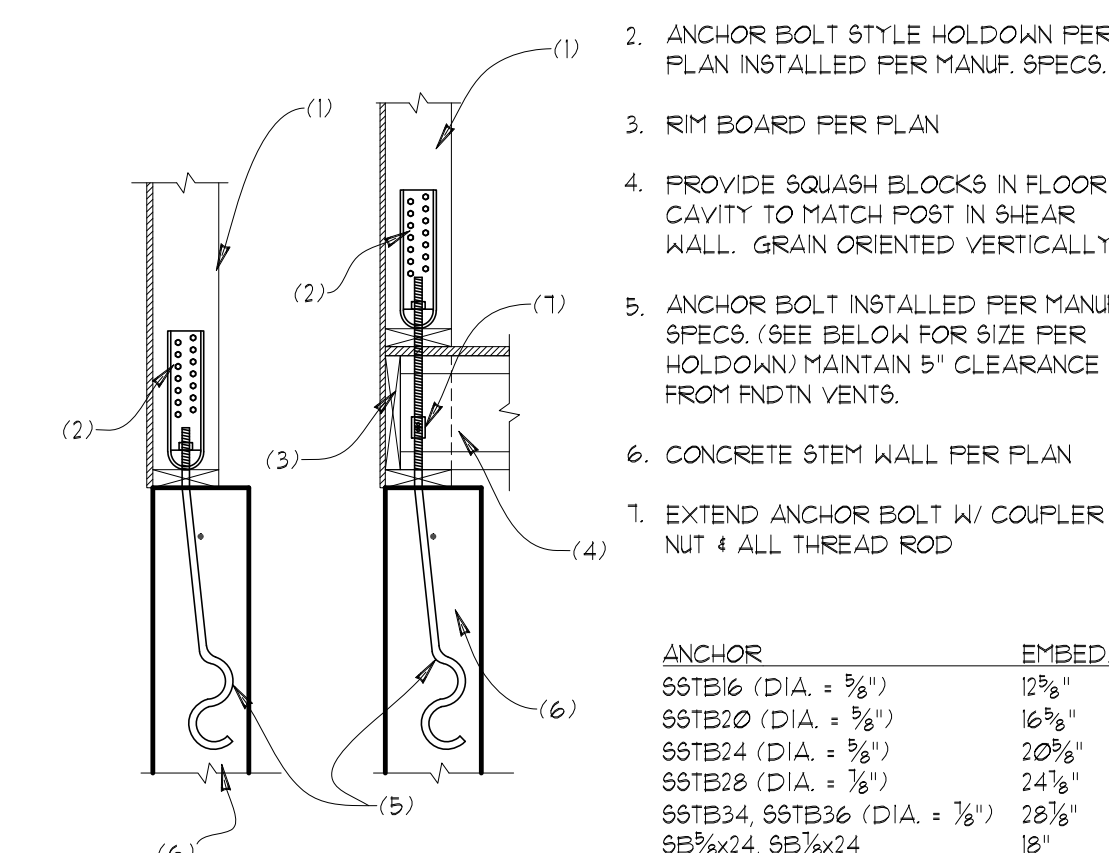

TYPICAL ANCHOR BOLT HOLDOWN

SCALE: 3/4"=1'

**STRUCTURAL PLANS**  
**MARBELLA RESIDENCE**  
**7311 W. MERCER WAY**  
**MERCER ISLAND, WA**

**Myers Engineering, LLC**  
 3206 50th Street Ct NW, Ste. 210-B  
 Gig Harbor, WA 98335  
 PH: 253-858-3248  
 Email: myengineer@centurytel.net


Digitally signed by Mark Myers, PE  
 Date: 2020.08.31 12:47:43 -07'00'

**BUILDING DEPT. APPROVAL STAMPS:**

REVISION DATE:	INITI:	PROJECT #:

DATE:	INITI:	PROJECT #:
8-31-2020	MM	2302

**S1**

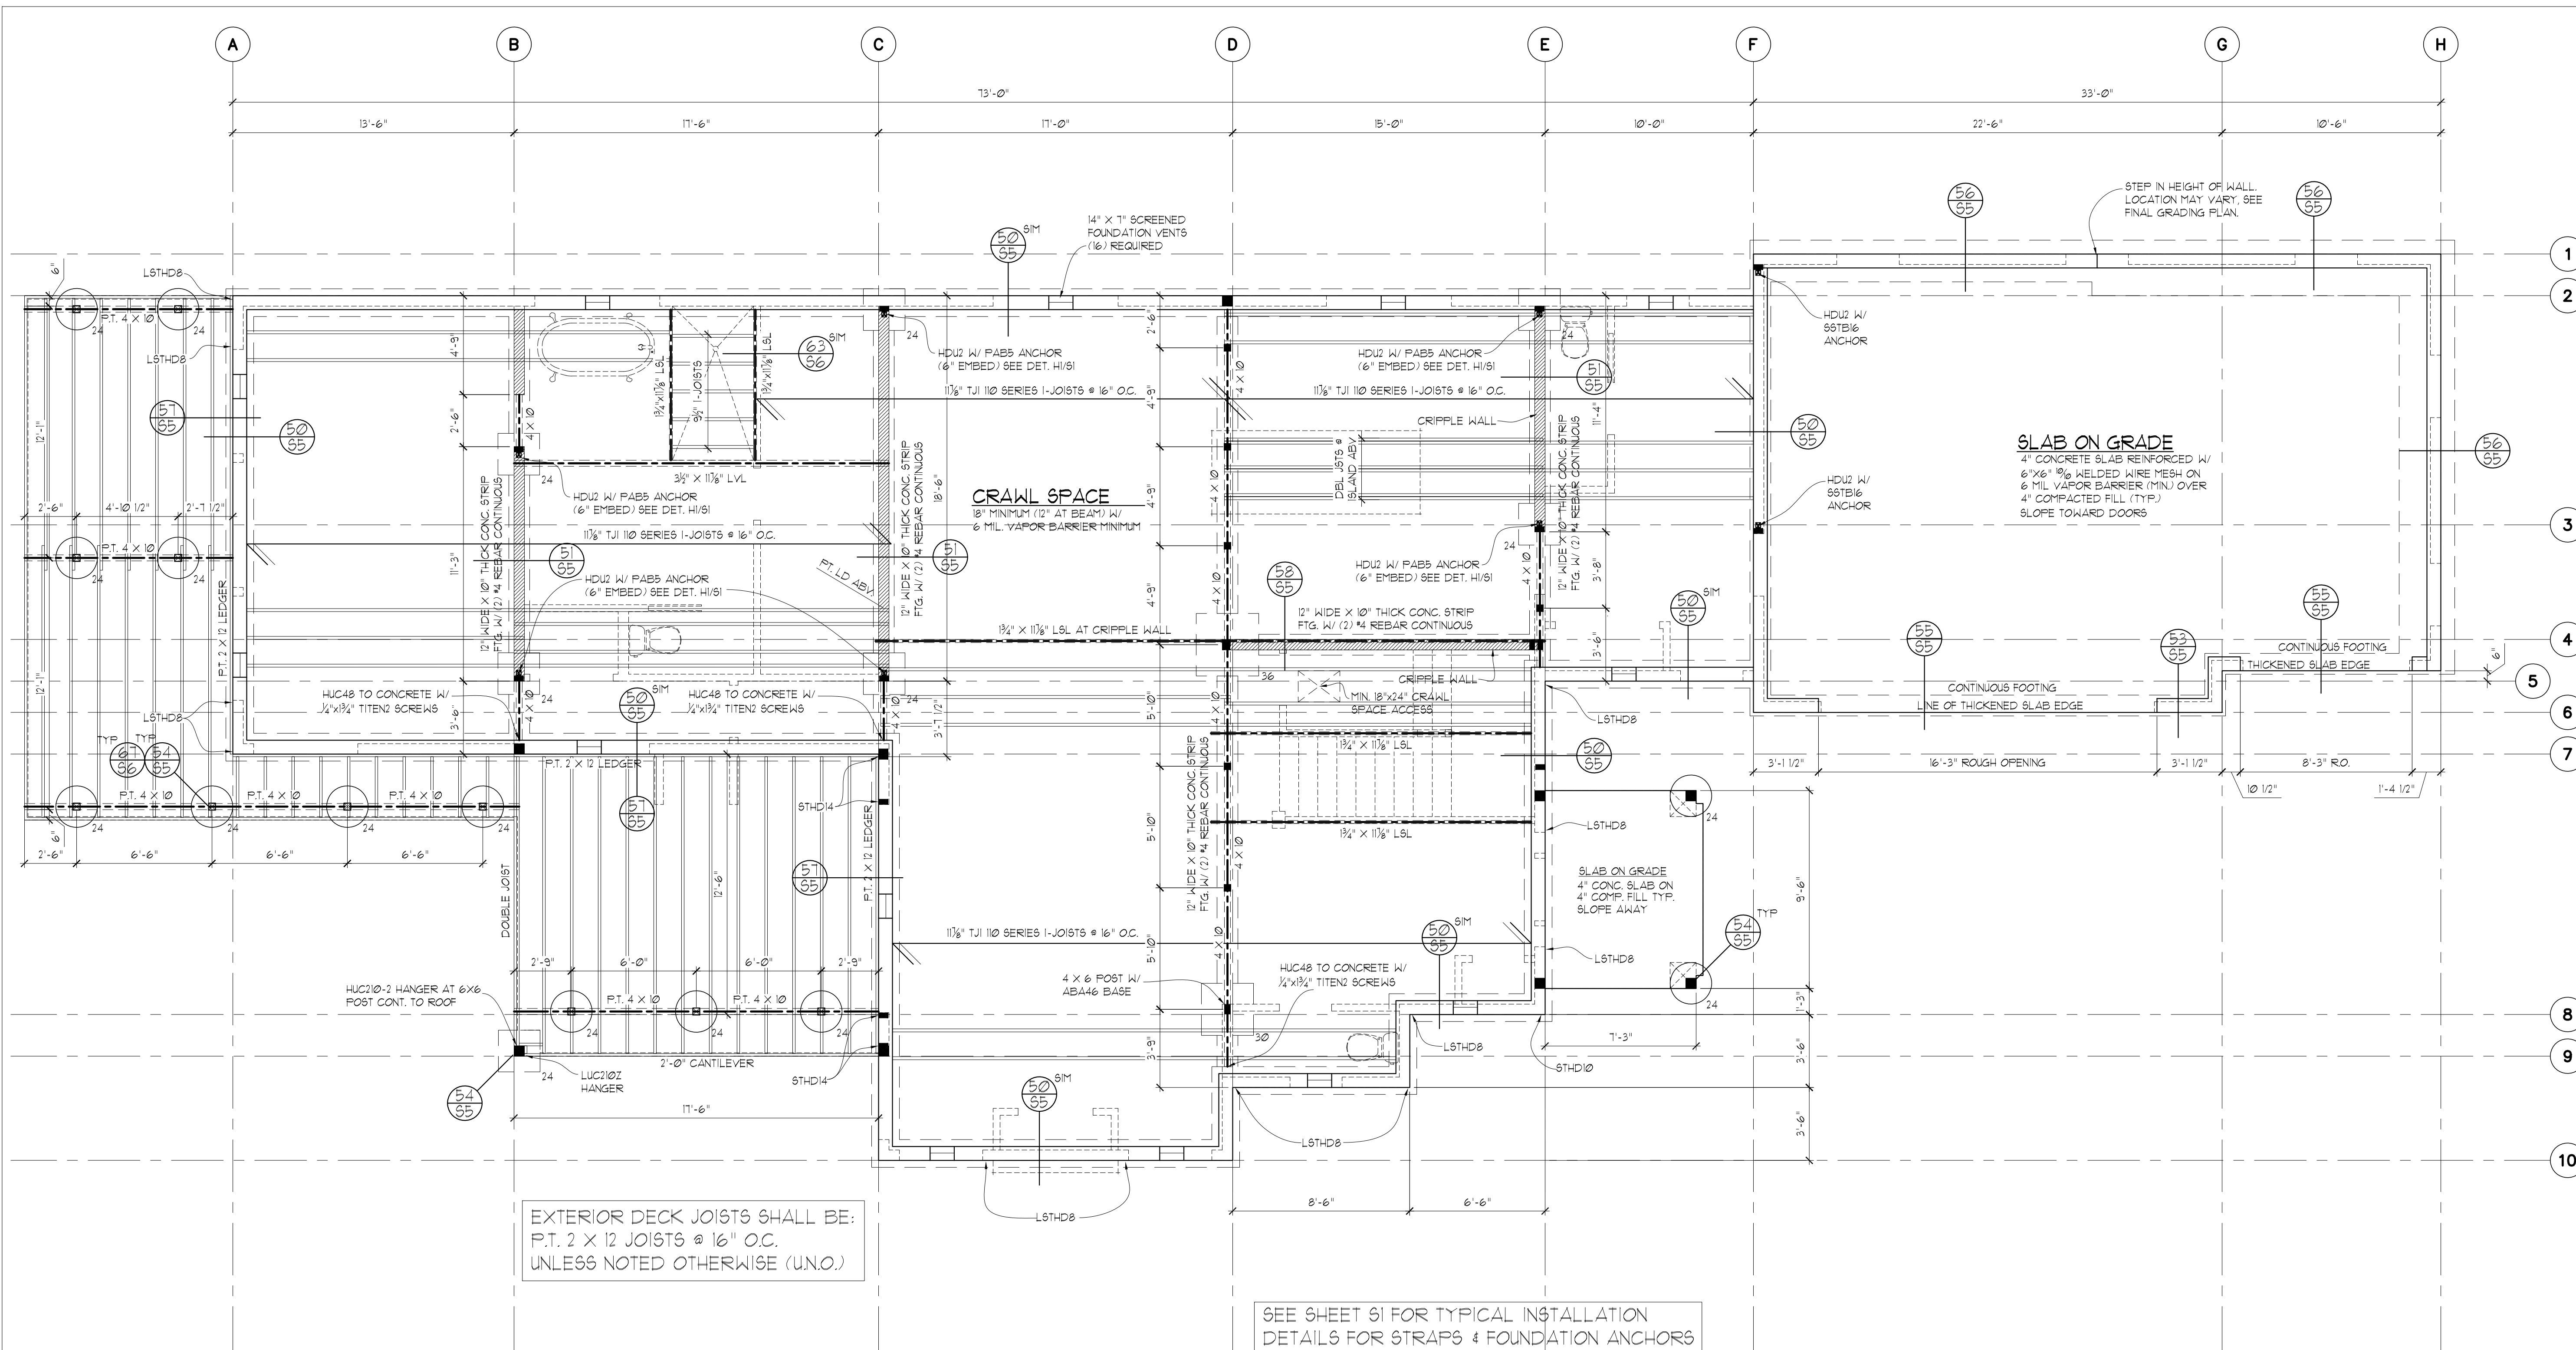

EXTERIOR DECK JOISTS SHALL BE:  
P.T. 2 X 12 JOISTS @ 16" O.C.  
UNLESS NOTED OTHERWISE (U.N.O.)

SEE SHEET S1 FOR TYPICAL INSTALLATION  
DETAILS FOR STRAPS & FOUNDATION ANCHORS


### FOUNDATION/FLOOR FRAMING PLAN

- ALL WOOD IN CONTACT WITH CONCRETE TO BE PRESSURE TREATED
- SOFFIT, VENT, AND INSULATE ALL CANTILEVERED AREAS
- PROVIDE SOLID BLOCKING OVER SUPPORTS
- ALL FOOTINGS TO REST ON UNDISTURBED SOIL
- PROVIDE SUPPLEMENTAL JOISTS/BLOCKING BELOW SHEAR WALLS AS INDICATED ON FRAMING PLAN
- PROVIDE SOLID FRAMING EQUAL TO THE WIDTH OF THE MEMBER BEING SUPPORTED (U.N.O.)
- PROVIDE SUPPLEMENTAL BLOCKING IN FLOOR CAVITY BELOW SUPPORT POSTS FOR GIRDERS AND BEAMS
- PROVIDE COPY OF CONCRETE "BATCH TICKET" ON SITE FOR REVIEW BY BUILDING OFFICIAL
- IF AN ENGINEERED JOIST FLOOR FRAMING LAYOUT IS PROVIDED BY THE JOIST SUPPLIER, THAT JOIST LAYOUT SHALL SUPERCEDE THE JOIST LAYOUT INDICATED IN THE PLANS. PROVIDE I-JOIST LAYOUT AND SPECS ON SITE FOR INSPECTION.


SCALE : 1/4" = 1'-0"

FOOTING SCHEDULE		NOTE: USE MIN. 6" WIDE POST BELOW BEAM SPLICES USE P.T. 4 X 4 POSTS BELOW 4 X BEAMS U.N.O. USE P.T. 6 X 6 POST BELOW 6 X BEAMS U.N.O.
24	P.T. POST ON 24" DIA. X 10" THICK PLAIN CONC. FOOTING	
24	P.T. POST ON 24" X 24" X 10" THICK CONC. FOOTING W/ 2- # 4 BARS EACH WAY	
30	P.T. POST ON 30" X 30" X 12" THICK CONC. FOOTING W/ 3- # 5 BARS EACH WAY	
36	P.T. POST ON 36" X 36" X 12" THICK CONC. FOOTING W/ 3- # 5 BARS EACH WAY	
42	P.T. POST ON 42" X 42" X 12" THICK CONC. FOOTING W/ 4- # 5 BARS EACH WAY	

FOOTING SIZES BASED ON 1500 PSF SOIL BEARING CAPACITY

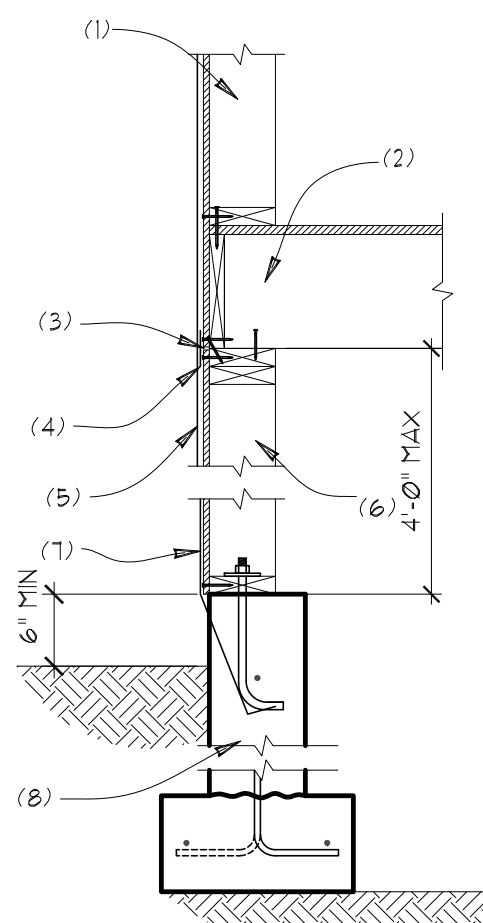

A1 CRIPPLE WALL FOR SLOPED LOTS  
SCALE: 3/4" = 1'

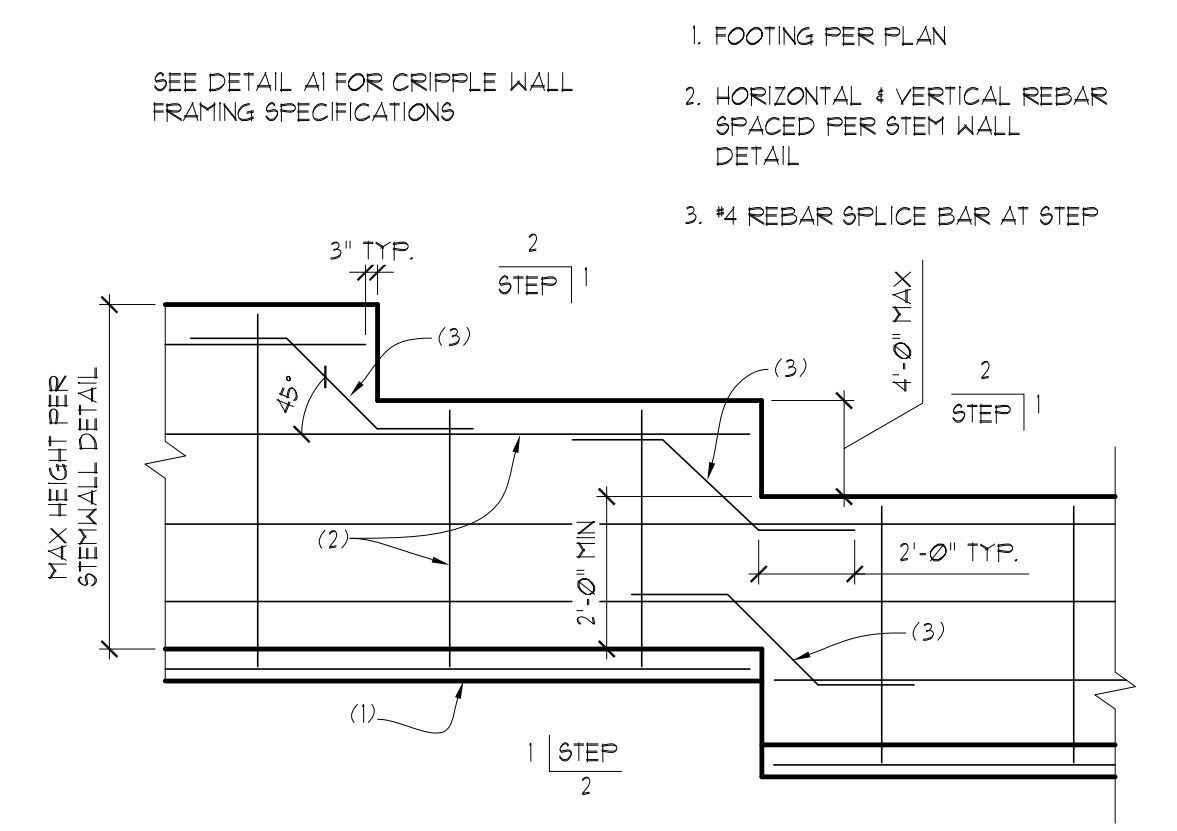

A2 STEPPED FOOTING AT SLOPED LOT  
SCALE: NTS

**STRUCTURAL PLANS**  
**MARBELLA RESIDENCE**  
**7311 W. MERCER WAY**  
**MERCER ISLAND, WA**

**Myers Engineering, LLC**  
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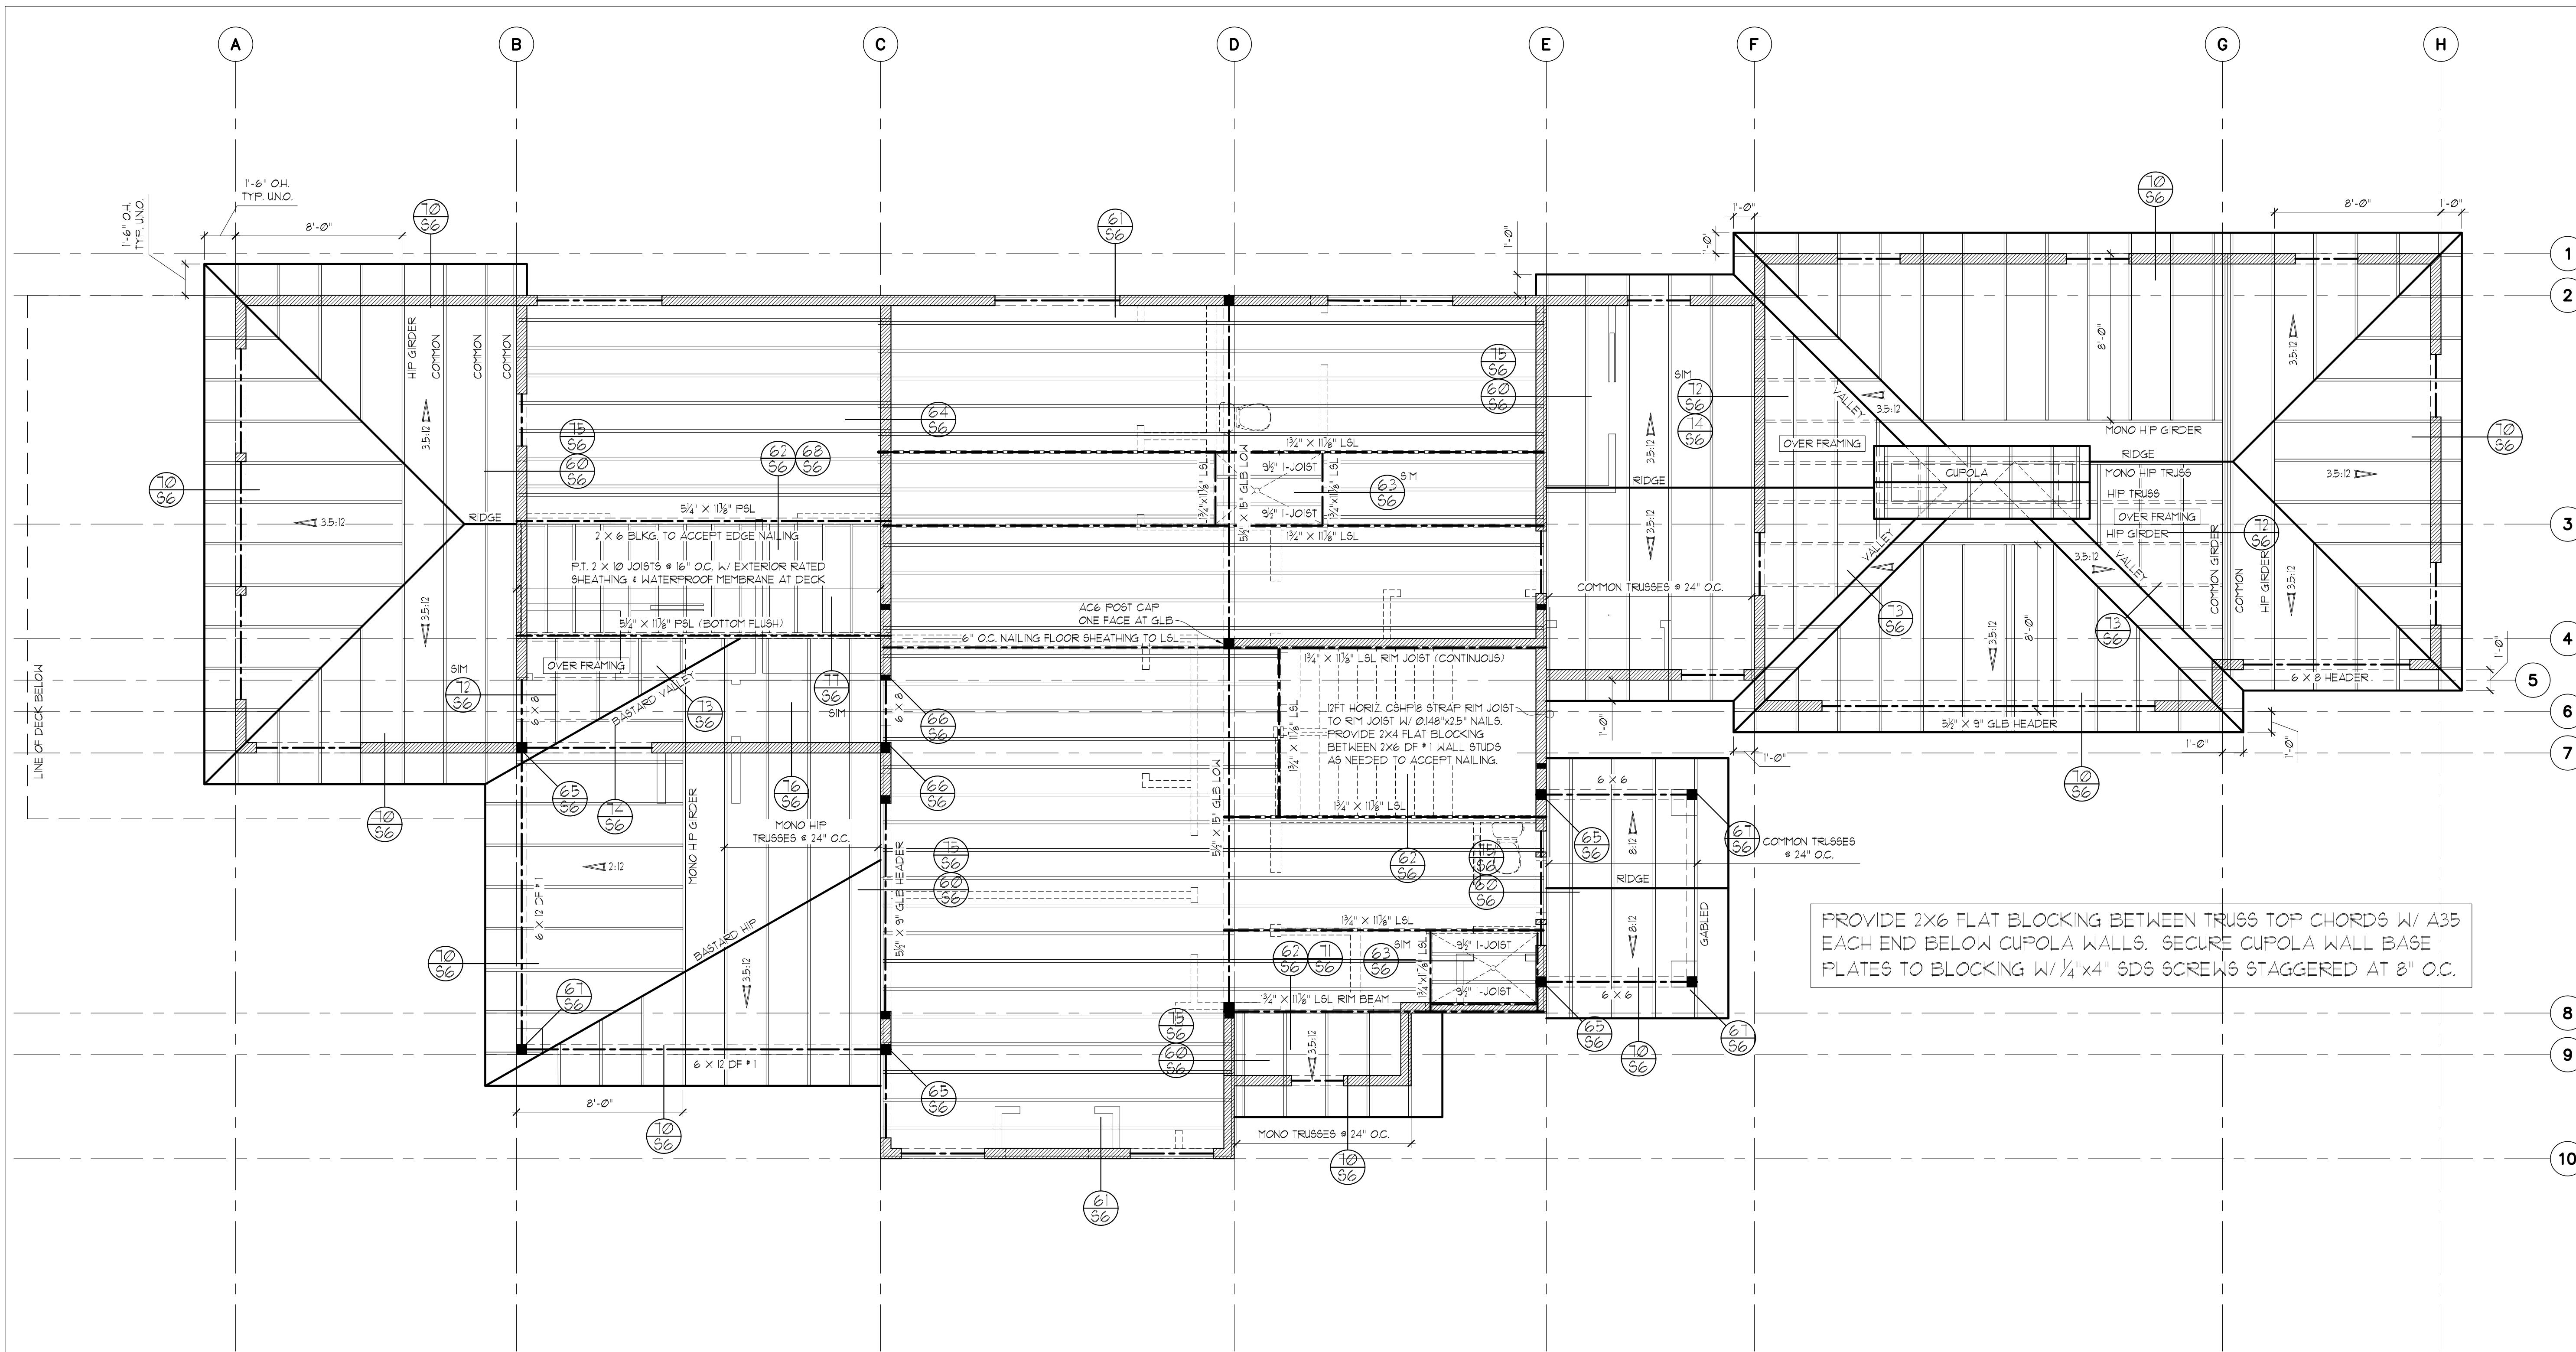


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REVISION DATE:	INIT:	PROJECT #:

<b>S2</b>	DATE: 8-31-2020
	INIT: MM
PROJECT #: 2302	



UPPER FLOOR JOISTS SHALL BE:  
 11 7/8" TJI 110 SERIES I-JOISTS @ 16" O.C.  
 UNLESS NOTED OTHERWISE (U.N.O.)

DROPPED FRAMING FOR FLUSH ENTRY SHOWERS:  
 PROVIDE 2X6 LEDGERS & BLOCKING AROUND PERIMETER TO ACCEPT EDGE NAILING. SECURE 2X6 TO PERIMETER FRAMING W/ 10d COMMON NAILS (0.148"x3") STAGGERED AT 6" O.C.

### UPPER FLOOR FRAMING PLAN


SCALE : 1/4" = 1'-0"

- SOFFIT, VENT, AND INSULATE ALL CANTILEVERED AREAS
- EXTERIOR WALLS TO BE 2X6 AT 16" O.C., U.N.O.
- ALL DOOR/WINDOW HEADERS AT THIS LEVEL TO BE 4X10 DF #2 AT BEARING WALLS, U.N.O., 6'-0" MAX. SPAN
- INTERIOR PARTITIONS TO BE 2X4 AT 16" O.C. (2X6 @ PLUMBING WALLS) U.N.O.
- PROVIDE SUPPLEMENTAL JOISTS/BLOCKING BELOW SHEAR WALLS AS INDICATED ON FRAMING PLAN
- HEADERS 8FT OR LONGER SHALL BE PROVIDED W/ (2) TRIMMER (JACK) STUDS AT EACH END U.N.O.
- PROVIDE SOLID FRAMING EQUAL TO THE WIDTH OF THE MEMBER BEING SUPPORTED (U.N.O.)
- PROVIDE SUPPLEMENTAL BLOCKING IN FLOOR CAVITY BELOW SUPPORT POSTS FOR GIRDERS AND BEAMS AND PROVIDE MATCHING POSTS IN WALL BELOW
- IF AN ENGINEERED JOIST FLOOR FRAMING LAYOUT IS PROVIDED BY THE JOIST SUPPLIER, THAT JOIST LAYOUT SHALL SUPERCEDE THE JOIST LAYOUT INDICATED IN THE PLANS. PROVIDE I-JOIST LAYOUT AND SPECS ON SITE FOR INSPECTION.

## STRUCTURAL PLANS

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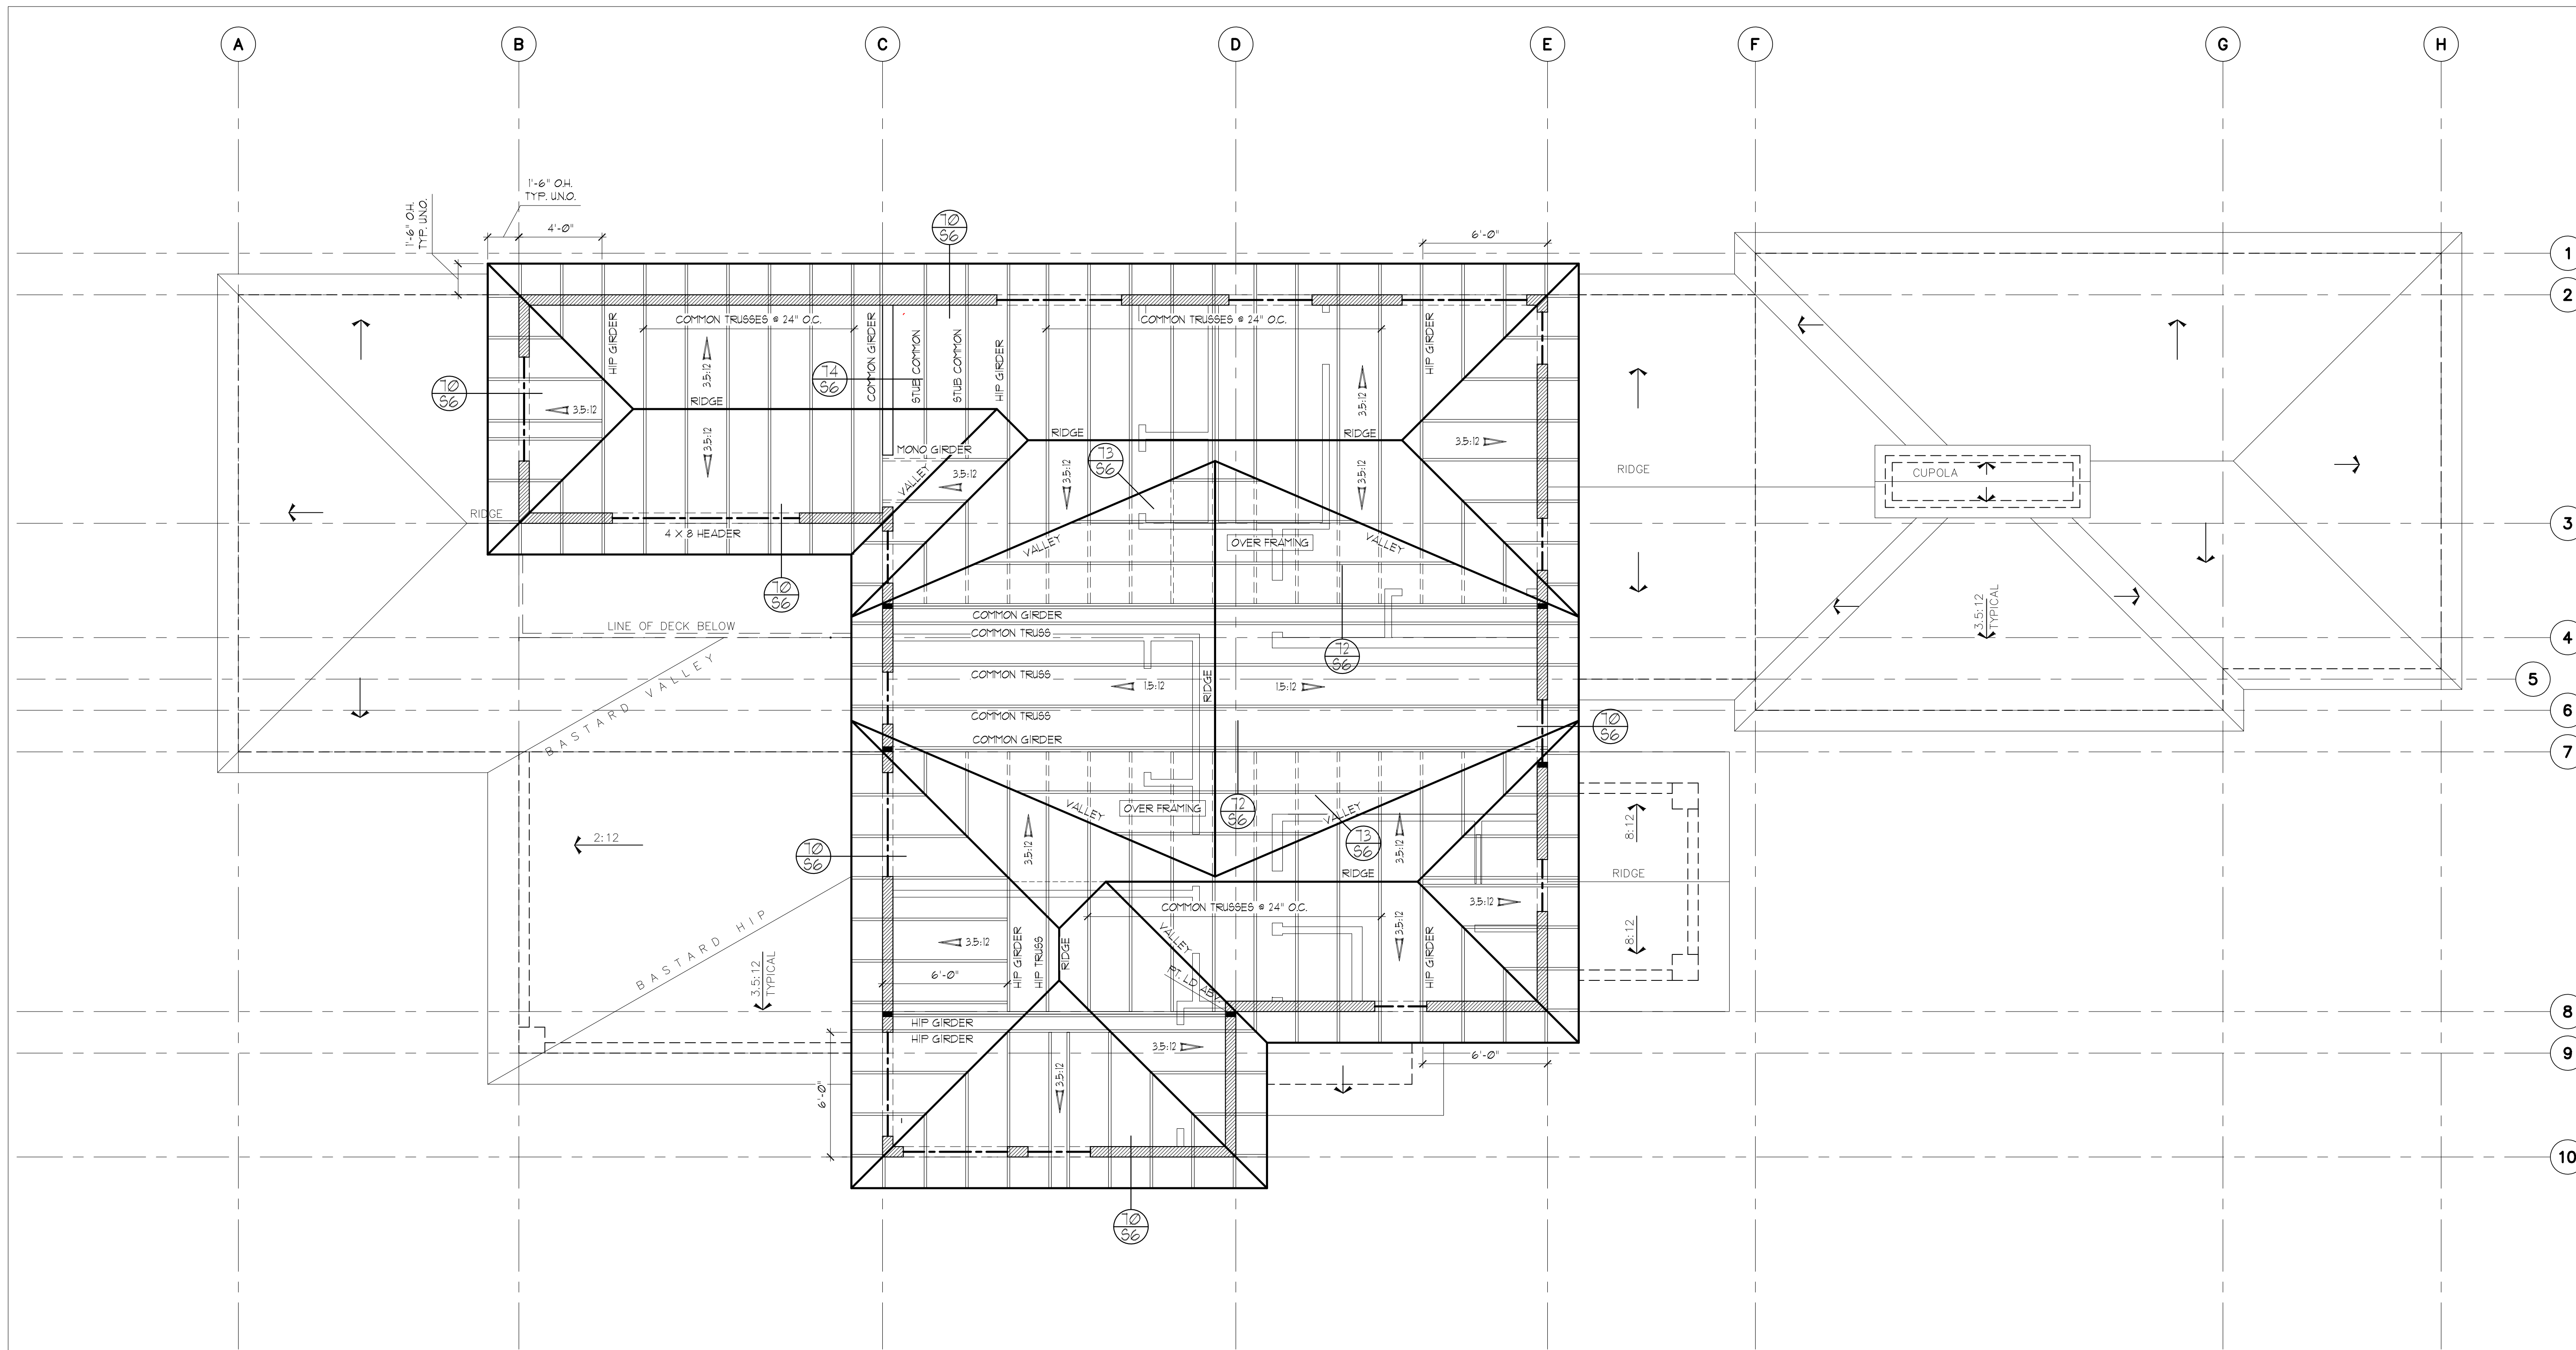


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# STRUCTURAL PLANS
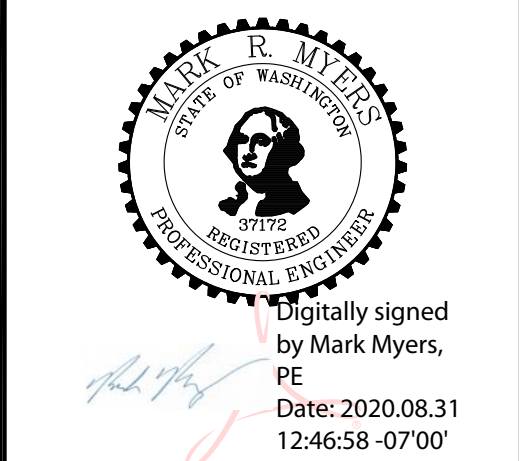
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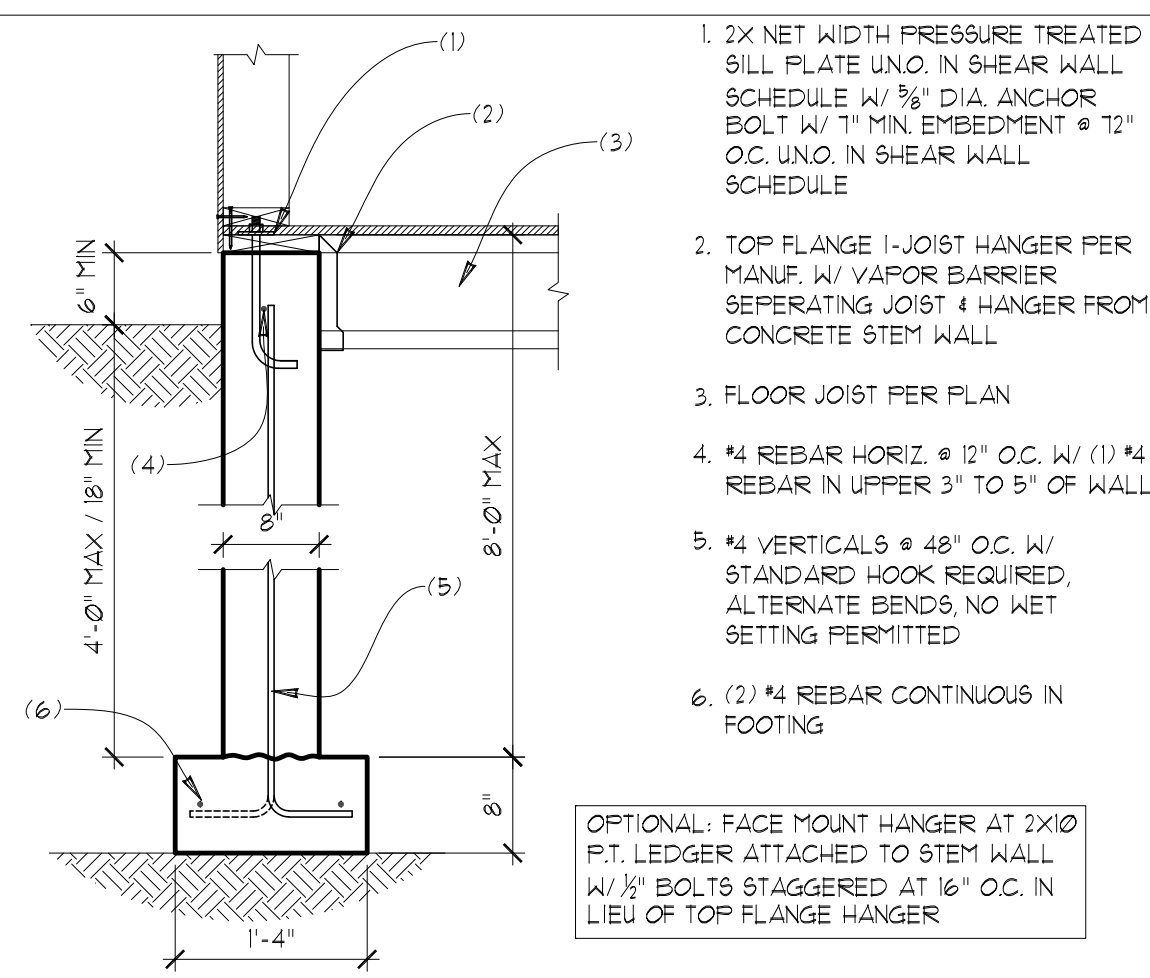
## ROOF FRAMING PLAN

SCALE : 1/4" = 1'-0"

- PROVIDE VENTED BLOCKING AT REQUIRED TRUSS/RAFTER BAYS
- ALL MANUFACTURED TRUSSES:
  - \* SHALL HAVE DESIGN DETAILS AND DRAWINGS ON SITE FOR FRAMING INSPECTION
  - \* SHALL NOT BE FIELD ALTERED WITHOUT ENGINEER'S APPROVAL
  - \* SHALL BE INSTALLED AND BRACED TO MANUFACTURER'S SPECIFICATION
  - \* SHALL CARRY MANUFACTURER'S STAMP ON EACH TRUSS
- ALL BEAMS AND HEADERS AT THIS LEVEL TO BE 4X8 DF #2 AT BEARING WALLS, U.N.O., 6'-0" MAX. SPAN
- HEADERS 8FT OR LONGER SHALL BE PROVIDED W/ (2) TRIMMER (JACK) STUDS AT EACH END U.N.O.
- PROVIDE SOLID FRAMING EQUAL TO THE WIDTH OF THE MEMBER BEING SUPPORTED (U.N.O.)
- PROVIDE SUPPLEMENTAL BLOCKING IN FLOOR CAVITY BELOW SUPPORT POSTS FOR GIRDERS AND BEAMS AND PROVIDE MATCHING POSTS IN WALL BELOW

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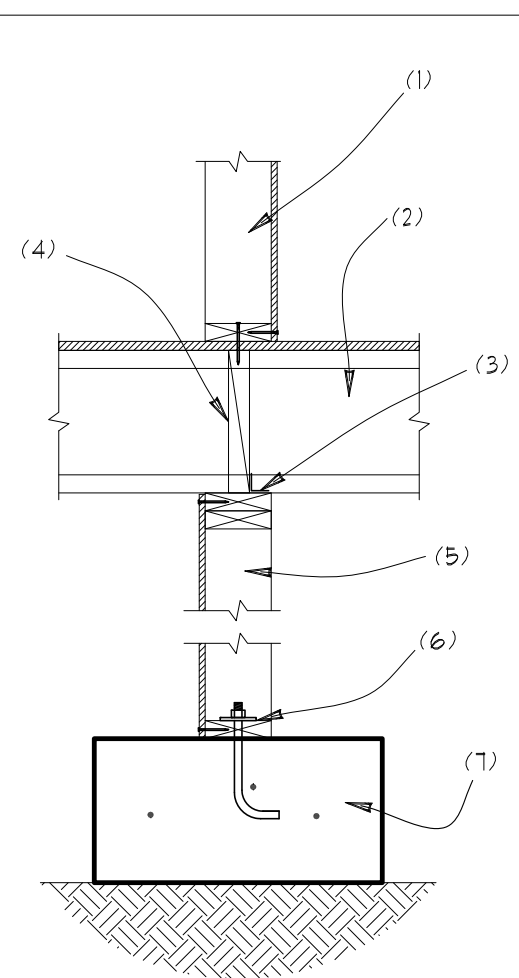
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	INIT: MM
	PROJECT #: 2302



50 8" STEM WALL AT DROPPED JOISTS  
SCALE: 3/4"=1'


- 2x NET WIDTH PRESSURE TREATED SILL PLATE UNO. IN SHEAR WALL SCHEDULE W/ 3/8" DIA. ANCHOR BOLT W/ 1" MIN. EMBEDMENT @ 12" O.C. UNO. IN SHEAR WALL SCHEDULE
- TOP FLANGE 1-JOIST HANGER PER MANUF. W/ VAPOR BARRIER SEPARATING JOIST + HANGER FROM CONCRETE STEM WALL
- FLOOR JOIST PER PLAN
- #4 REBAR HORIZ. @ 12" O.C. W/ (1) #4 REBAR IN UPPER 3" TO 5" OF WALL
- #4 VERTICALS @ 48" O.C. W/ STANDARD HOOK REQUIRED. ALTERNATE BENDS, NO WET SETTING PERMITTED
- (2) #4 REBAR CONTINUOUS IN FOOTING

OPTIONAL: FACE MOUNT HANGER AT 2x10 P.T. LEDGER ATTACHED TO STEM WALL W/ 1/2" BOLTS STAGGERED AT 16" O.C. IN LIEU OF TOP FLANGE HANGER




51 CRIPPLE WALL BEARING WALL  
SCALE: 3/4"=1'

- SHEAR WALL W/ NAILING PER SHEAR WALL SCHEDULE
- JOIST PER PLAN
- SIMPSON A35 @ 16" O.C.
- L&L BLOCKING TO MATCH JOISTS
- CRIPPLE WALL W/ STUDS @ 16" O.C. SHEATHED + NAILED PER SCHEDULE FOR SHEAR WALL ABOVE
- PRESSURE TREATED SILL PLATE
- FOOTING PER PLAN W/ 3/8" DIA. ANCHOR BOLTS PER SHEAR WALL SCHEDULE

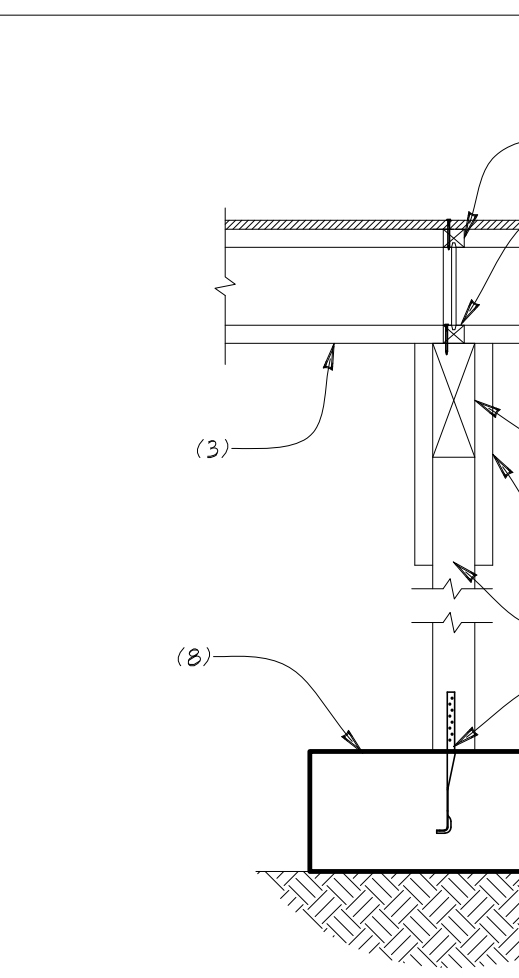


52 INTERIOR FOOTING @ BEAM LINE  
SCALE: 3/4"=1'

- 1-JOIST BLOCKING REQUIRED AT BEARING OR SHEAR WALLS ABOVE OR WHEN JOISTS ARE NOT CONTINUOUS AT BEAM
- SECURE BLOCKING TO BEAM W/ 8d NAILS @ 6" O.C.
- 1-JOIST PER PLAN
- BEAM PER PLAN
- 2x OR SHEATHING CLEATS BOTH SIDES TO SECURE BEAM TO POST (2) 10d NAILS PER CLEAT PER MEMBER
- 4x OR 6x TREATED POST (4x6 MIN AT BEAM SPLICE)
- SIMPSON MAB15 ANCHOR W/ 10dX1/2" COMMON NAILS (Ø1/4"x1/2") TO POST
- ISOLATED OR CONTINUOUS SPREAD FOOTING PER PLAN

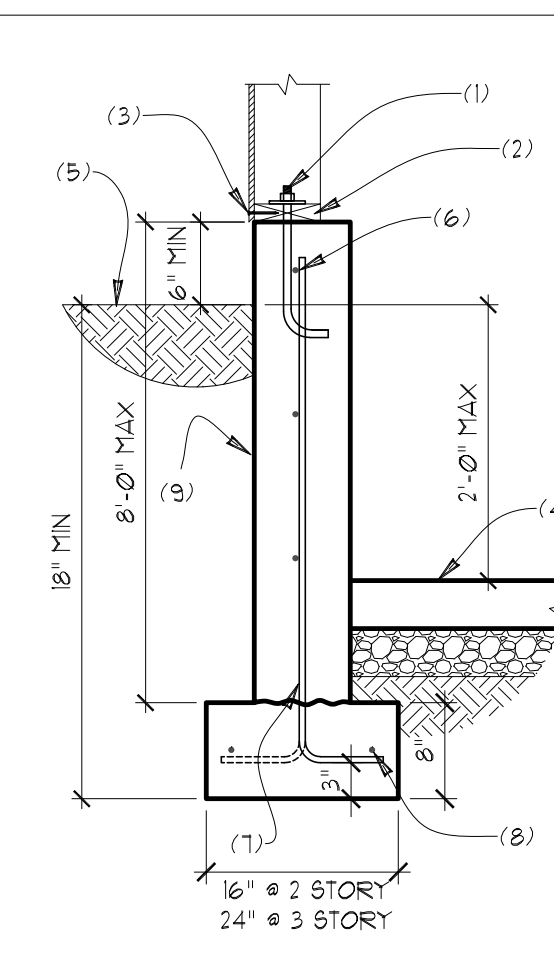


53 8" STEM WALL AT SLAB ON GRADE  
SCALE: 3/4"=1'

- 3/8" DIA. ANCHOR BOLT @ 12" O.C. UNO. IN SHEAR WALL SCHEDULE W/ 1" MIN. EMBEDMENT
- 2x PRESSURE TREATED SILL PLATE UNO. IN SHEAR WALL SCHEDULE
- SHEAR WALL EDGE NAILING PER SHEAR WALL SCHEDULE
- 4" CONCRETE SLAB OVER 4" COMPACT FILL
- FINISH GRADE OR SLAB AS OCCURS
- #4 HORIZ. REBAR @ 12" O.C. W/ (1) #4 REBAR IN UPPER 3" TO 5" OF WALL
- #4 VERTICALS @ 18" O.C. W/ STANDARD HOOK REQUIRED. ALTERNATE BENDS, NO WET SETTING PERMITTED
- (2) #4 REBAR CONTINUOUS IN FOOTING
- INSTALL DAMPPROOFING OR WATERPROOFING PER IRC R406 WHERE INTERIOR SLAB IS BELOW EXTERIOR GRADE

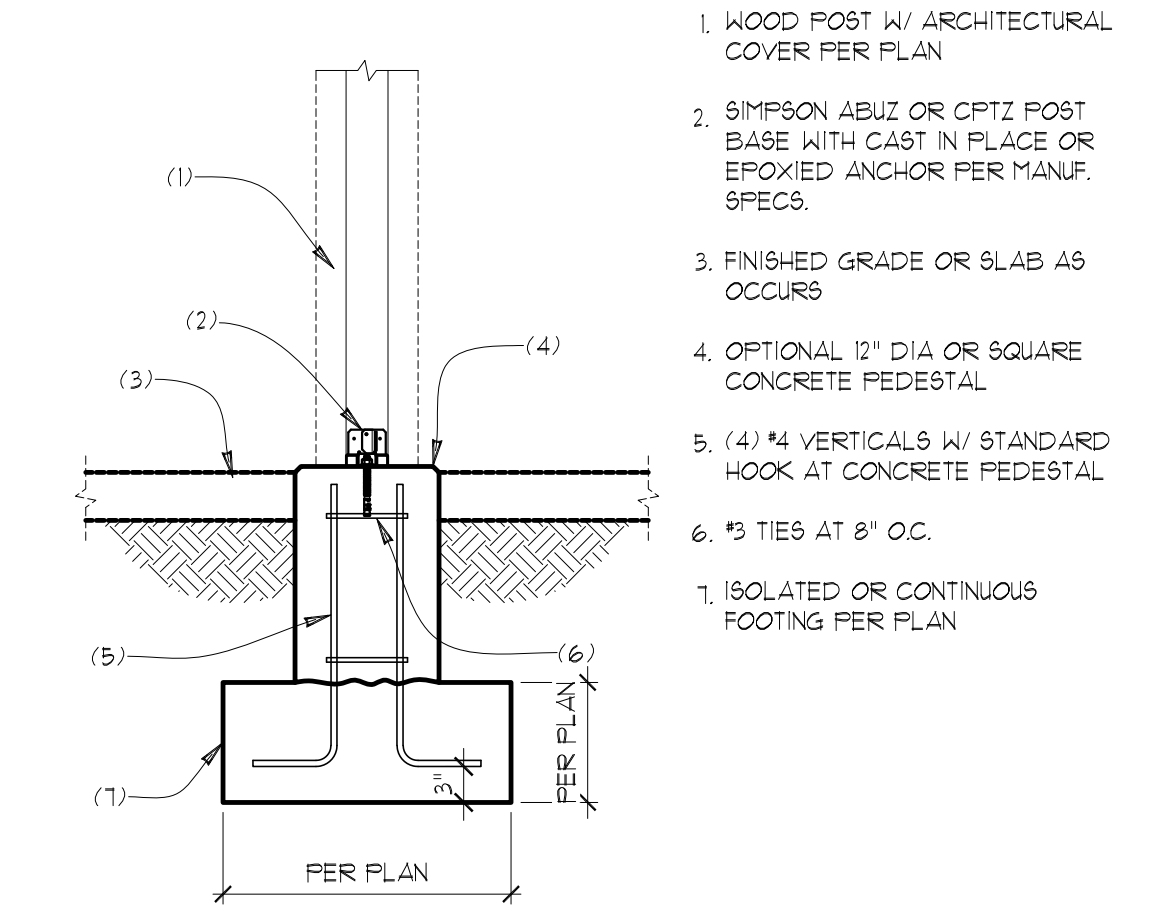


54 FOOTING AT WOOD COLUMN  
SCALE: 3/4"=1'

- WOOD POST W/ ARCHITECTURAL COVER PER PLAN
- SIMPSON ABUZ OR OPTZ POST BASE WITH CAST IN PLACE OR EPOXYED ANCHOR PER MANUF. SPECS.
- FINISHED GRADE OR SLAB AS OCCURS
- OPTIONAL 12" DIA OR SQUARE CONCRETE PEDESTAL
- (4) #4 VERTICALS W/ STANDARD HOOK AT CONCRETE PEDESTAL
- #3 TIES AT 8" O.C.
- ISOLATED OR CONTINUOUS FOOTING PER PLAN

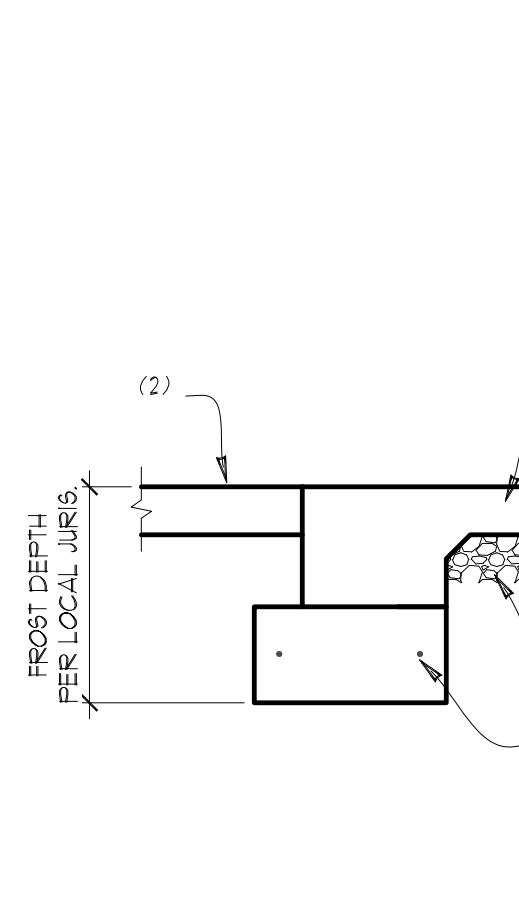

55 THICKENED SLAB EDGE AT GARAGE  
SCALE: 3/4"=1'

- 4" CONCRETE SLAB PER PLAN W/ THICKENED EDGE AT DOOR OPENING
- FINISH GRADE OR SLAB AS OCCURS
- (2) #4 REBAR IN CONTINUOUS FOOTING
- 4" COMPACTED GRANULAR FILL

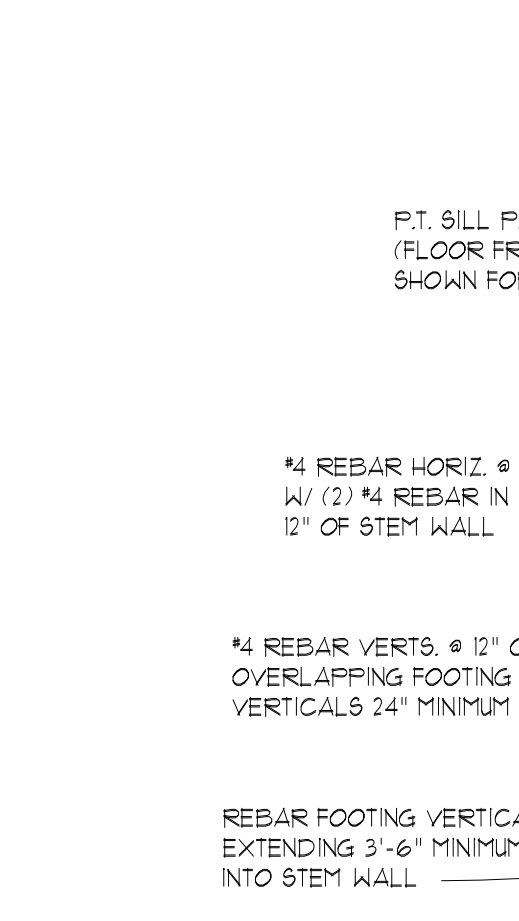


56 CANTILEVER RETAINING WALL  
SCALE: 1/2"=1'

- 4" CONCRETE SLAB PER PLAN W/ THICKENED EDGE AT DOOR OPENING
- FINISH GRADE OR SLAB AS OCCURS
- (2) #4 REBAR IN CONTINUOUS FOOTING
- 4" COMPACTED GRANULAR FILL

DESIGN CRITERIA:  
1500 PSF ALLOWABLE SOIL BEARING PRESSURE  
35 PCF ACTIVE EARTH PRESSURE  
300 PCF PASSIVE EARTH PRESSURE  
0.35 COEFFICIENT OF FRICTION


BACKFILL FOUNDATION WALLS WITH 18" OF PROPERLY COMPACTED GRANULAR FILL CONTAINING LESS THAN 5% FINES TO WITHIN 12" OF FINAL GRADE (COMPACT TO 92% OF MAX DRY DENSITY PER MODIFIED PROCTOR METHOD)  
INSTALL 4" DIA. PERFORATED SMOOTH PVC FOOTING DRAINS ALONG THE BASE OF THE DRAINAGE ZONE BEHIND THE WALL TO DIRECT ANY ACCUMULATED WATER TO AN APPROPRIATE DISCHARGE. A NONWOVEN GEOTEXTILE FILTER FABRIC SHALL BE PLACED BETWEEN THE DRAINAGE MATERIAL AND THE REMAINING WALL BACKFILL. FILTER FABRIC SHALL EXTEND OVER THE TOP OF THE DRAINAGE MATERIAL.

RETAINED HEIGHT	FOOTING WIDTH	FOOTING VERTICALS	FOOTING REBAR	FOOTING THICKNESS
3'-0"	2'-0"	#4 REBAR @ 10" O.C.	N/A	10"
5'-0"	2'-8"	#4 REBAR @ 10" O.C.	N/A	10"
7'-0"	3'-8"	#4 REBAR @ 6" O.C.	#4 REBAR @ 9" O.C.	10"

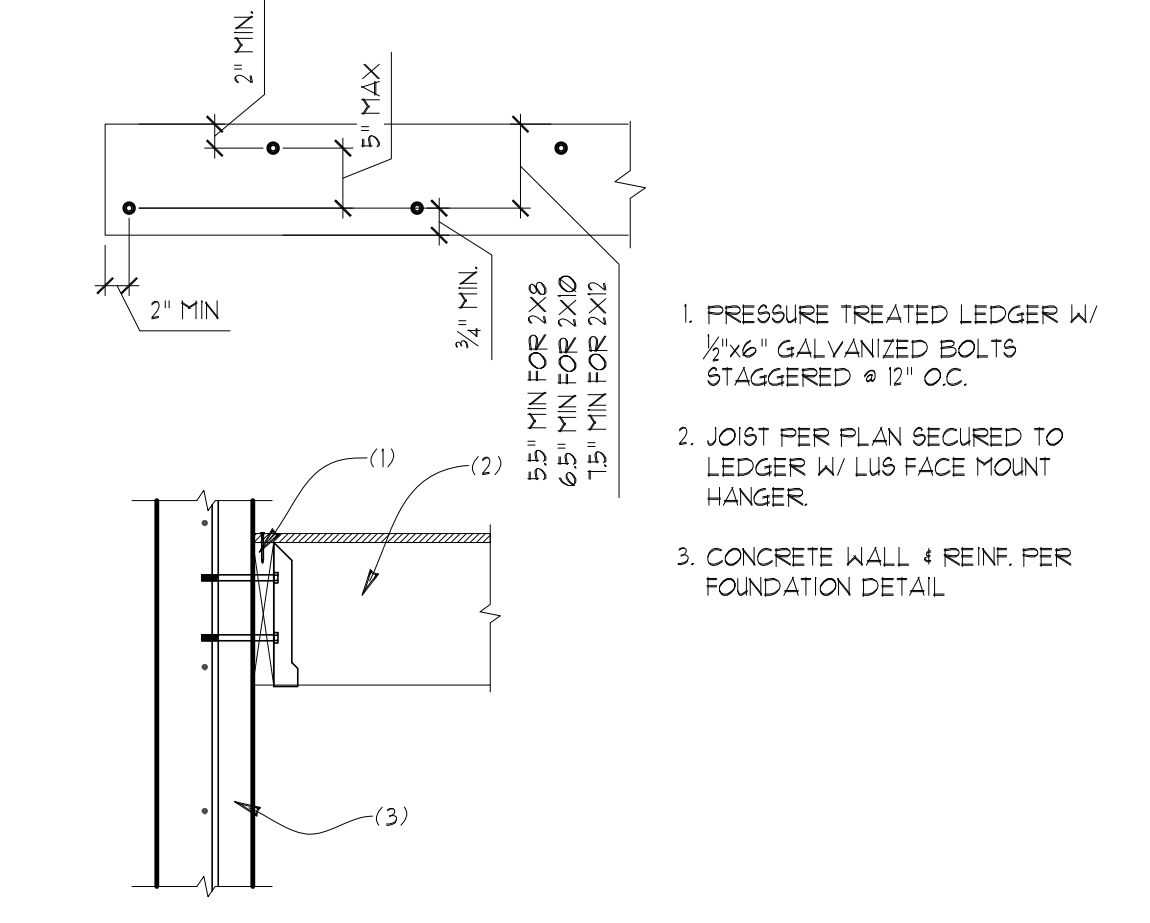

57 LEDGER AT CONCRETE WALL  
SCALE: 3/4"=1'

- PRESSURE TREATED LEDGER W/ 1/2"x6" GALVANIZED BOLTS STAGGERED @ 12" O.C.
- JOIST PER PLAN SECURED TO LEDGER W/ LUS FACE MOUNT HANGER
- CONCRETE WALL + REINF. PER FOUNDATION DETAIL

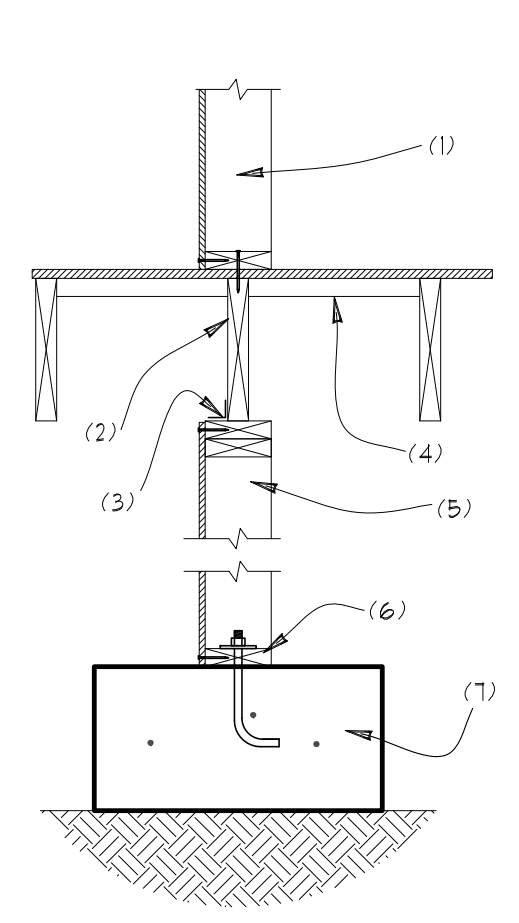

58 CRIPPLE WALL BELOW SHEAR WALL  
SCALE: 3/4"=1'

- 2x SHEAR WALL W/ NAILING PER SHEAR WALL SCHEDULE
- JOIST PER PLAN
- SIMPSON A35 @ 12" O.C.
- 2x4 FLAT BLOCKING AT 24" O.C.
- 2x6 CRIPPLE WALL W/ STUDS @ 16" O.C. SHEATHED + NAILED W/ 8d NAILS @ 4" O.C. EDGE + 12" O.C. FIELD
- 2x6 PRESSURE TREATED SILL PLATE
- FOOTING PER PLAN W/ 3/8" DIA. ANCHOR BOLTS PER SHEAR WALL SCHEDULE

**STRUCTURAL PLANS**  
**MARBELLA RESIDENCE**  
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**MERCER ISLAND, WA**


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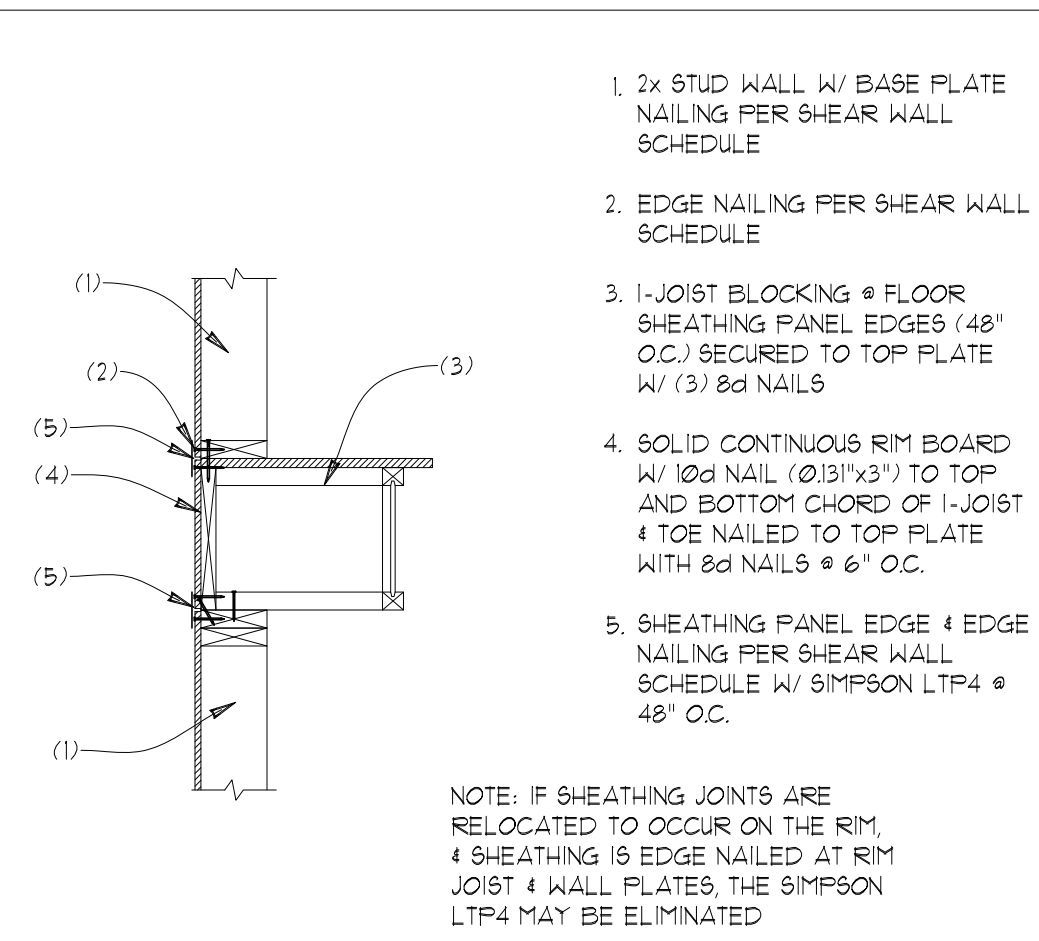
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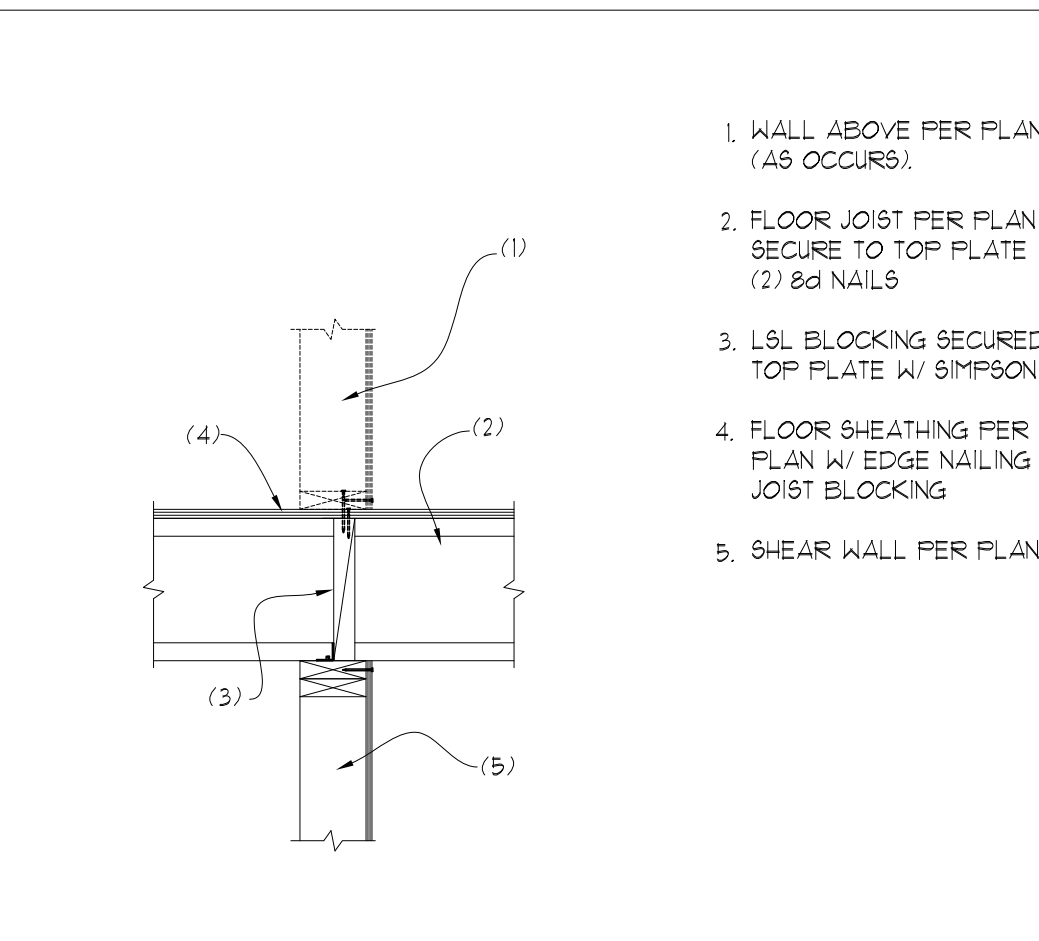
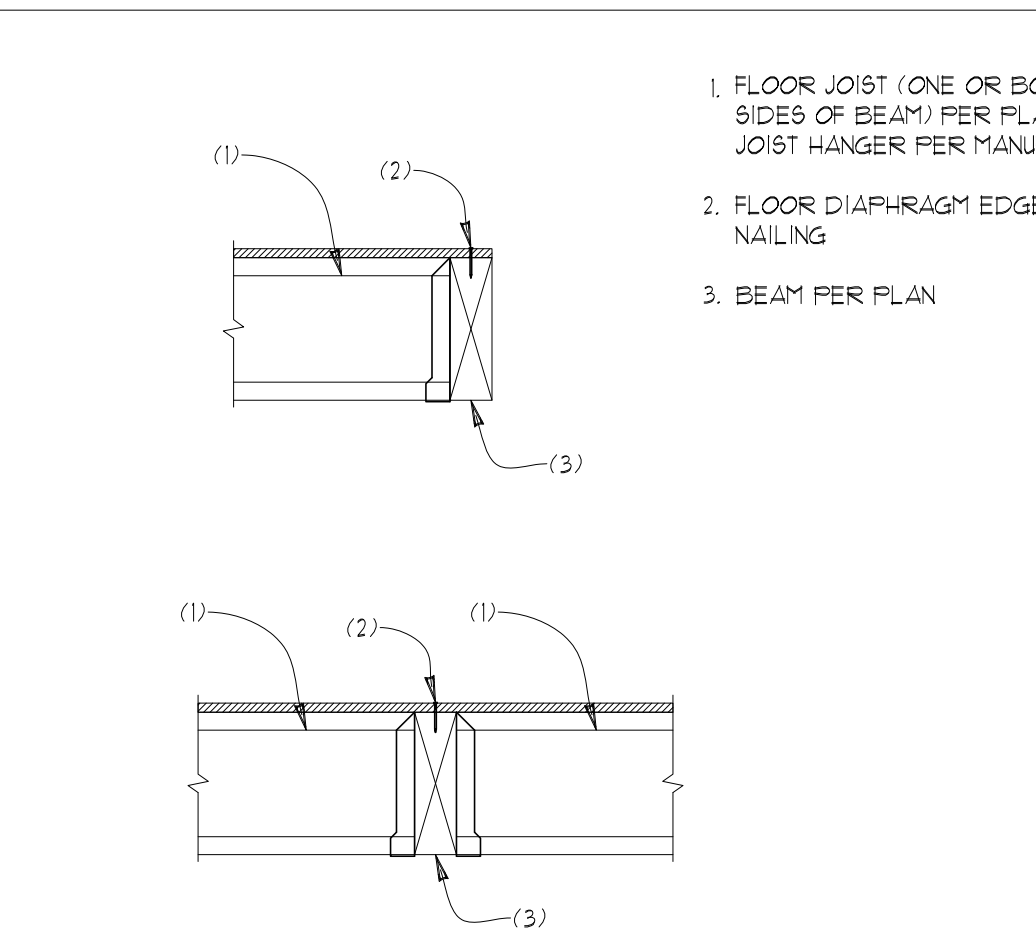
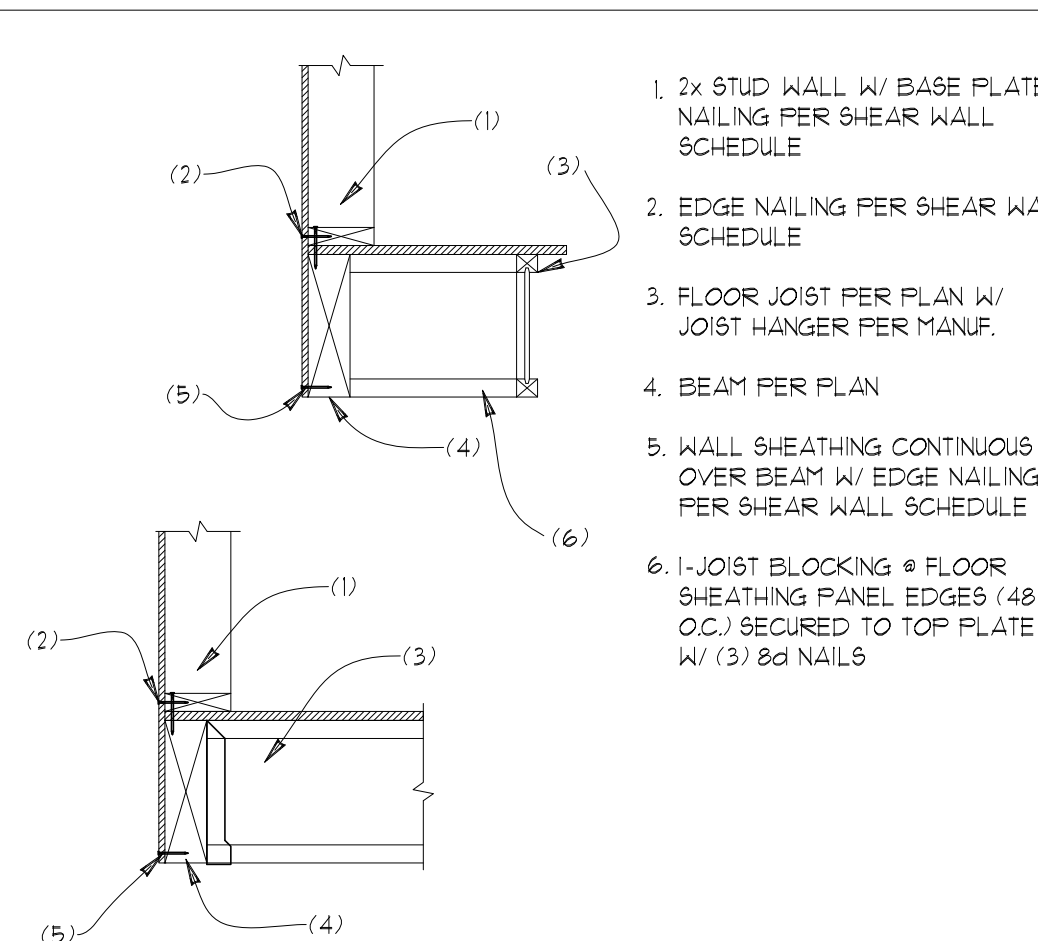
**S5**  
DATE:  
8-31-2020  
INIT:  
MM  
PROJECT #:  
2302



NOTE: IF SHEATHING JOINTS ARE RELOCATED TO OCCUR ON THE RIM, SHEATHING IS EDGE NAILED AT RIM JOIST & WALL PLATES, THE SIMPSON LTP4 MAY BE ELIMINATED



NOTE: IF SHEATHING JOINTS ARE RELOCATED TO OCCUR ON THE RIM, SHEATHING IS EDGE NAILED AT RIM JOIST & WALL PLATES, THE SIMPSON LTP4 MAY BE ELIMINATED

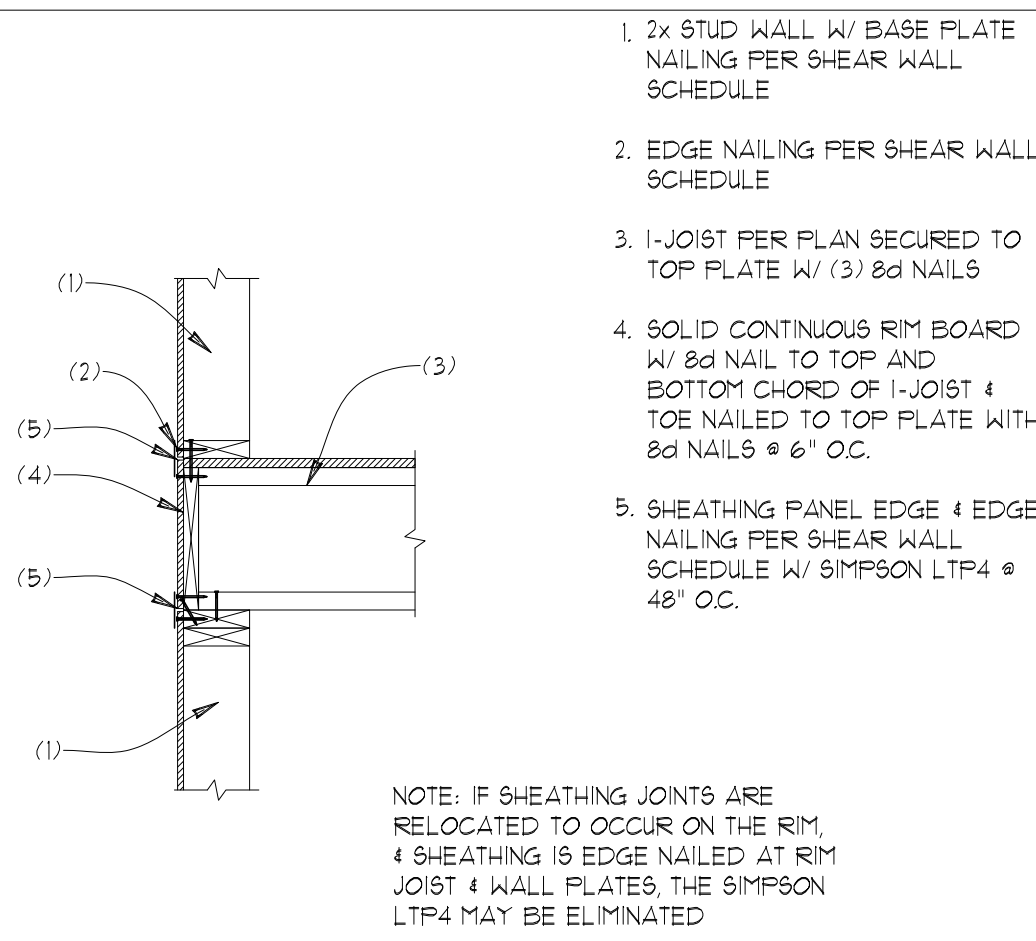






60 FLOOR JOIST BEARING AT STUD WALL  
SCALE: 3/4"=1"

61 FLOOR JOIST PARALLEL TO STUD WALL  
SCALE: 3/4"=1"

62 FLOOR JOIST AT BEAM  
SCALE: 3/4"=1"

63 FLOOR JOIST AT BEAM  
SCALE: 3/4"=1"

64 FLOOR JOIST AT INT. SHEAR WALL  
SCALE: 3/4"=1"

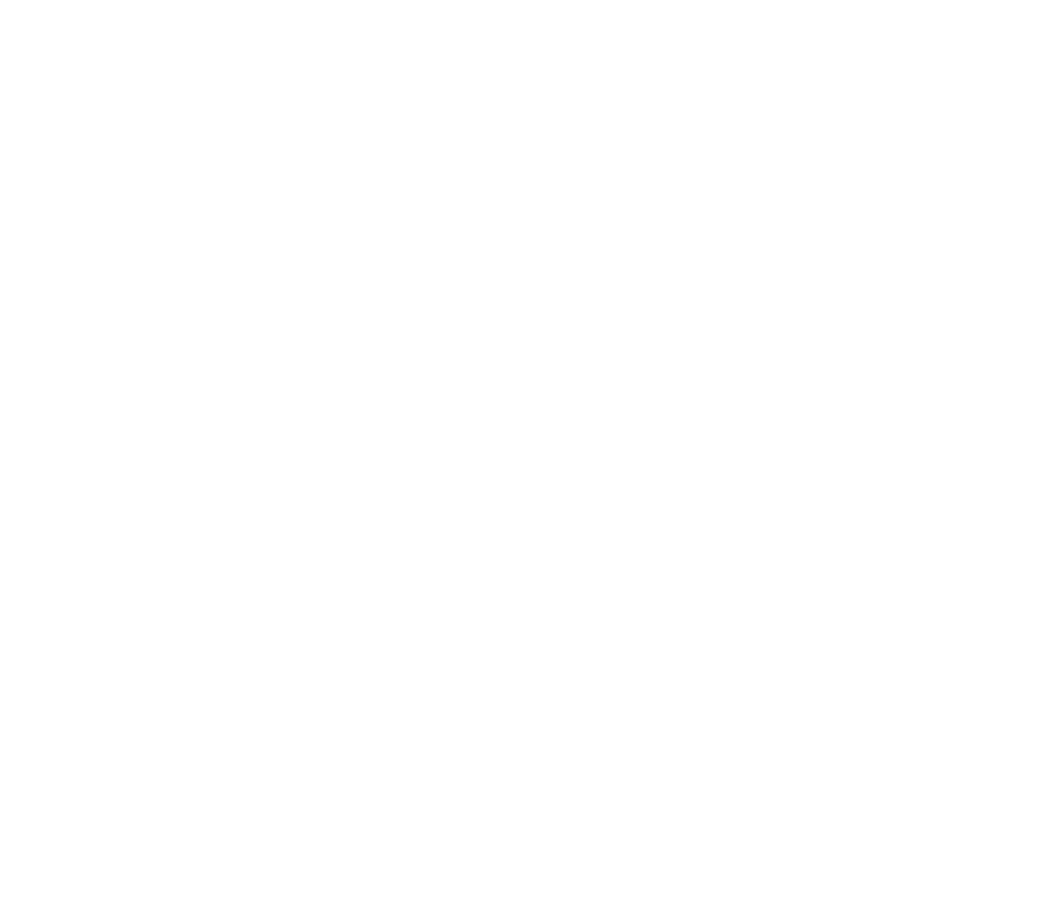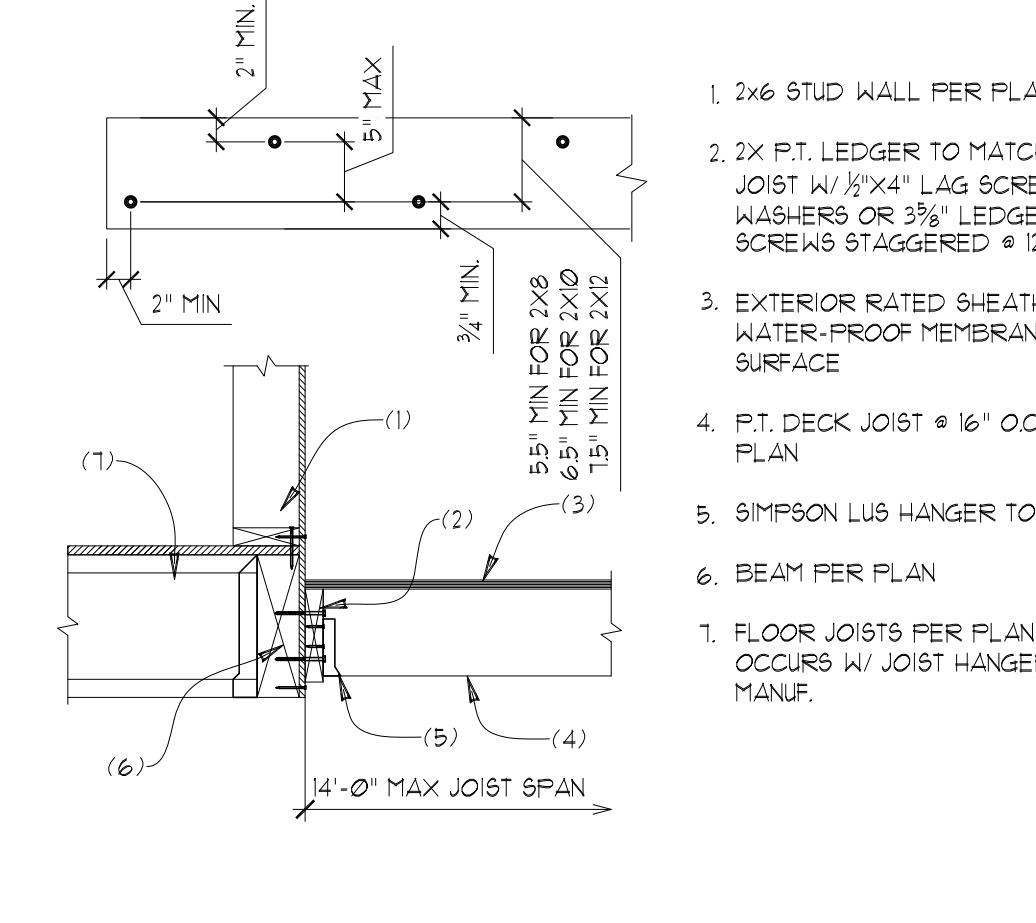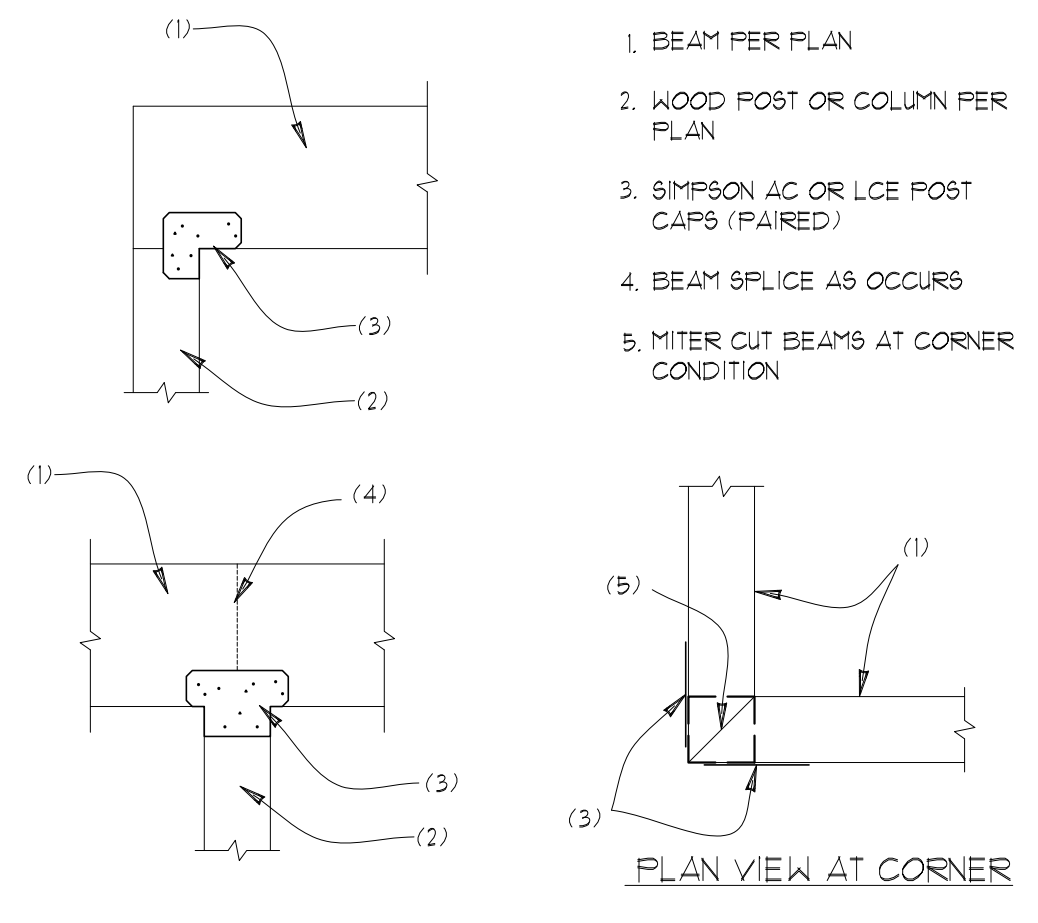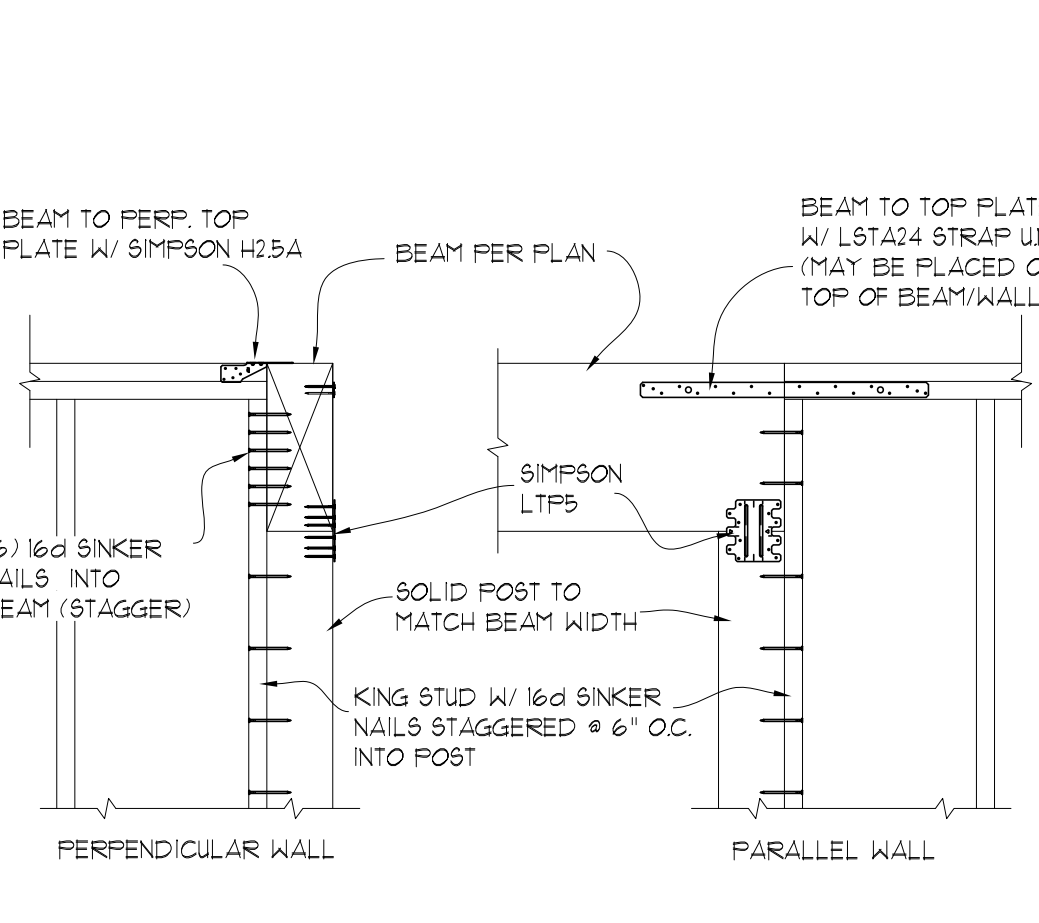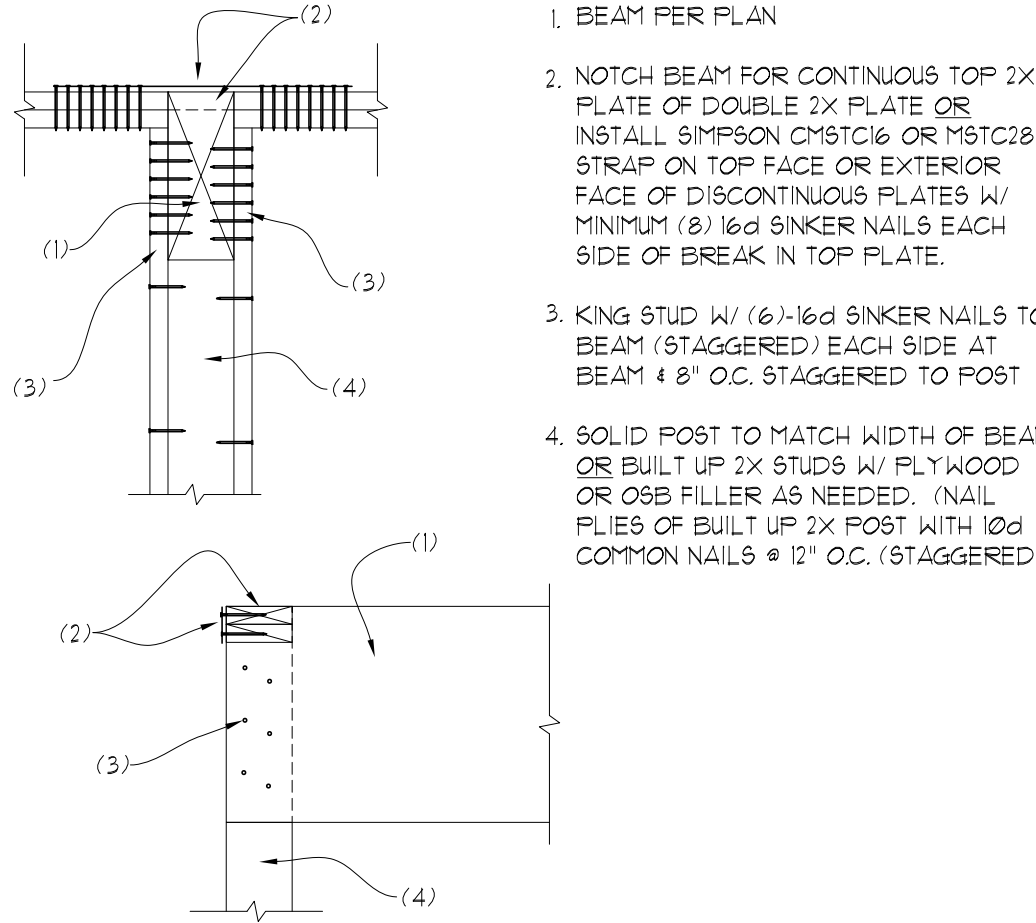






65 BEAM POCKET AT WALL  
SCALE: 3/4"=1"

66 BEAM POCKET AT CORNER  
SCALE: 3/4"=1"

67 WOOD BEAM AT WOOD POST  
SCALE: 3/4"=1"

68 DECK LEDGER AT BEAM  
SCALE: 3/4"=1"

69 WOOD BEAM AT WOOD POST  
SCALE: 3/4"=1"

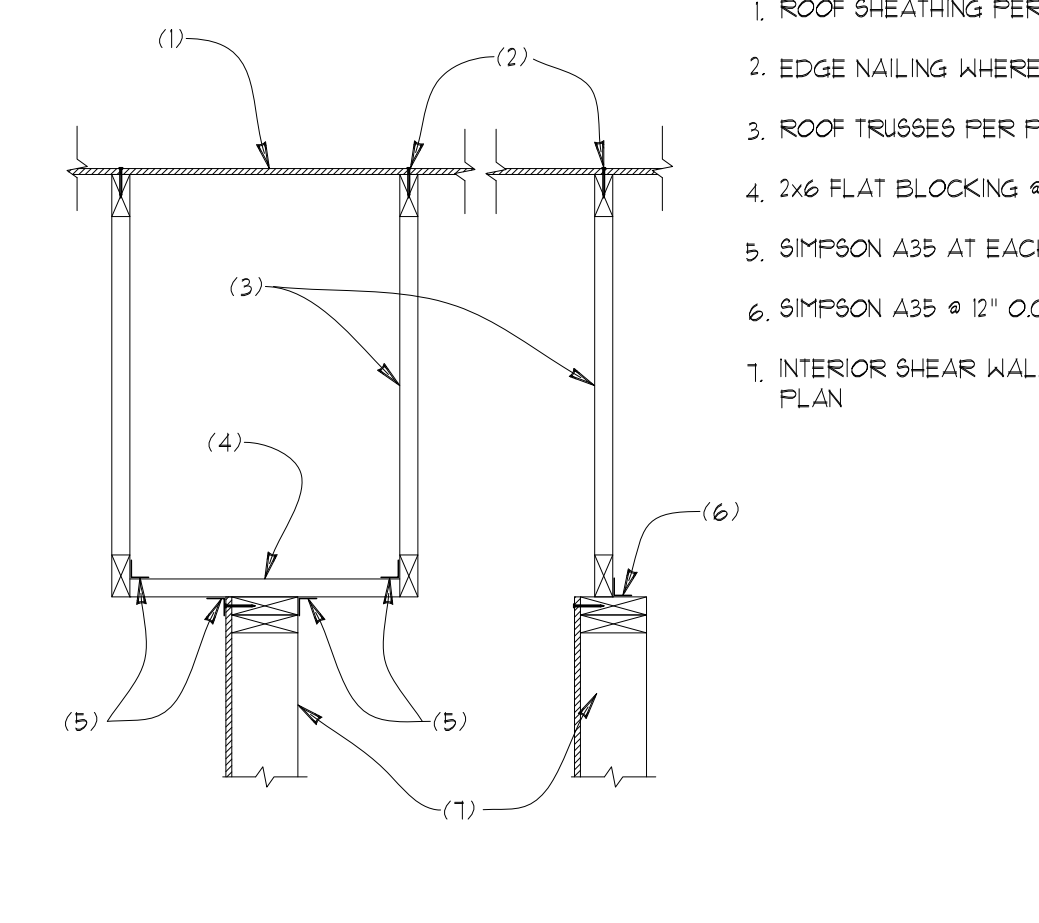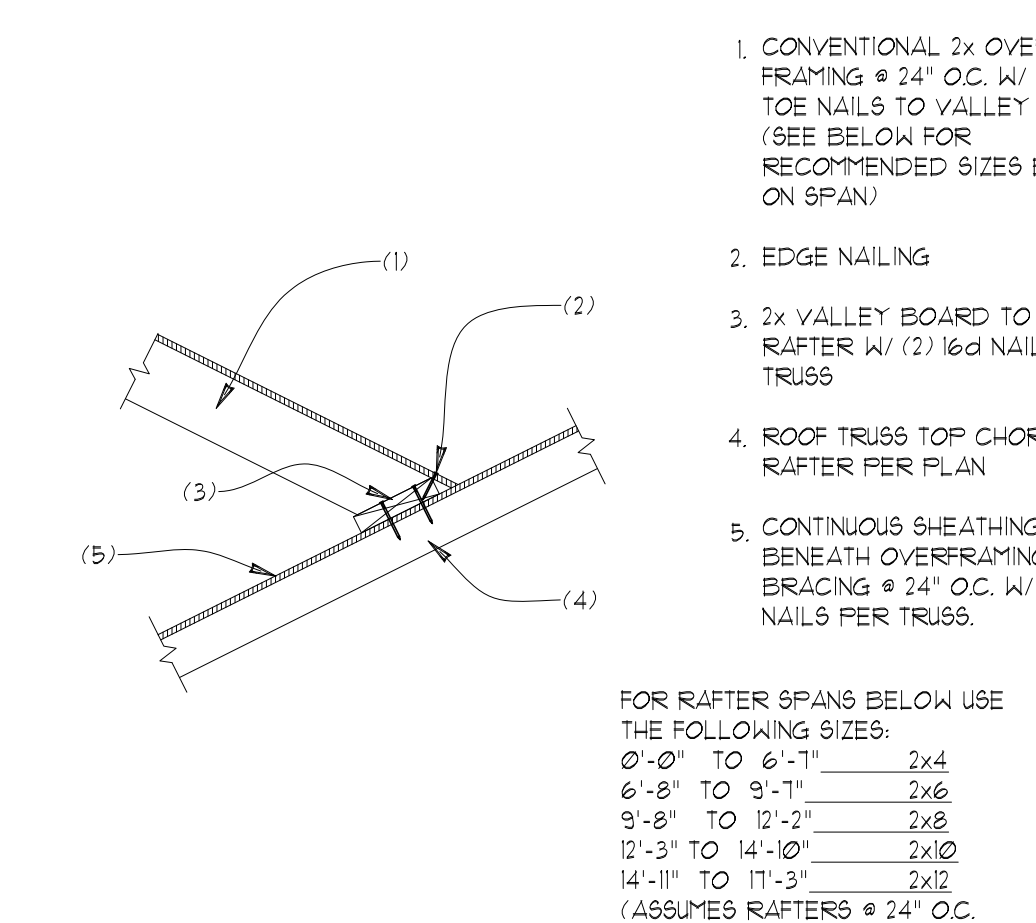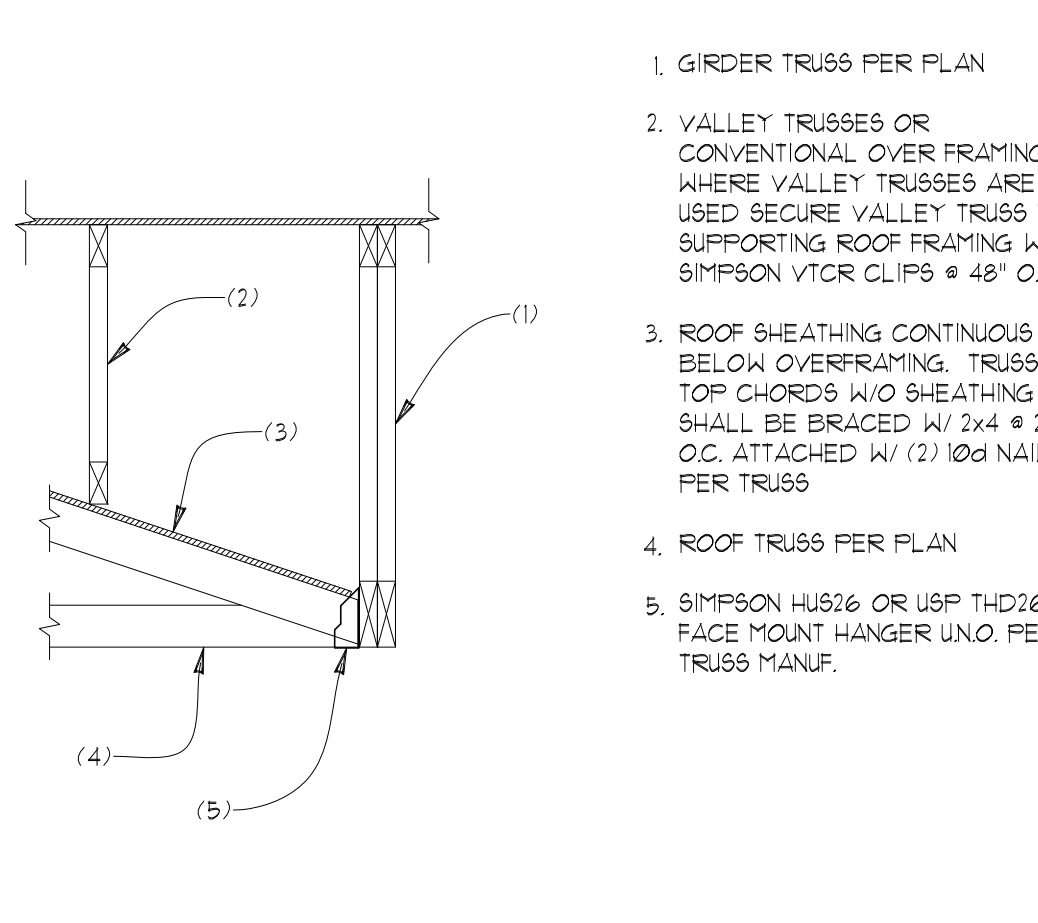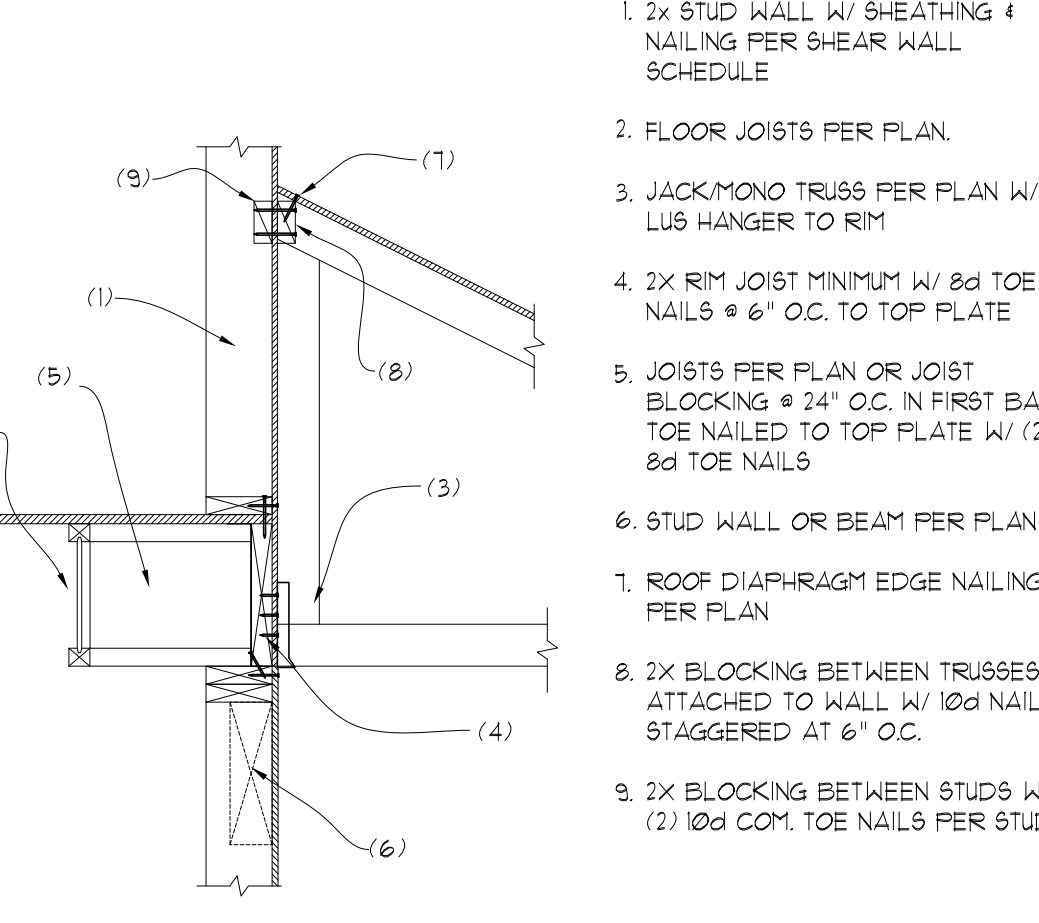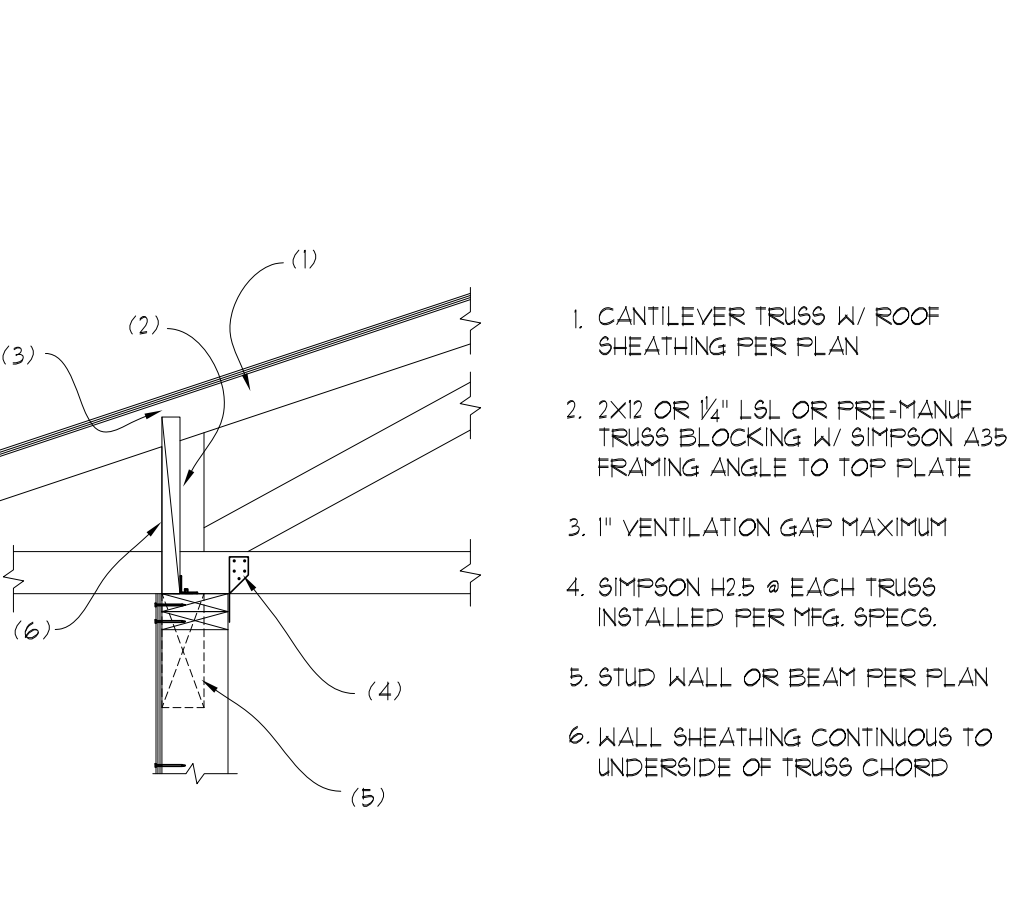





70 CANTILEVER HEEL OPTION AT BEARING  
SCALE: 3/4"=1"

71 MONO/JACK TRUSS TO RIM  
SCALE: 3/4"=1"

72 GIRDER TRUSS AT OVERFRAMING  
SCALE: 3/4"=1"

73 VALLEY FRAMING  
SCALE: 3/4"=1"

74 ROOF SHEAR TRANSFER @ INT. WALL  
SCALE: 3/4"=1"

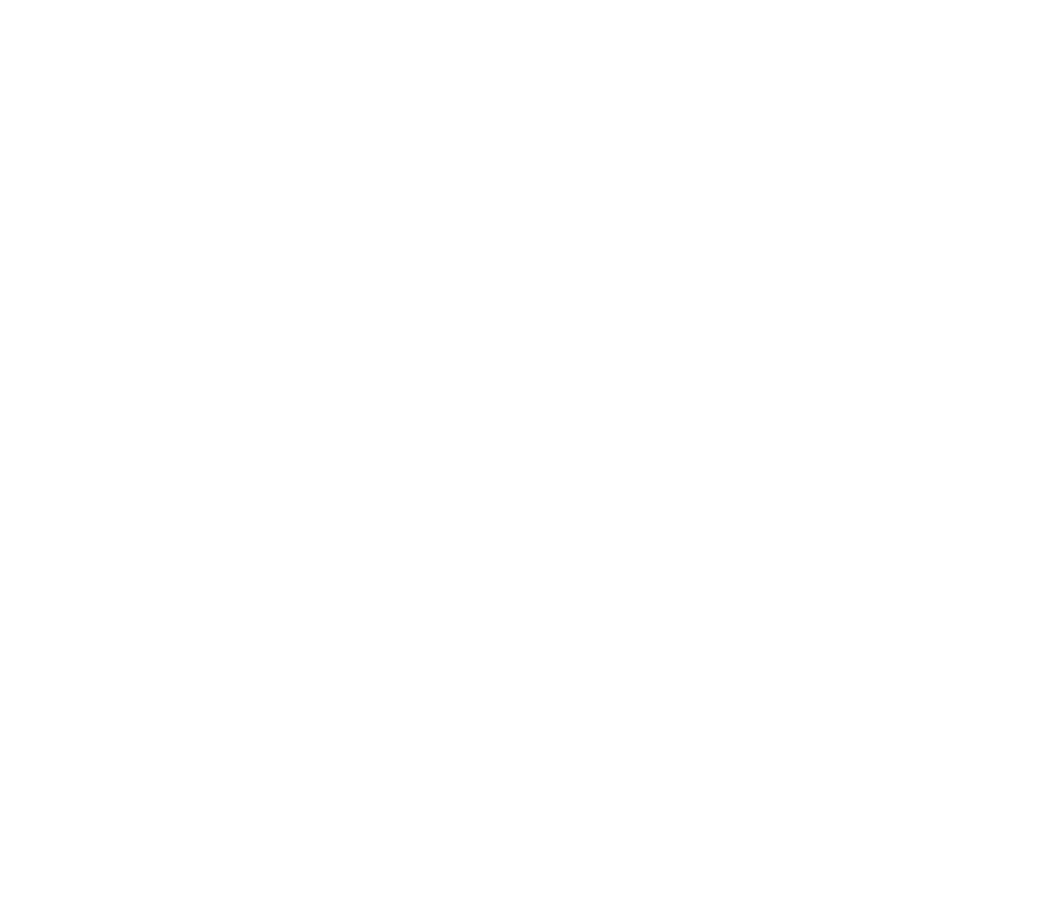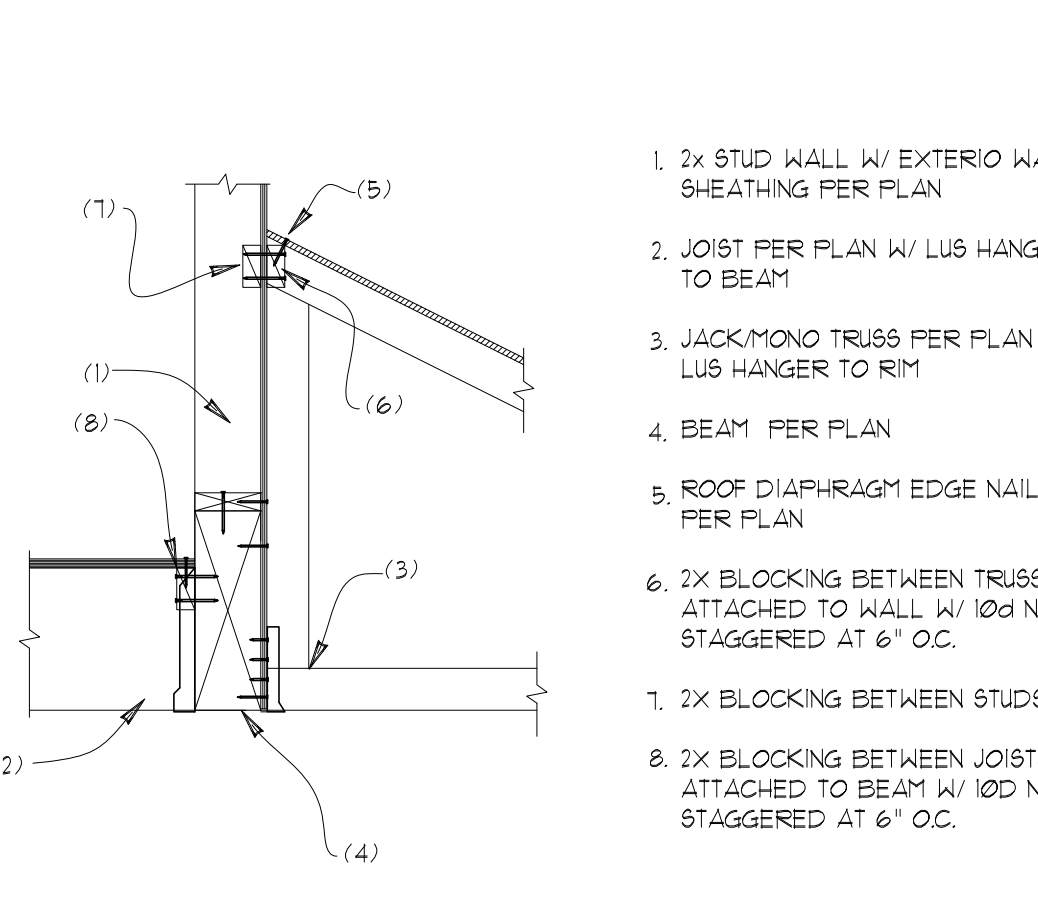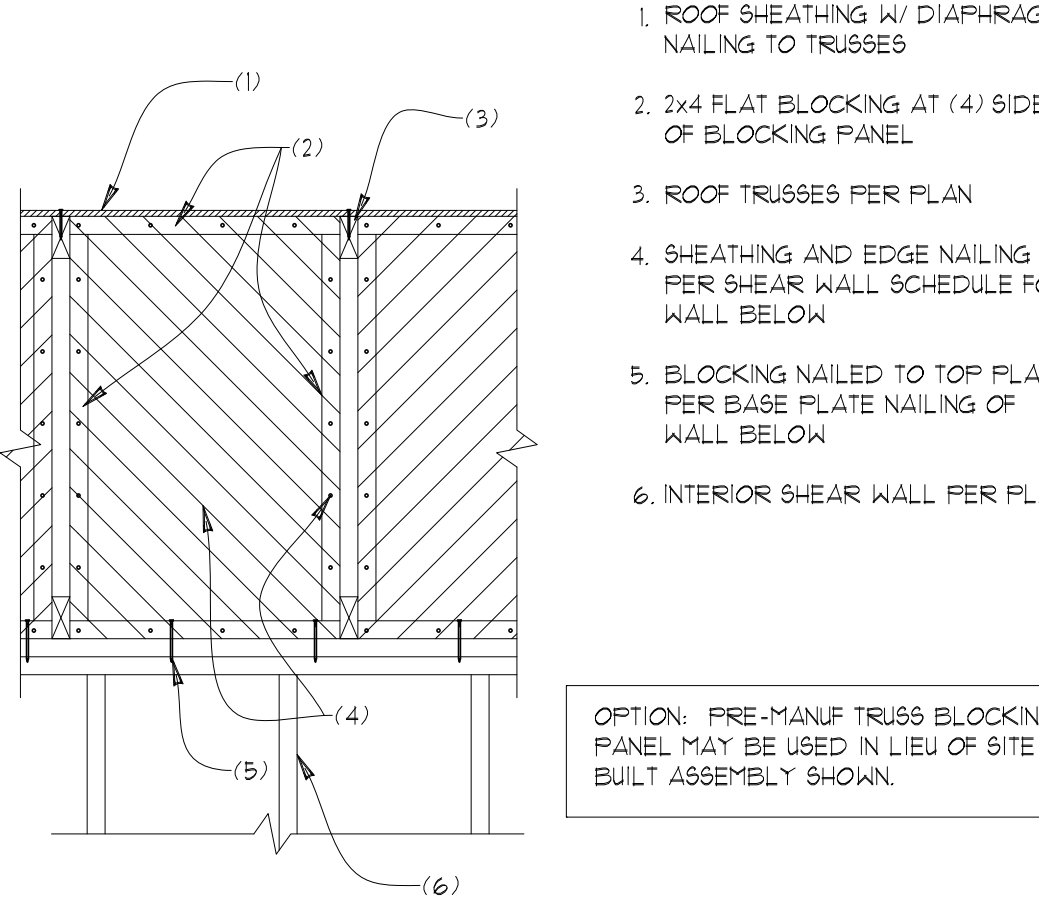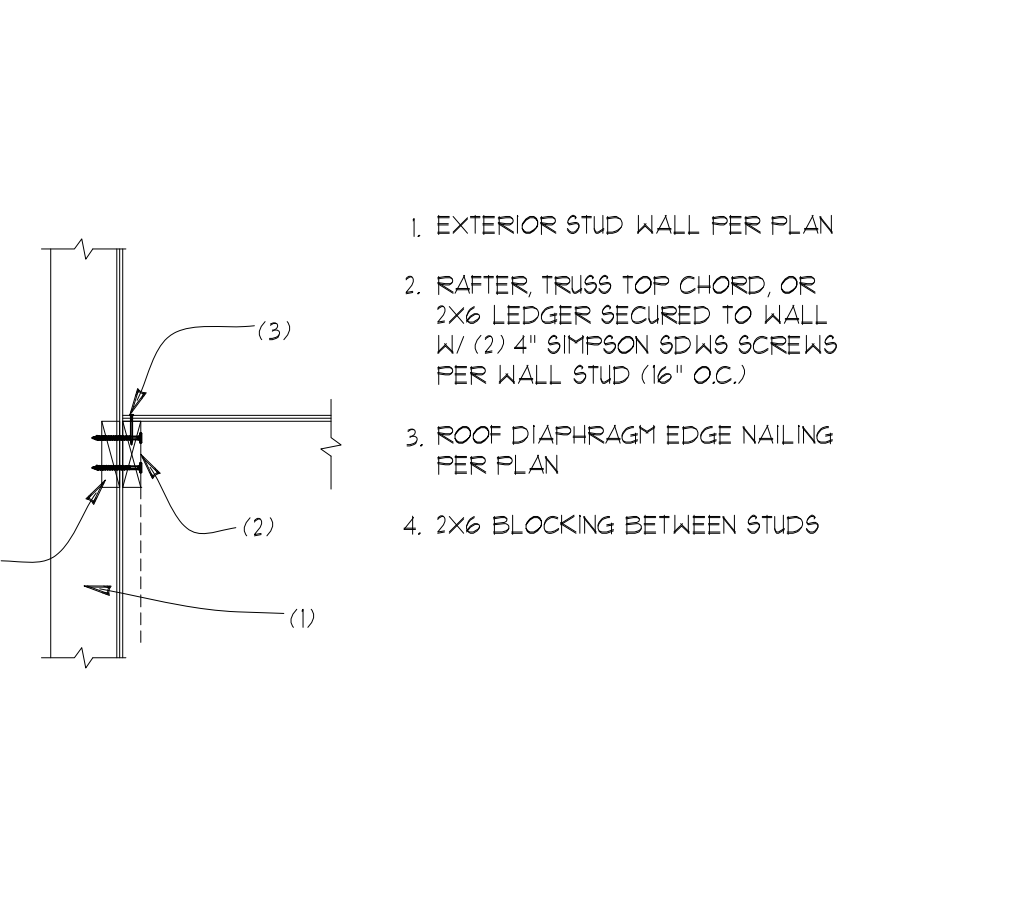

75 ROOF DIAPHRAGM TO WALL  
SCALE: 3/4"=1"

76 SHEAR BLOCKING @ INT. SHEAR WALL  
SCALE: 3/4"=1"

77 MONO TRUSS TO WALL AT BEAM  
SCALE: 3/4"=1"

78 MONO TRUSS TO WALL AT BEAM  
SCALE: 3/4"=1"

79 MONO TRUSS TO WALL AT BEAM  
SCALE: 3/4"=1"

STRUCTURAL PLANS

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**S6**  
DATE: 8-31-2020  
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PROJECT #: 1309