



EXISTING LOT COVERAGE		EXISTING IMPERVIOUS COVERAGE				PROPOSED IMPERVIOUS COVERAGE				YARD
LOT	11,946	LOT	11,946			LOT	11,946			COVERAGE
RESIDENCE	1,410	RESIDENCE	1,410			RESIDENCE	1,410			
GARAGE	480	GARAGE	480			GARAGE	480			PERCENT
OPEN PORCH	210	OPEN PORCH	210			OPEN PORCH	210			
DECK	250	DRIVEWAY	430			DRIVEWAY	430			
TOTAL SQFT	2,350			TOTAL SQFT	2,530	NEW PATIO COVER	326.25	TOTAL SQFT	2,856.25	
TOTAL %	19.67			TOTAL %	21.17			TOTAL %	23.90	

228700-0140	ALEC SUTTON
LEGAL DESCRIPTION EL DORADO ESTATES ADD PLAT Block: Plat Lot: 14	425.633.0584
LE DONADO ESTATES ADD FEAT BIOCK. Flat Lot. 14	PROJECT CONTACT
	TONY MITCHELL
(206.669.6650

PARCEL NUMBER

DRAWN BY

SCALE 1'' = 20'DATE 10/29/2020 **REV. DATE**

XX/XX/XXXX

T20-51 **NORVELL PATIO COVER**

NORVELL, NIKKI 5720 91ST AVE SE MERCER ISLAND, WA 98040

TIMBERLINE PATIO COVERS LLC

16910 59TH AVE NE SUITE 215 ARLINGTON, WA 98223 PH: 425.256.2176

TIMBEPC831BZ, EXP 1/21




PROJECT SCOPE

WE ARE CONTRACTED TO BUILD AN ATTACHED, **275 SQFT PATIO COVER** TO THE BACK OF THE RESIDENCE.

DRAWING INDEX

- A1. DRAWING INDEX AND PROJECT SCOPE A2. FLOOR PLAN, FRAMING PLAN, FOUNDATION PLAN
- A3. PROJECT DETAILS
- A4. ELEVATIONS, GENERAL NOTES A5. ELEVATIONS

VICINITY MAP

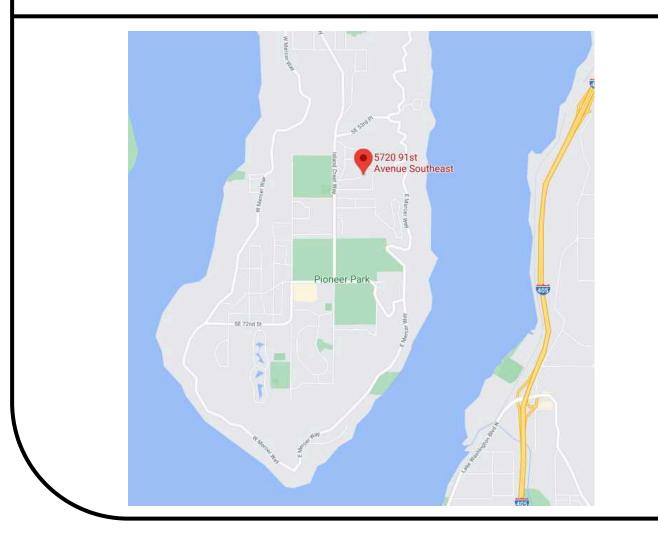



COUNTY IMAP VIEW

NOT TO SCALE



BASE VIEW WITH ELEVATIONS

NOT TO SCALE




FRONT ELEVATION OF RESIDENCE

NOT TO SCALE




PH: 425.256.2176

09/10/2020

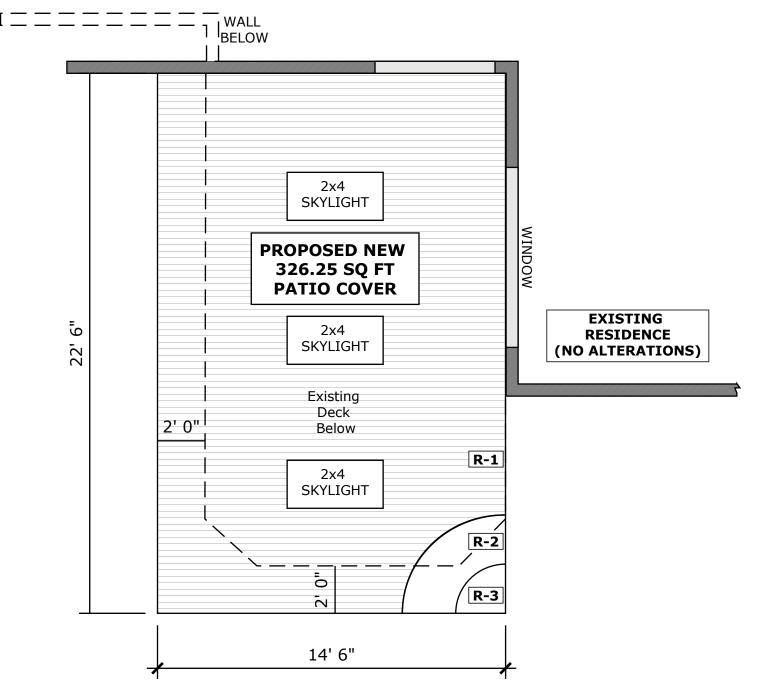

FRAMING PLAN

SCALE 1/4"=1'-0"

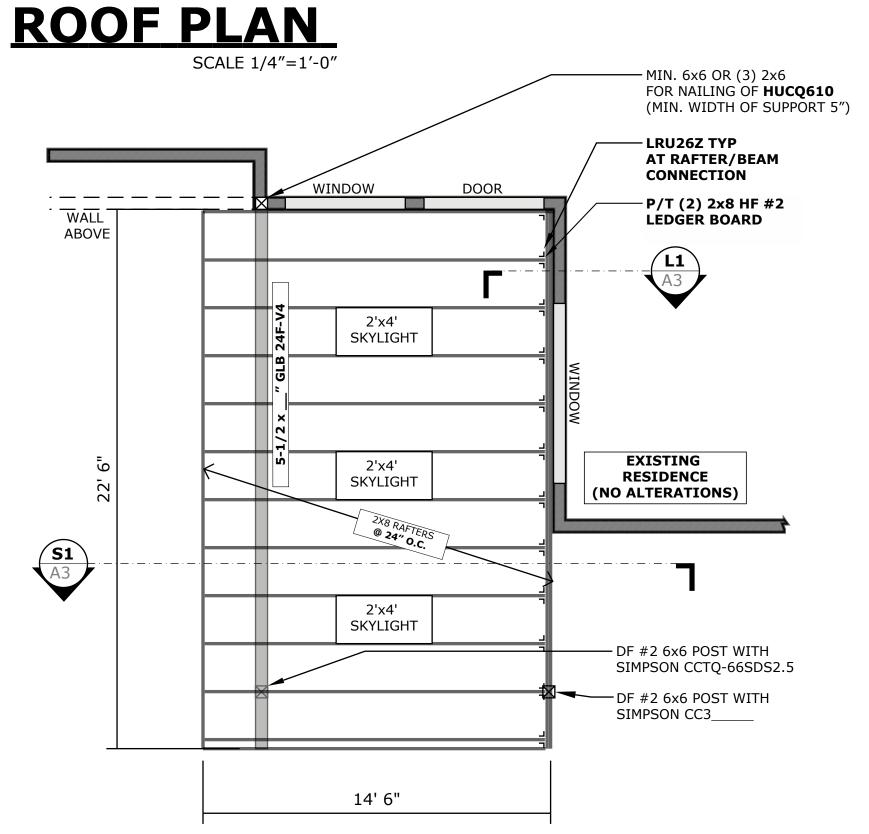

GENERAL FRAMING NOTES

FRAMING NOTES:

-ALL WORK TO CONFORM TO CURRENT BUILDING CODE

-ALL FRAMING MEMBERS TO BE PRESSURE TREATED HEM-FIR #2 OR

BETTER UNLESS NOTED OTHERWISE ON PLANS

-ALL POSTS TO BE 6x6 PRESSURE TREATED HF UNLESS NOTED OTHERWISE

FASTENER NOTE:

-I.R.C. 319.3 FASTENERS FOR PRESSURE TREATED PRESERVATIVE AND FIRE RETARDANT TREATED WOOD SHALL BE HOT DIPPED GALVANIZED STEEL, STAINLESS STEEL, SILICON BRONZE OR COPPER

-"LEDGER-LOK" SCREWS SHALL BE INSTALLED PER MANUFACTURES TECHNICAL BULLETIN AND ICC ESR REPORT #1078

ROOF PLAN KEY NOTES

COMPOSITE ROOFING TO MATCH EXISTING ON HOUSE

R-2 30 LB ROOFING PAPER

TYPICAL ROOF SHEATHING

7/16" OSB, INDEX 32/16, BLOCKED, LAID UP W/ FACE GRAIN PERPENDICULAR TO FRAMING BELOW, STAGGER END JOINTS. NAILS AS FOLLOWS:

DIAPHRAGM BOUNDARY AND OVER EXTERIOR WALLS AND SHEARWALLS 8D @ 6" o.c. ALL SUPPORTED EDGES_ 8D @ 6" o.c. 8d @ 12" o.c.

EXISTING EXISTING DECK RESIDENCE (NO ALTERATIONS) (NO ALTERATIONS) $\bar{\infty}$ 9 -PATIO COVER
FOUNDATION
FOOTINGS (TYP) x2 - PATIO COVER 12' 0" PERIMETER

FOUNDATION PLAN SCALE 1/4"=1'-0"

SUITE 215 98223

COVERS

TIMBERLINE PATIO

PATIO COVER

NORVELL

SCALE

5.633.0584

16910 59TH AVE NE SUITE ARLINGTON, WA 9822 PH: 425.256.2176

21

NIKKI NORVELL 5720 91ST AVE SE MERCER ISLAND, WA 98040

REV. DATE
XX/XX/XXXX **DATE** 09/10/2020

PROJECT CONTACT
MITCHELL - 206.669.6650

DRAWN BY
ARI FERNANDO - 42

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TIMBERLINE PATIO


2X_ HF# @ __" O.C. (TYP) SHEATHING MIN 3 EXISTING HOUSE SIDING SIMPSON H2.5A METAL L FLASHING — HURRICANE TIE **LEDGER** ATTACHENT METAL EDGE FLASHING EXISTING WALL 6x10 HF#2 BEAM PER L1 SHEATHING RESIDENCE ___" OSB ROOF SHEATHING W/ 8D @ 6" O.C. EDGES & 12" O.C. FIELD — CCQ__ - SDS 2.5 EXISTING 2X STUDS @ 16" O.C. VERIFY COLUMN CAP (TYP) PT _X_ HF#2 **ROOF PAPER** POSTS (TYP) COMPOSITE ROOF MATERIAL -2X__ HF#2 LEDGER PLATE ATTACH TO EACH EXISTING 2X STUD W/(1) 3-5/8" LEDGER-LOK **FOOTING** @ 16" O.C. (STAGGER TOP & BOTTOM) PER F1 "LRU___" SIMPSON HANGER GRADE--2X RAFTER PER PLAN

S1 PATIO COVER SECTION

NOT TO SCALE

ROOF LEDGER DETAIL

NOT TO SCALE

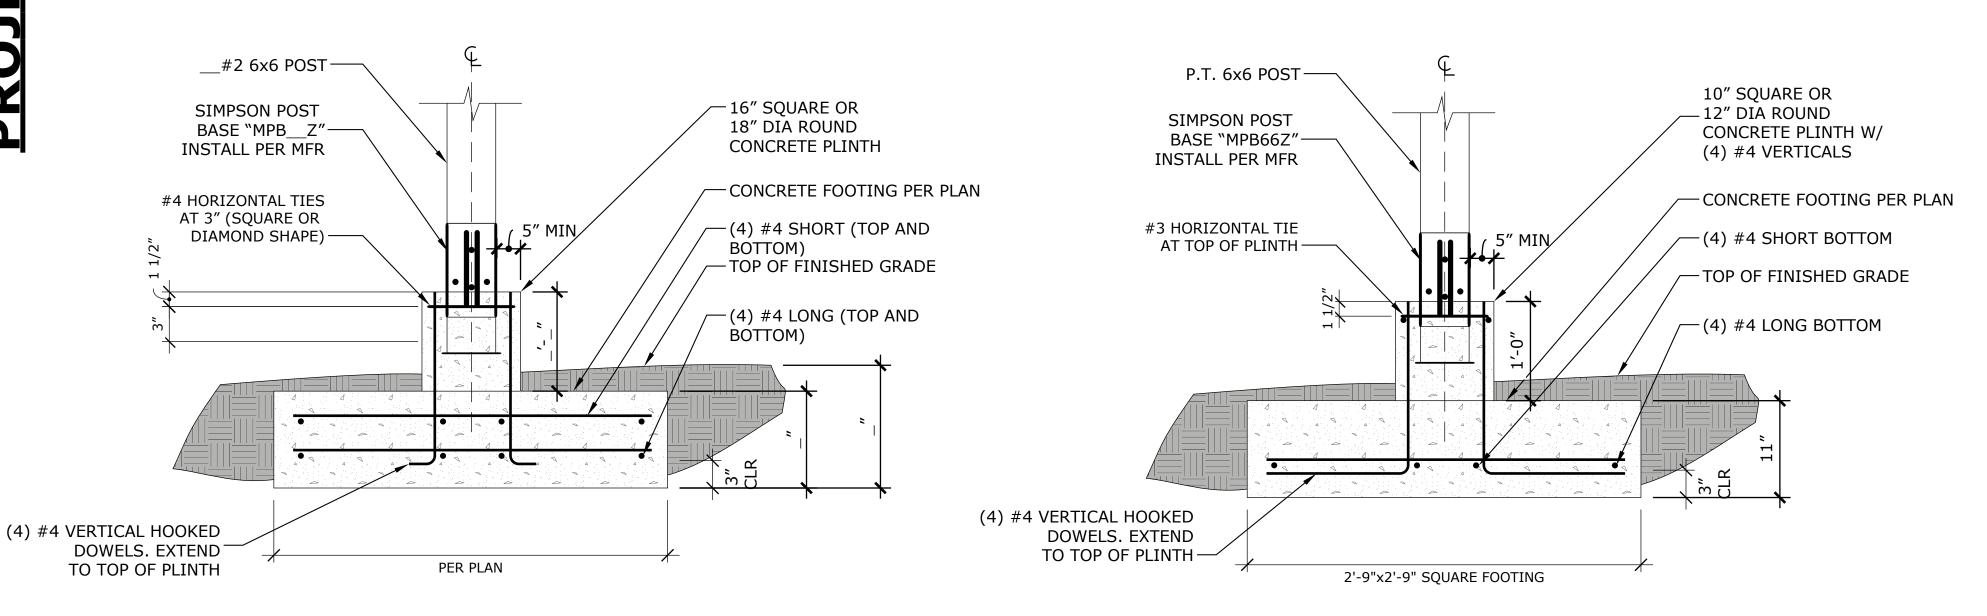

PATIO COVER POST TO FOOTING CONNECTION (REINF)
NOT TO SCALE

PATIO COVER POST TO FOOTING CONNECTION (UNREINF)
NOT TO SCALE

 5.633.0584
 SCALE
 T20-51

 1/4" = 1'
 NORVELL PATIO COVER

 16.669.6650
 DATE
 NIKKI NORVELL

 40
 REV. DATE
 S720 91ST AVE SE

 TION
 XX/XX/XXXX

ABBCER ISLAND, WA 98040

ARI FERNANDO - 425.633.0584
PROJECT CONTACT
TONY MITCHELL - 206.669.6650
PARCEL NUMBER
228700-0140
LEGAL DESCRIPTION
EL DORADO ESTATES ADD

A

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ALTERNATE VIEW



ALTERNATE VIEW

GENERAL STRUCTURAL NOTES

A. GENERAL REQUIREMENTS

THE CONTRACT STRUCTURAL DRAWINGS REPRESENT THE FINISHED STRUCTURE. THEY DO NOT INDICATE THE METHOD OF CONSTRUCTION. THE CONTRACTOR SHALL BE SOLELY RESPONSIBLE FOR CONSTRUCTION MEANS, METHODS, TECHNIQUES, SEQUENCES, AND PROCEDURES. CONSTRUCTION MATERIALS SHALL BE SPREAD OUT IF PLACED ON FRAMED CONSTRUCTION SUCH THAT THE DESIGN LIVE LOAD PER SQUARE FOOT AS STATED HEREIN IS NOT

OPTIONS SHOWN ARE FOR CONTRACTOR'S CONVENIENC. IF AN OPTION IS USED, THE CONTRACTOR SHALL BE RESPONSIBLE FOR ALL NECESSARY CHANGES AND SHALL COORDINATE ALL DETAILS.

WHERE DISCREPANCIES OCCUR BETWEEN PLANS, TYPICALDESIGNS, AND GENERAL STRUCTURAL NOTES, NOTES AND DETAILS ON DRAWINGS SHALL TAKE PRECEDENCE OVER GENERAL STRUCTURAL NOTES AND TYPICAL DETAILS. TYPICAL DETAILS AND NOTES NOT NECESSARILY INDICATED AT A SPECIFIC LOCATION ON PLANS OR DETAILS SHALL APPLY NONE-THE-LESS. WHERE NO DETAILS ARE SHOWN, CONSTRUCTION SHALL CONFORM TO SIMILAR WORK ON THE PROJECT. DETAILS MAY SHOW ONLY ONE SIDE OF CONNECTIONS OR MAY OMIT INFORMATION FOR CLARITY OF OTHER ITEMS SHOWN.

B. BASIS OF DESIGN

BUILDING CODE: 2015 EDITION OF THE INTERNATIONAL BUILDING CODE.

20PSF ROOF LIVE LOAD: FLOOR LIVE LOAD: 40PSF BALCONY & DECK LIVE LOAD: 60PSF ROOF SNOW LOAD:

ALLOWABLE SOIL BEARING PRESSURE = 1,500 PSF

BOTTOMS OF ALL FOOTINGS SHALL BE LOCATED A MINIMUM OF 12" BELOW GRADE, UNO.

<u>MATERIALS</u>

D. CONCRETE

C. FOUNDATIONS

CONCRETE FOR THIS PROJECT CONSISTS OF FOUNDATIONS FOR THE STRUCTURE. ALL POURED IN PLACE SHALL HAVE ULTIMATE COMPRESSIVE STRENGTH OF 2500 PSI AT 28 DAYS (DESIGN BASED ON 2500PSI, NO SPECIAL INSPECTION IS REQUIRED). CONCRETE FORM TOLERANCES SHALL BE WITHIN THE SET STANDARDS OF THE AMERICAN CONCRETE INSTITUTE.

ALL REINFORCING STEEL, ANCHOR BOLTS, DOWELS, AND OTHER INSERTS SHALL BE SECURED IN POSITION AND INSPECTED BY THE LOCAL BUILDING DEPARTMENT PRIOR TO THE POURING OF ANY CONCRETE.

NO PIPES OR DUCTS SHALL BE PLACED IN STRUCTURAL CONCRETE UNLESS SPECIFICALLY DETAILED. REFER TO ARCHITECTURAL, MECHANICAL, PLUMBING, AND ELECTRICAL DRAWINGS FOR LOCATION. ALL CONDUITS IN CONCRETE WALLS TO BE WIRED TO THE WALL REINFORCING.

when CONCRETE IS PLACED AGAINST PREVIOUSLY HARDENED CONCRETE, THE INTERFACE FOR SHEAR TRANSFER SHALL BE CLEAN AND FREE OF LAITANCE.

E. REINFORCING STEEL

ALL REINFORCING BARS, EXCEPT STIRRUPS, SHALL CONFORM TO ASTM A615 GRADE60 (UNO) NO.2 AND NO. 3 TIES AND STIRRUPS SHALL CONFORM TO ASTM A615 GRADE 40. ALL DETAILING FABRICATION AND ERECTION OF REINFORCING STEEL SHALL CONFORM TO THE ACI MANUAL OF STANDARD PRACTICE FOR DETAILING REINFORCED CONCRETE STRUCTURES ACI315.

REINFORCING SHALL HAVE MINIMUM CONCRETE COVER AS FOLLOWS: UNFORMED SURFACES EXPOSED TO EARTH

ALL SLAB REINFORCEMENT SHOULD BE SUPPORTED TO ENSURE PLACEMENT NEAR THE VERTICAL MIDPOINT OF THE CONCRETE, UNLESS NOTED OTHERWISE ON THE DETAILS. "HOOKING" IS NOT CONSIDERED AN ACCEPTABLE METHOD OF POSITIONING THE STEEL.

F. STRUCTURAL LUMBER

SOLID SAWN LUMBER SHALL COMPLY WITH THE LATEST EDITION OF THE DRADING RULES OF THE WESTERN WOOD PRODUCTS ASSOCIATION (WWPA) OR THE WEST COAST LUMBER INSPECTION BUREAU)WCLIB). ALL SOLID SAWN LUMBER SHALL BE STAMPED WITH THE GRADE MARK OF AN APPROVED GRADING AGENCY. SOLID SAWN LUMBER SHALL HAVE THE FOLLOWING MINUMIM GRADES.

HEM FIR STUD OR BETTER 2X4 & 2X6 STUDS <=10' LONG ALL OTHER 2X HEM FIR NO. 2 OR BETTER 4X BEAMS AND POSTS HEM FIR NO. 2 OR BETTER **6X BEAMS AND POSTS** HEM FIR NO. 1 OR BETTER

ALL STRUCTURAL FRAMING AND CONNECTIONS SHALL BE PER CHAPTER 23 OF THE BUILDING CODE. SPECIFIED CONNECTION HARDWARE BY THE SIMPSON STRONG-TIE DESIGNATION. ACTUAL CONNECTION HARDWARE SHALL BE SIMPSON STRONG-TIE, USP STRUCTURAL CONNECTORS OR AN ICC APPROVED EQUAL, INSTALLED PER MANUFACTURER'S RECOMMENDATIONS.

GLUE-LAMINATED BEAMS (GLB) SHALL BE DOUGLAS FIR, COMBINATION 24F-V4 SIMPLE SPAN BEA,S AND 24F-V8 AT CANTILEVERED OR CONTINUOUS BEAMS WITH THE FOLLOWING MINIMUM PROPERTIES: Fb=2400 PSI, Fc=265 PSUSING WATERPROOF GLUE. FABRICATION AND HANDLING SHALL BE PER THE LATEST AITC AND WCLA STANDARDS. ALL BEAMS SHALL BEAR THE GRADE STAMP AND AITC STAMP AND CERTIFICATE.

PLYWOOD FOR FLOORS SHALL BE AMERICAN PLYWOOD ASSOCIATE (APA) PERFORMANCE RATED SHEATHING CONFORMIN TO STANDARD PS 1-09.

LAY PLYWOOD WITH FACE GRAIN PERPENDICULAR TO SUPPORTS. ALL NAILING SHALL BE WITH COMMON NAILS AND SOLID 2X BLOCKING SHALL BE PLACED AT ALL RIDGES AND VALLEYS. ALL ROOF AND FLOOR SHEATHING SHALL BE NAILED WITH BOUNDARY NAILING ALONG THE ENTIRE LENGTH OF SUPPORTING MEMBERS USED AS "DRAG" MEMBERS. A DRAG MEMBER IS DEFINED AS A TRUSS OR BEAM DESIGNED TO TRANSMIT A LATERAL FORCE AND/OR A DIAPHRAGM CHORD FORCE AS INDICATED ON THE FRAMING PLANS. PROVIDE BLOCKING AT PANEL EDGES WHERE INDICATED ON PLANS. SILL PLATES RESTING ON CONCRETE OR MASONRY SHALL BE OF PRESSURE TREATED LUMBER. MAXIMUM ANCHOR BOLT SPACING SHALL BE 72 INCHES ON CENTER UNLESS NOTED OTHERWISE ON PLANS AND DETAILS. ALL ANCHOR BOLTS (OTHER THAN BOLTS FROM HOLDONWS) SHALL BE EMBEDDED 7 INCHES INTO CONCRETE. ANCHOR BOLTS FOR HOLDOWNS SHALL NOT BE CONSIDERED AS A PART OF REQUIRED ANCHOR BOLTS ON SHEAR WALLS. ALL EXTERIOR WALLS SHALL BE SECURED WITH MINIMUM ANCHOR BOLTS. INTERIOR WALLS MAY BE DRIVEN SHOT PINS ACCORDING TO ALTERNATE OUTLINED HEREIN UNLESS NOTED OTHERWISE ON

ALL BOLTS IN WOOD SHALL CONFORM TO ASTM A307 AND SHALL BE INSTALLED IN HOLES BORED WITH A BIT 1/16 INCH LARGER THAN THE DIAMETER OF THE BOLT. BOLTS AND NUTS SEATING ON WOOD SHALL HAVE CUT STEEL WASHERS UNDER HEADS AND NUTS. DAMAGE THREADS AFTER INSTALLATION TO

ALL NAILS SHALL BE COMMON WIRE NAILS, UNO, WITH THE FOLLOWING CHARACTERS:

6D: 0.113" DIAMETER X 2" LONG 8D: 0.131" DIAMETER X 2" LONG 10D: 0.148" DIAMETER X 3" LONG 12D: 0.148" DIAMETER X 3 1/4" LONG 16D: 0.162" DIAMETER X 3 1/2" LONG

INTERIOR NON-BEARING WALLS <=14' HIGH SHALL BE 2X4 STUDS AT 16" O.C.

DO NOT NOTCH OR DTILLJOISTS, BEAMS, OR LOAD BEARING STUDS WITHOUT PRIOR APPROVAL OF THE STRUCTURAL ENGINEER. DOUBLE UP FLOOR JOISTS UNDER PARALLEL PARTITIONS. PROVIDE TRANSVERSE BLOCKING BETWEEN TRUSSES UNDER ALL PARALLEL PARTITIONS. PROVIDE 2" NOMINAL SOLID NAILERS UNDER ALL WALLS DESIGNATED ON THE FRAMING PLANS AS SHEAR WALLS. PROVIDE2" NOMINAL SOLID BLOCKING AT SUPPORTS OF ALL JOISTS AND TRUSSES.

G. QUALITY ASSURANCE REQUIREMENTS

SPECIAL INSPECTION PER IBC SECTION 1705 SHALL BE PROVIDED FOR THE FOLLOWING ITEMS:

REINFORCING BAR OR BOLTS ANCHORED BY EPOXIES OR GROUTS



SUITE 2 98223

PH: 425.256.2176 16910 59TH AVE NE ARLINGTON, WA

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PATIO COVER

NORVELL

T20-51

SCALE

.633.0584

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NIKKI NORVELL 5720 91ST AVE SE MERCER ISLAND, WA 9

DATE 09/10/2020

TACT 06.669.6650 **CON** PROJECT (



EXP 1/21

TIMBEPC831BZ,

TIMBERLINE PATIO COVERS LLC

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NORVELL PATIO COVER T20-51

NIKKI NORVELL 5720 91ST AVE SE MERCER ISLAND, WA 98040 SCALE 1/4" = 1'

REV. DATE
XX/XX/XXX **DATE** 09/10/2020

PARCEL NUMBER
228700-0140
LEGAL DESCRIPTION
EL DORADO ESTATES ADD
PLAT BLOCK:
PLAT BLOCK:
PLAT LOT: 14

DRAWN BYARI FERNANDO - 425.633.0584


PROJECT CONTACT
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12' 8" 8' 0" 20' 6" 22' 6"



WEST ELEVATION SCALE 1/4"=1'-0"

EAST ELEVATION SCALE 1/4"=1'-0"

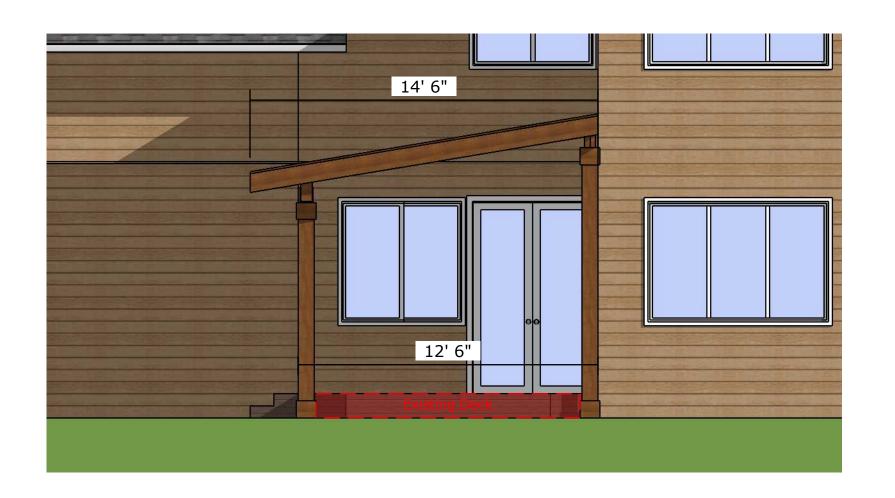

SOUTH ELEVATION