

1 SITE PLAN
SCALE: 1/8" = 1'-0"

principal architect _____
project manager _____
drawn by _____
checked by _____
job no. _____
date 02/13/2023


revisions:

1 5/12/23 CORRECTIONS 1
no. date by

PERMIT SET
02/13/2023

055 & 056_DOORS

MARK	Level (HIDE)	Family	Type	LOCATION	OPERATION	DIMENSIONS		U Value	Comments
						WIDTH	HEIGHT		
GARAGE LEVEL									
101.1	GARAGE LEVEL	DR-Sliding-Glass-XO	6'-0" w x 6'-8" h	LIVING		6'-0"	6'-8"	0.28	EXTERIOR, SAFETY GLAZING
103.1	GARAGE LEVEL	DR-Flush-Single	3'-0" w x 6'-8" h	GUEST BEDROOM		3'-0"	6'-8"		
103.2	GARAGE LEVEL	DR-Flush-Single	3'-0" w x 6'-8" h	CLOSET		3'-0"	6'-8"		
103.3	GARAGE LEVEL	DR-Flush-Double-Glass	5'-0" w x 6'-8" h	GUEST BEDROOM		5'-0"	6'-8"	0.28	EXTERIOR, SAFETY GLAZING
104.1	GARAGE LEVEL	DR-Flush-Single	3'-0" w x 6'-8" h	GUEST BEDROOM		3'-0"	6'-8"		
UPPER LEVEL									
201.1	UPPER LEVEL	DR-Flush-Single	2'-6" w x 6'-8" h	HALLWAY		2'-6"	6'-8"		
202.1	UPPER LEVEL	DR-Flush-Single	2'-6" w x 6'-8" h	BEDROOM 2		2'-6"	6'-8"		
202.2	UPPER LEVEL	DR-Bifold-Double-4_Panel	4'-0" w x 6'-8" h	BEDROOM 2		4'-0"	6'-8"		
203.1	UPPER LEVEL	DR-Flush-Single	2'-6" w x 6'-8" h	BATHROOM		2'-6"	6'-8"		
203.2	UPPER LEVEL	DR-Flush-Single	2'-6" w x 6'-8" h	BATHROOM		2'-6"	6'-8"		
204.1	UPPER LEVEL	DR-Flush-Single	2'-6" w x 6'-8" h	BEDROOM 3		2'-6"	6'-8"		
204.2	UPPER LEVEL	DR-Bifold-Double-4_Panel	4'-0" w x 6'-8" h	BEDROOM 3		4'-0"	6'-8"		
205.1	UPPER LEVEL	DR-Flush-Single	2'-8" w x 6'-8" h	MASTER BEDROOM		2'-8"	6'-8"		
205.2	UPPER LEVEL	DR-Flush-Single	1'-8" w x 6'-8" h	MASTER BEDROOM		1'-8"	6'-8"		
206.1	UPPER LEVEL	DR-Flush-Single	2'-6" w x 6'-8" h	MASTER BATHROOM		2'-6"	6'-8"		
206.2	UPPER LEVEL	DR-Flush-Single	2'-6" w x 6'-8" h	MASTER BATHROOM		2'-6"	6'-8"		
207.1	UPPER LEVEL	DR-Flush-Single	2'-6" w x 6'-8" h	MASTER CLOSET		2'-6"	6'-8"		
208.1	UPPER LEVEL	DR-Flush-Single	2'-8" w x 6'-8" h	LAUNDRY		2'-8"	6'-8"		
209.1	UPPER LEVEL	DR-Flush-Single	2'-6" w x 6'-8" h	BEDROOM 1		2'-6"	6'-8"		
209.2	UPPER LEVEL	DR-Flush-Single	2'-2" w x 6'-8" h	BEDROOM 1		2'-2"	6'-8"		
Grand total: 20									

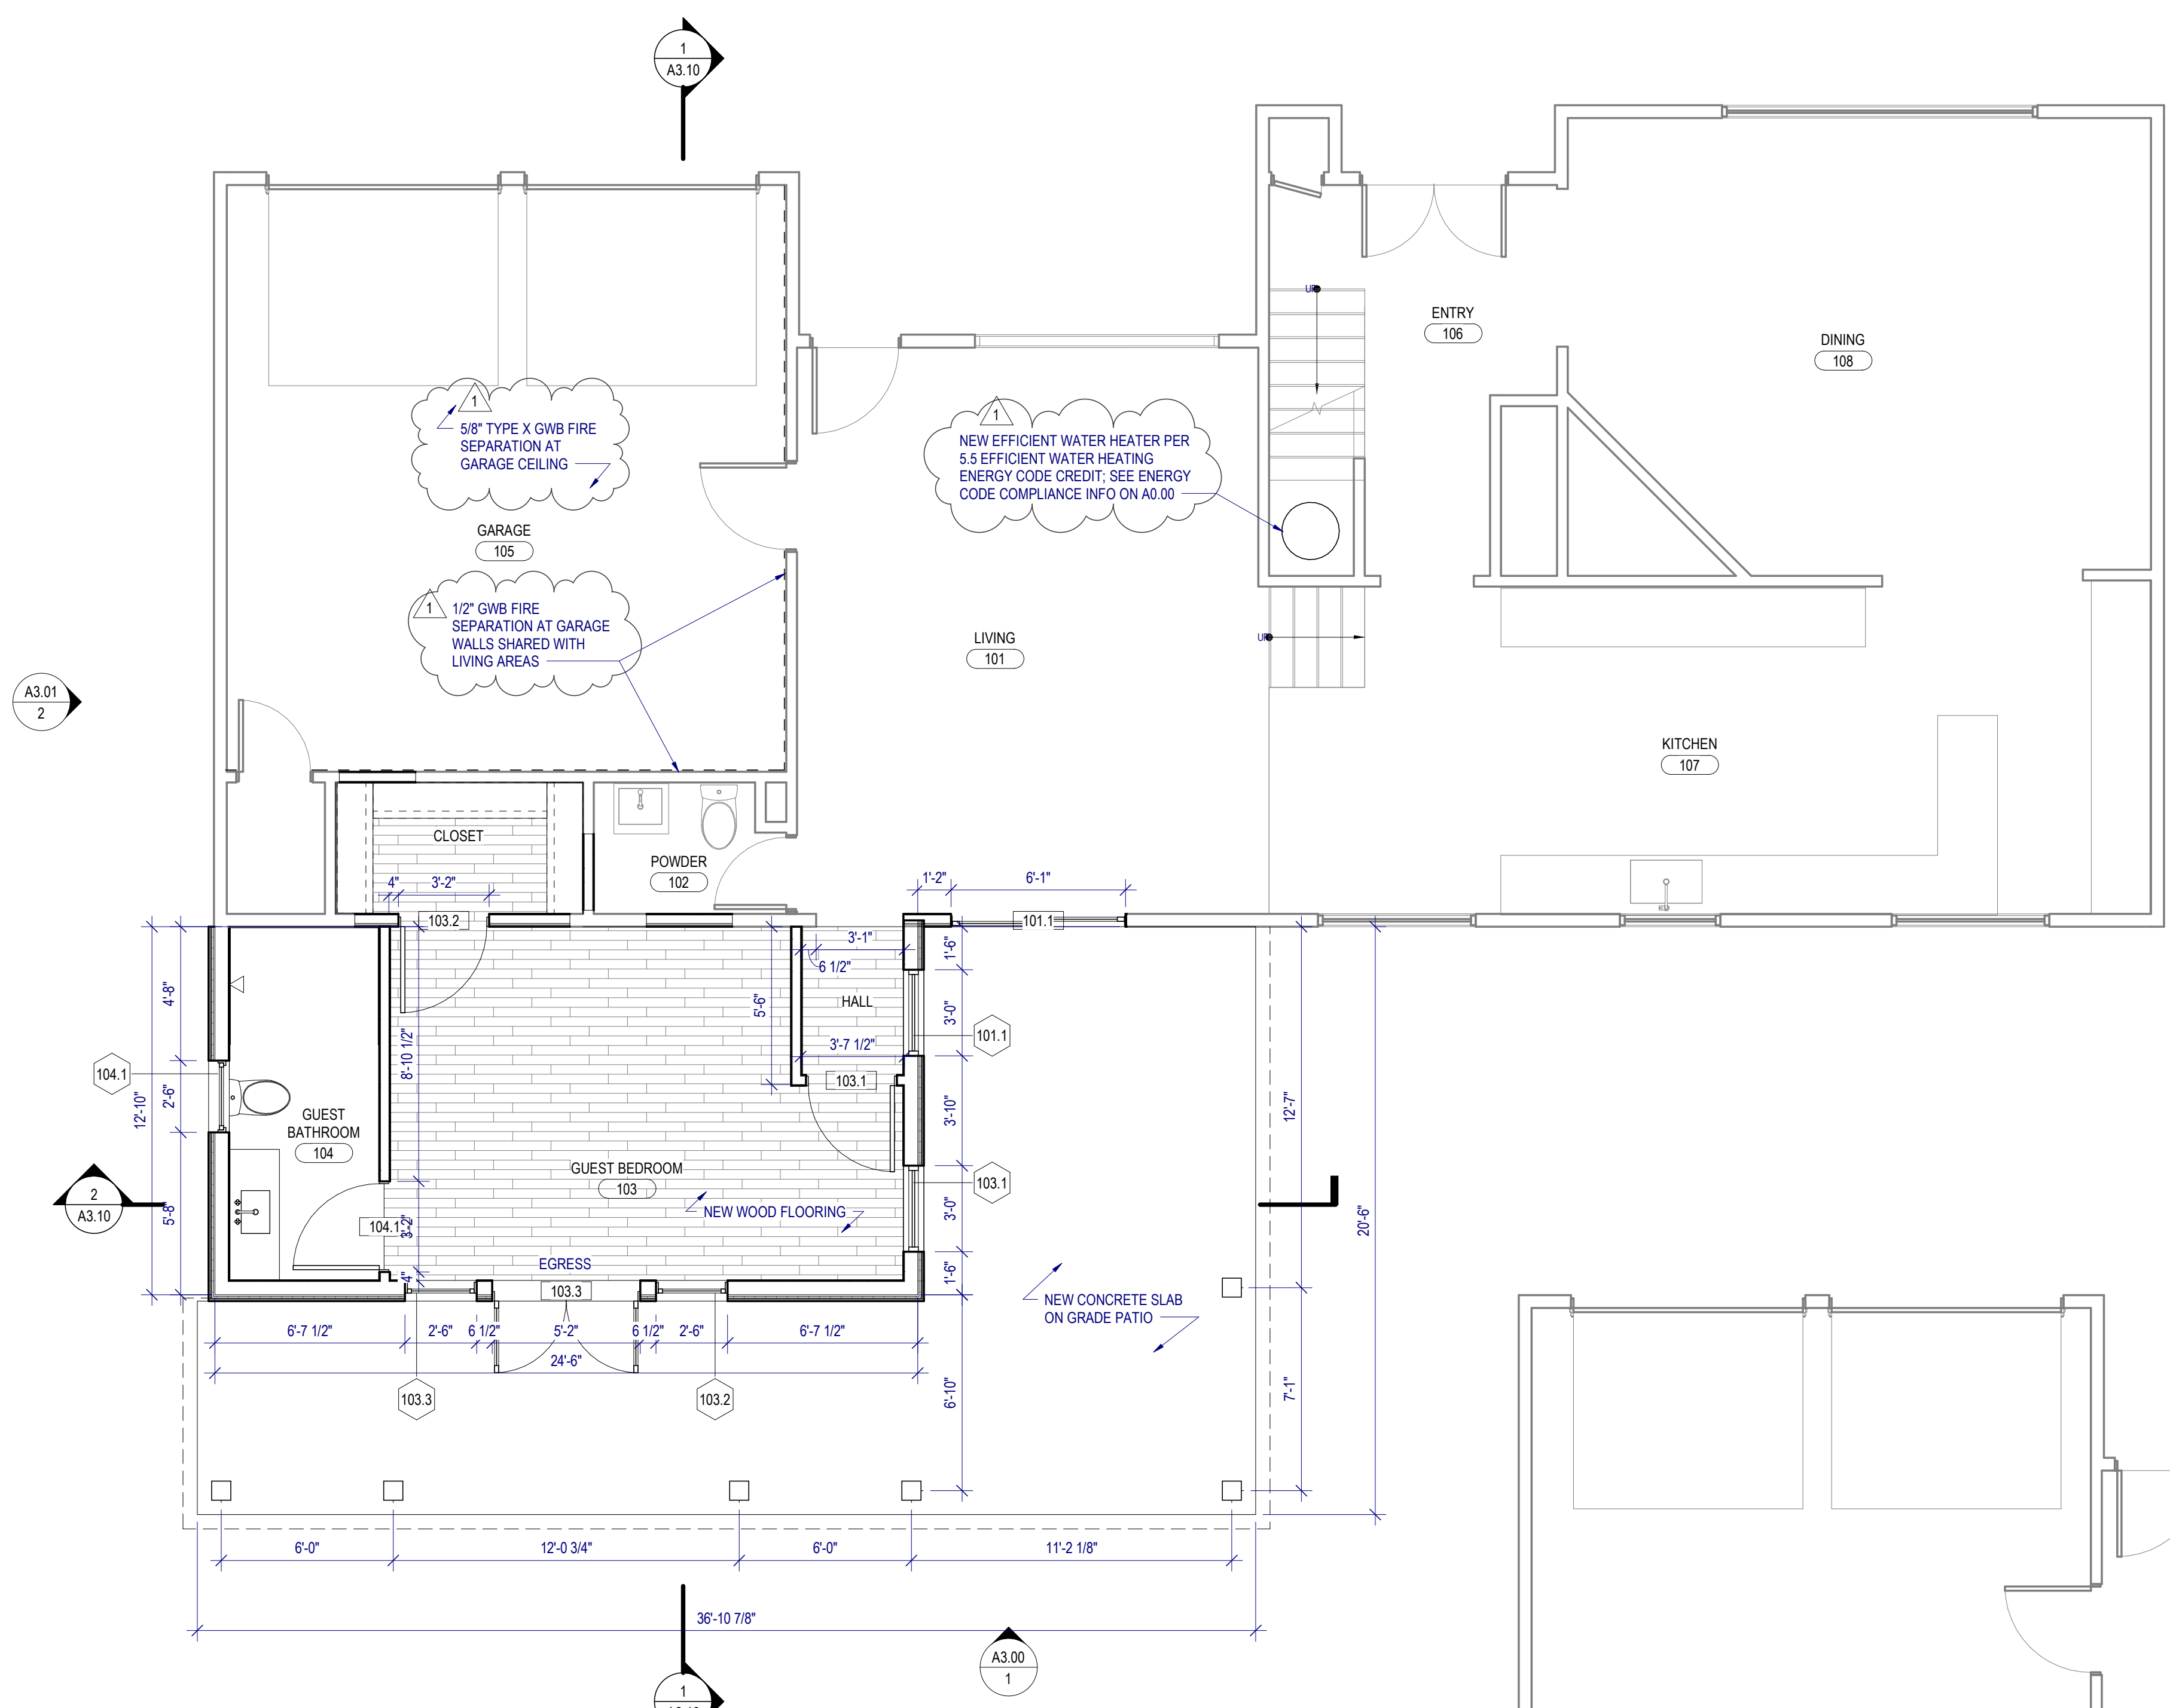


FLOOR PLAN LEGEND

EXISTING CONSTRUCTION TO REMAIN

NEW CONSTRUCTION

01 MAIN LEVEL PLAN
SCALE: 1/4" = 1'-0"

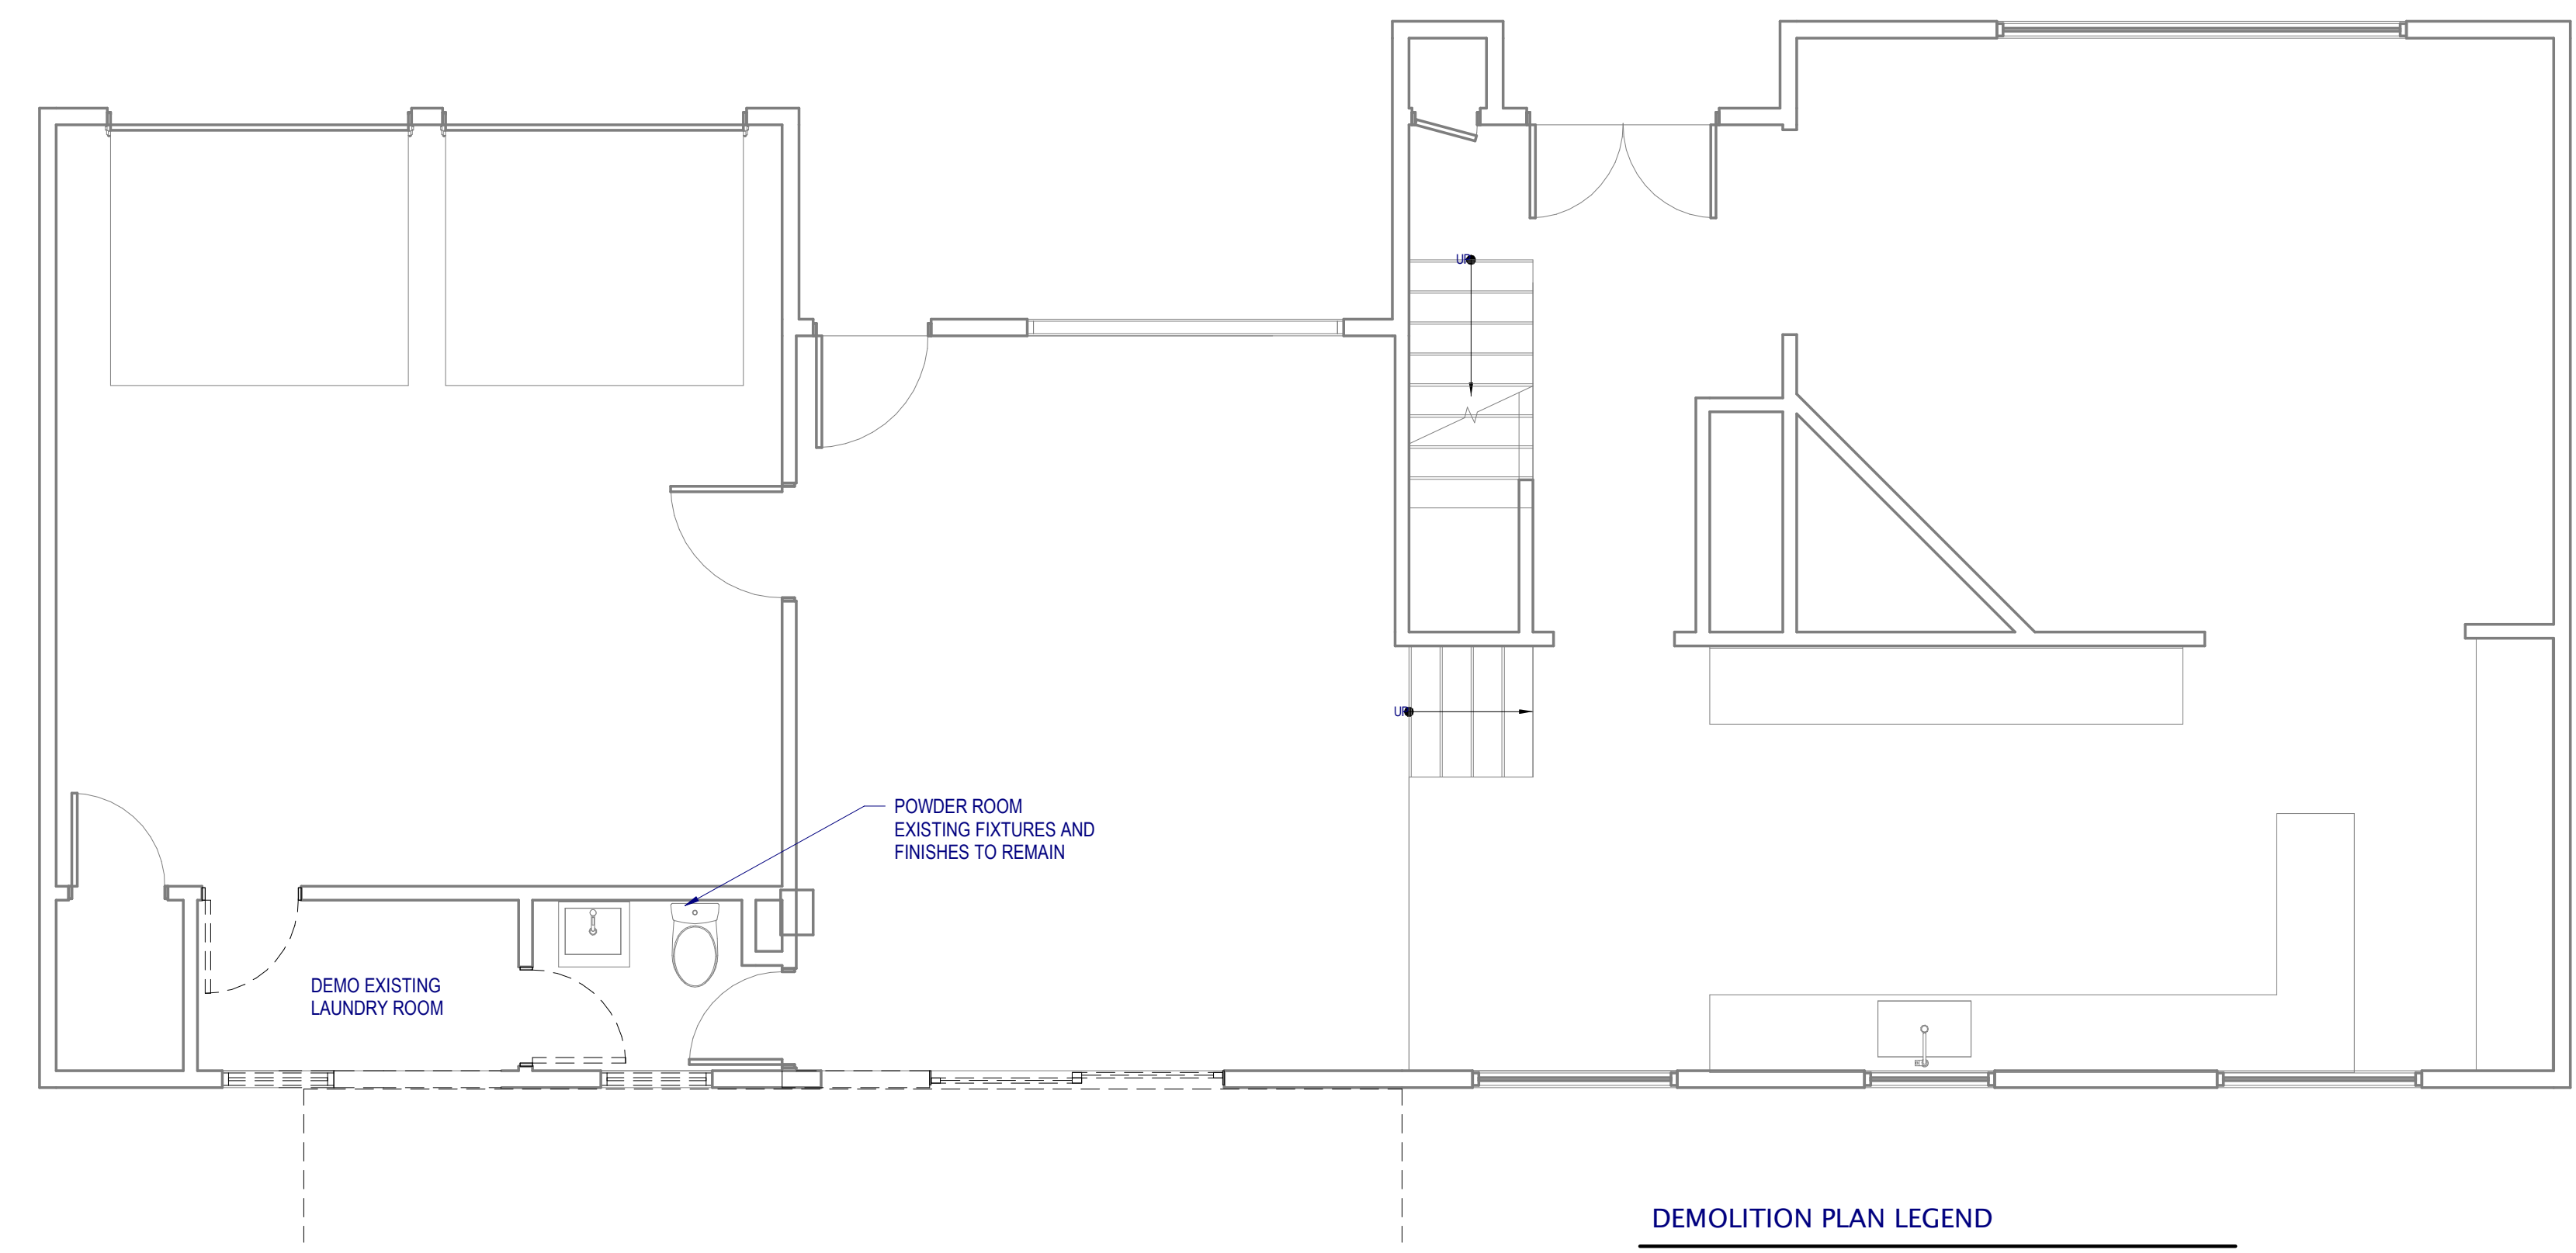


DEMOLITION PLAN LEGEND

EXISTING CONSTRUCTION TO REMAIN

EXISTING CONSTRUCTION TO BE DEMOLISHED


01 MAIN LEVEL DEMO PLAN
SCALE: 1/4" = 1'-0"

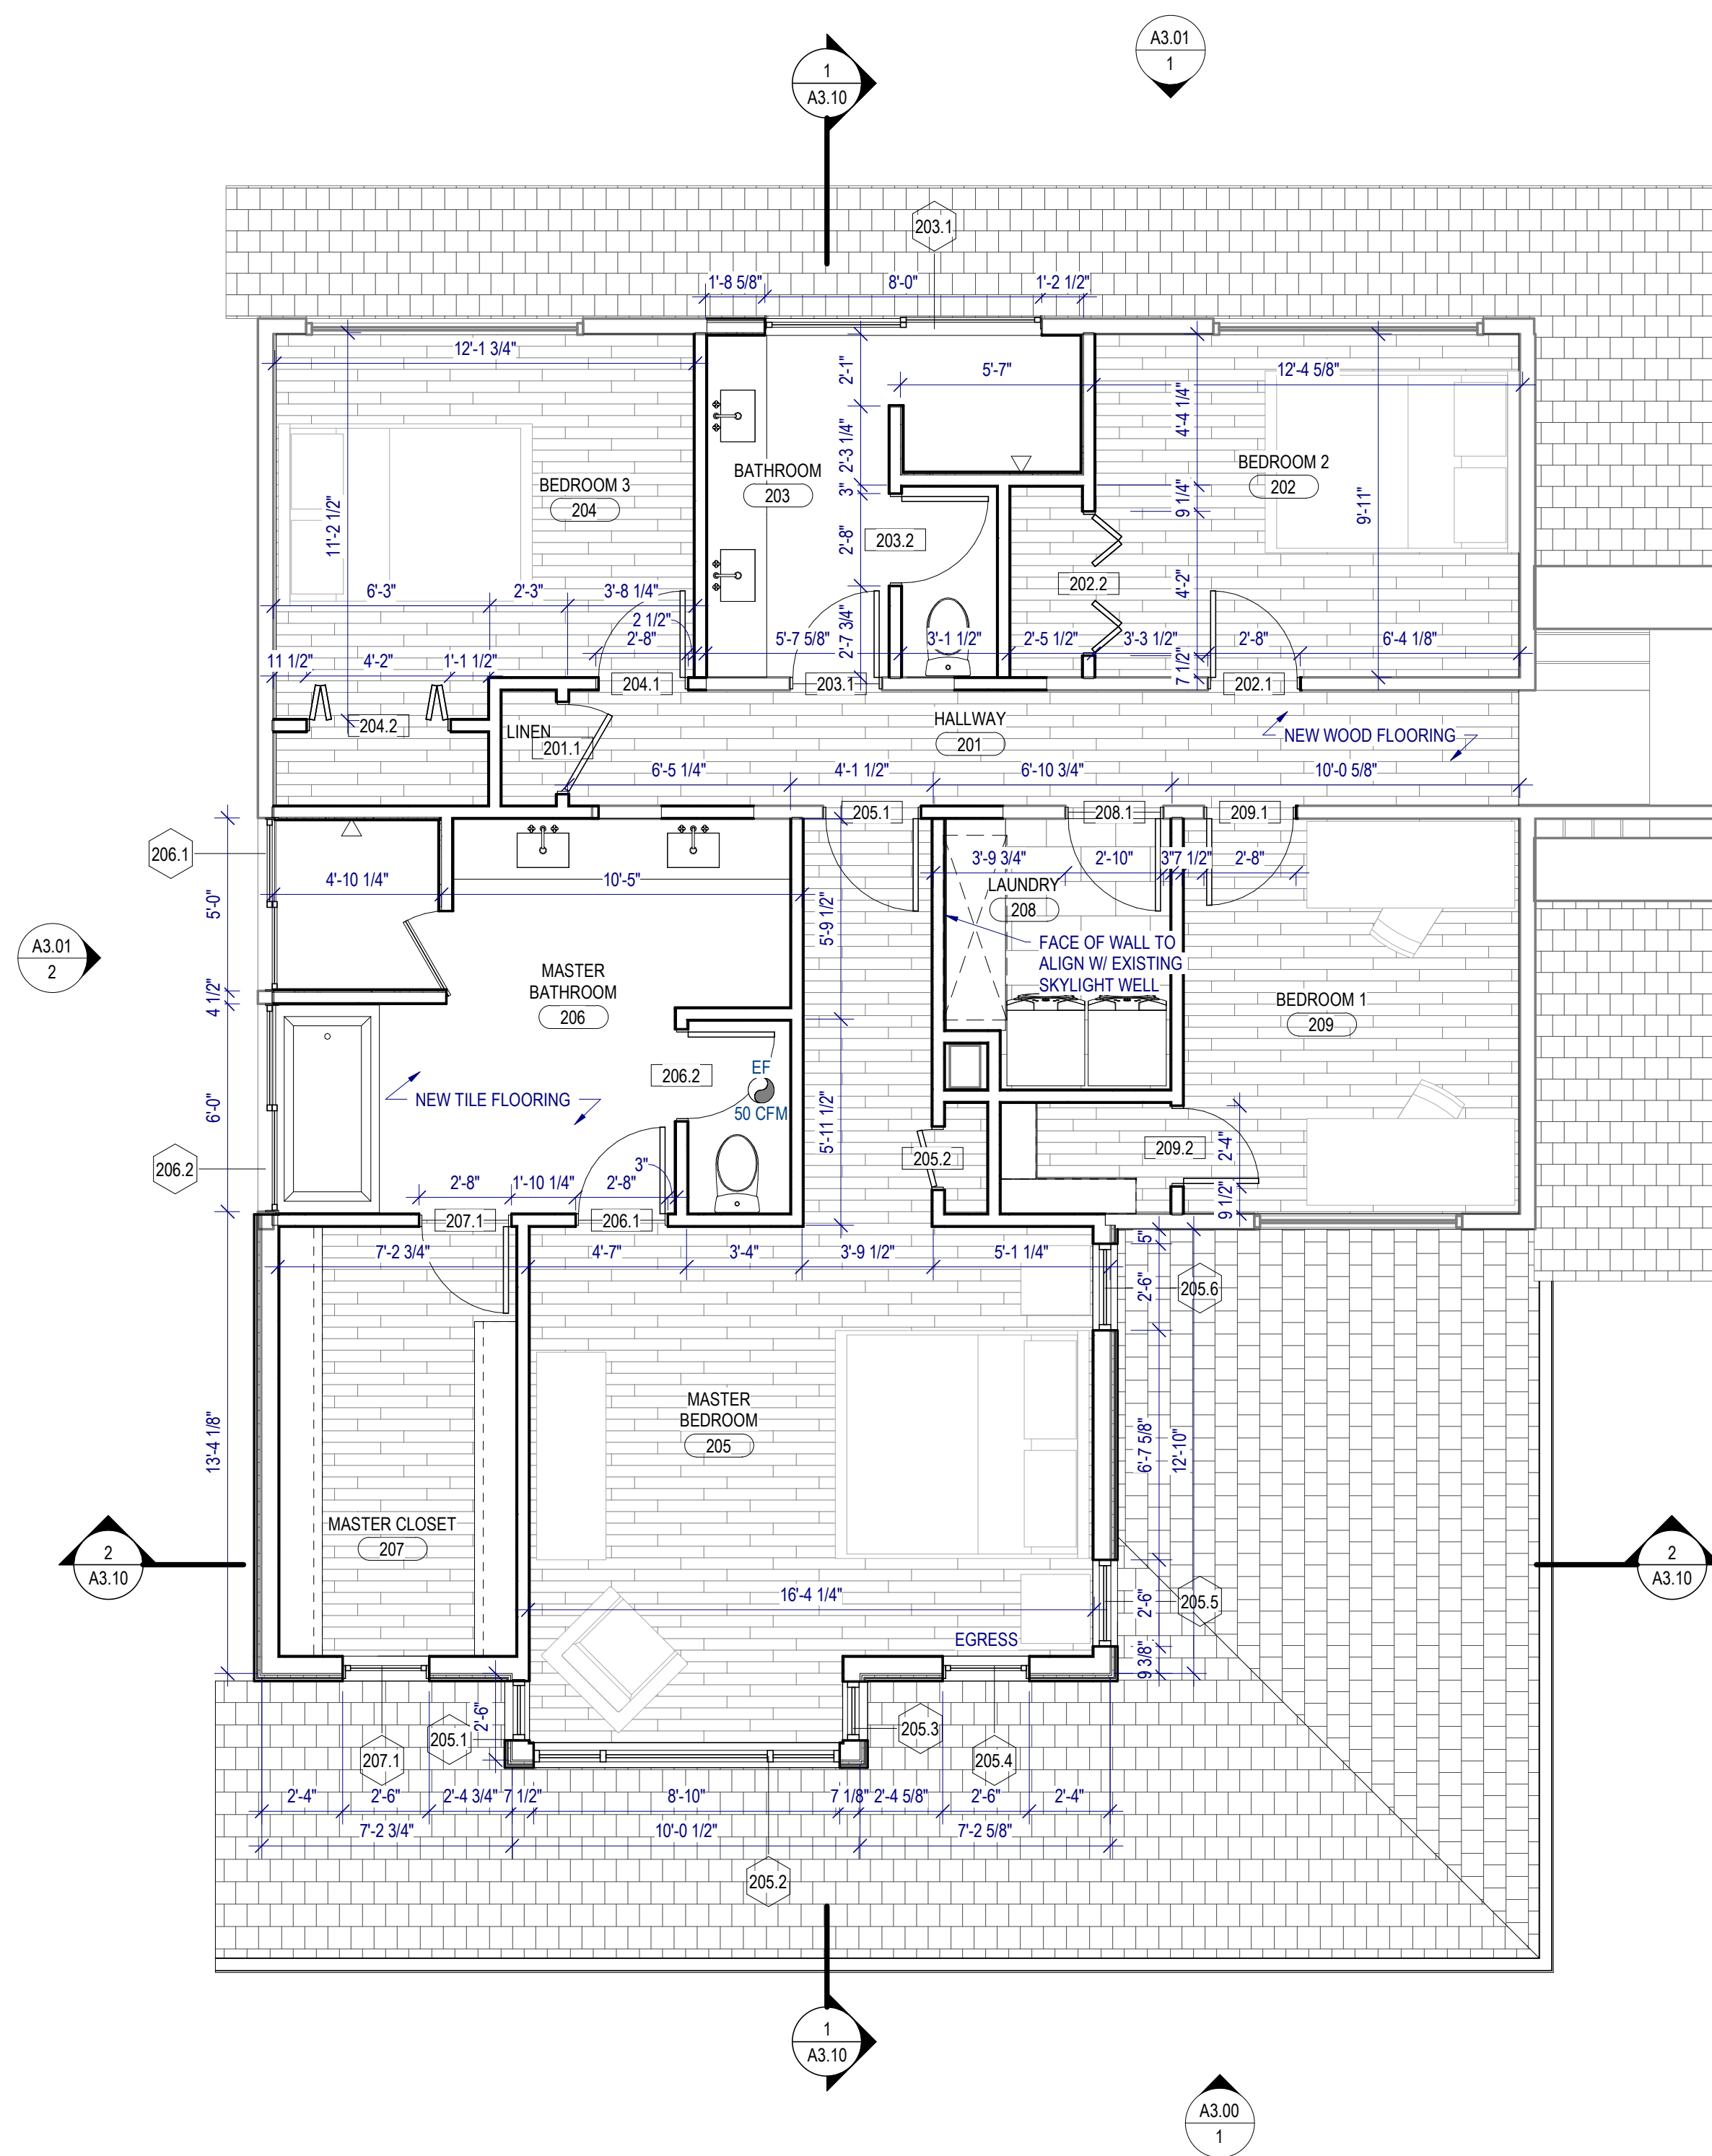

FLOOR PLAN LEGEND

EXISTING CONSTRUCTION TO REMAIN
 NEW CONSTRUCTION

2 02 UPPER LEVEL PLAN
SCALE: 1/4" = 1'-0"

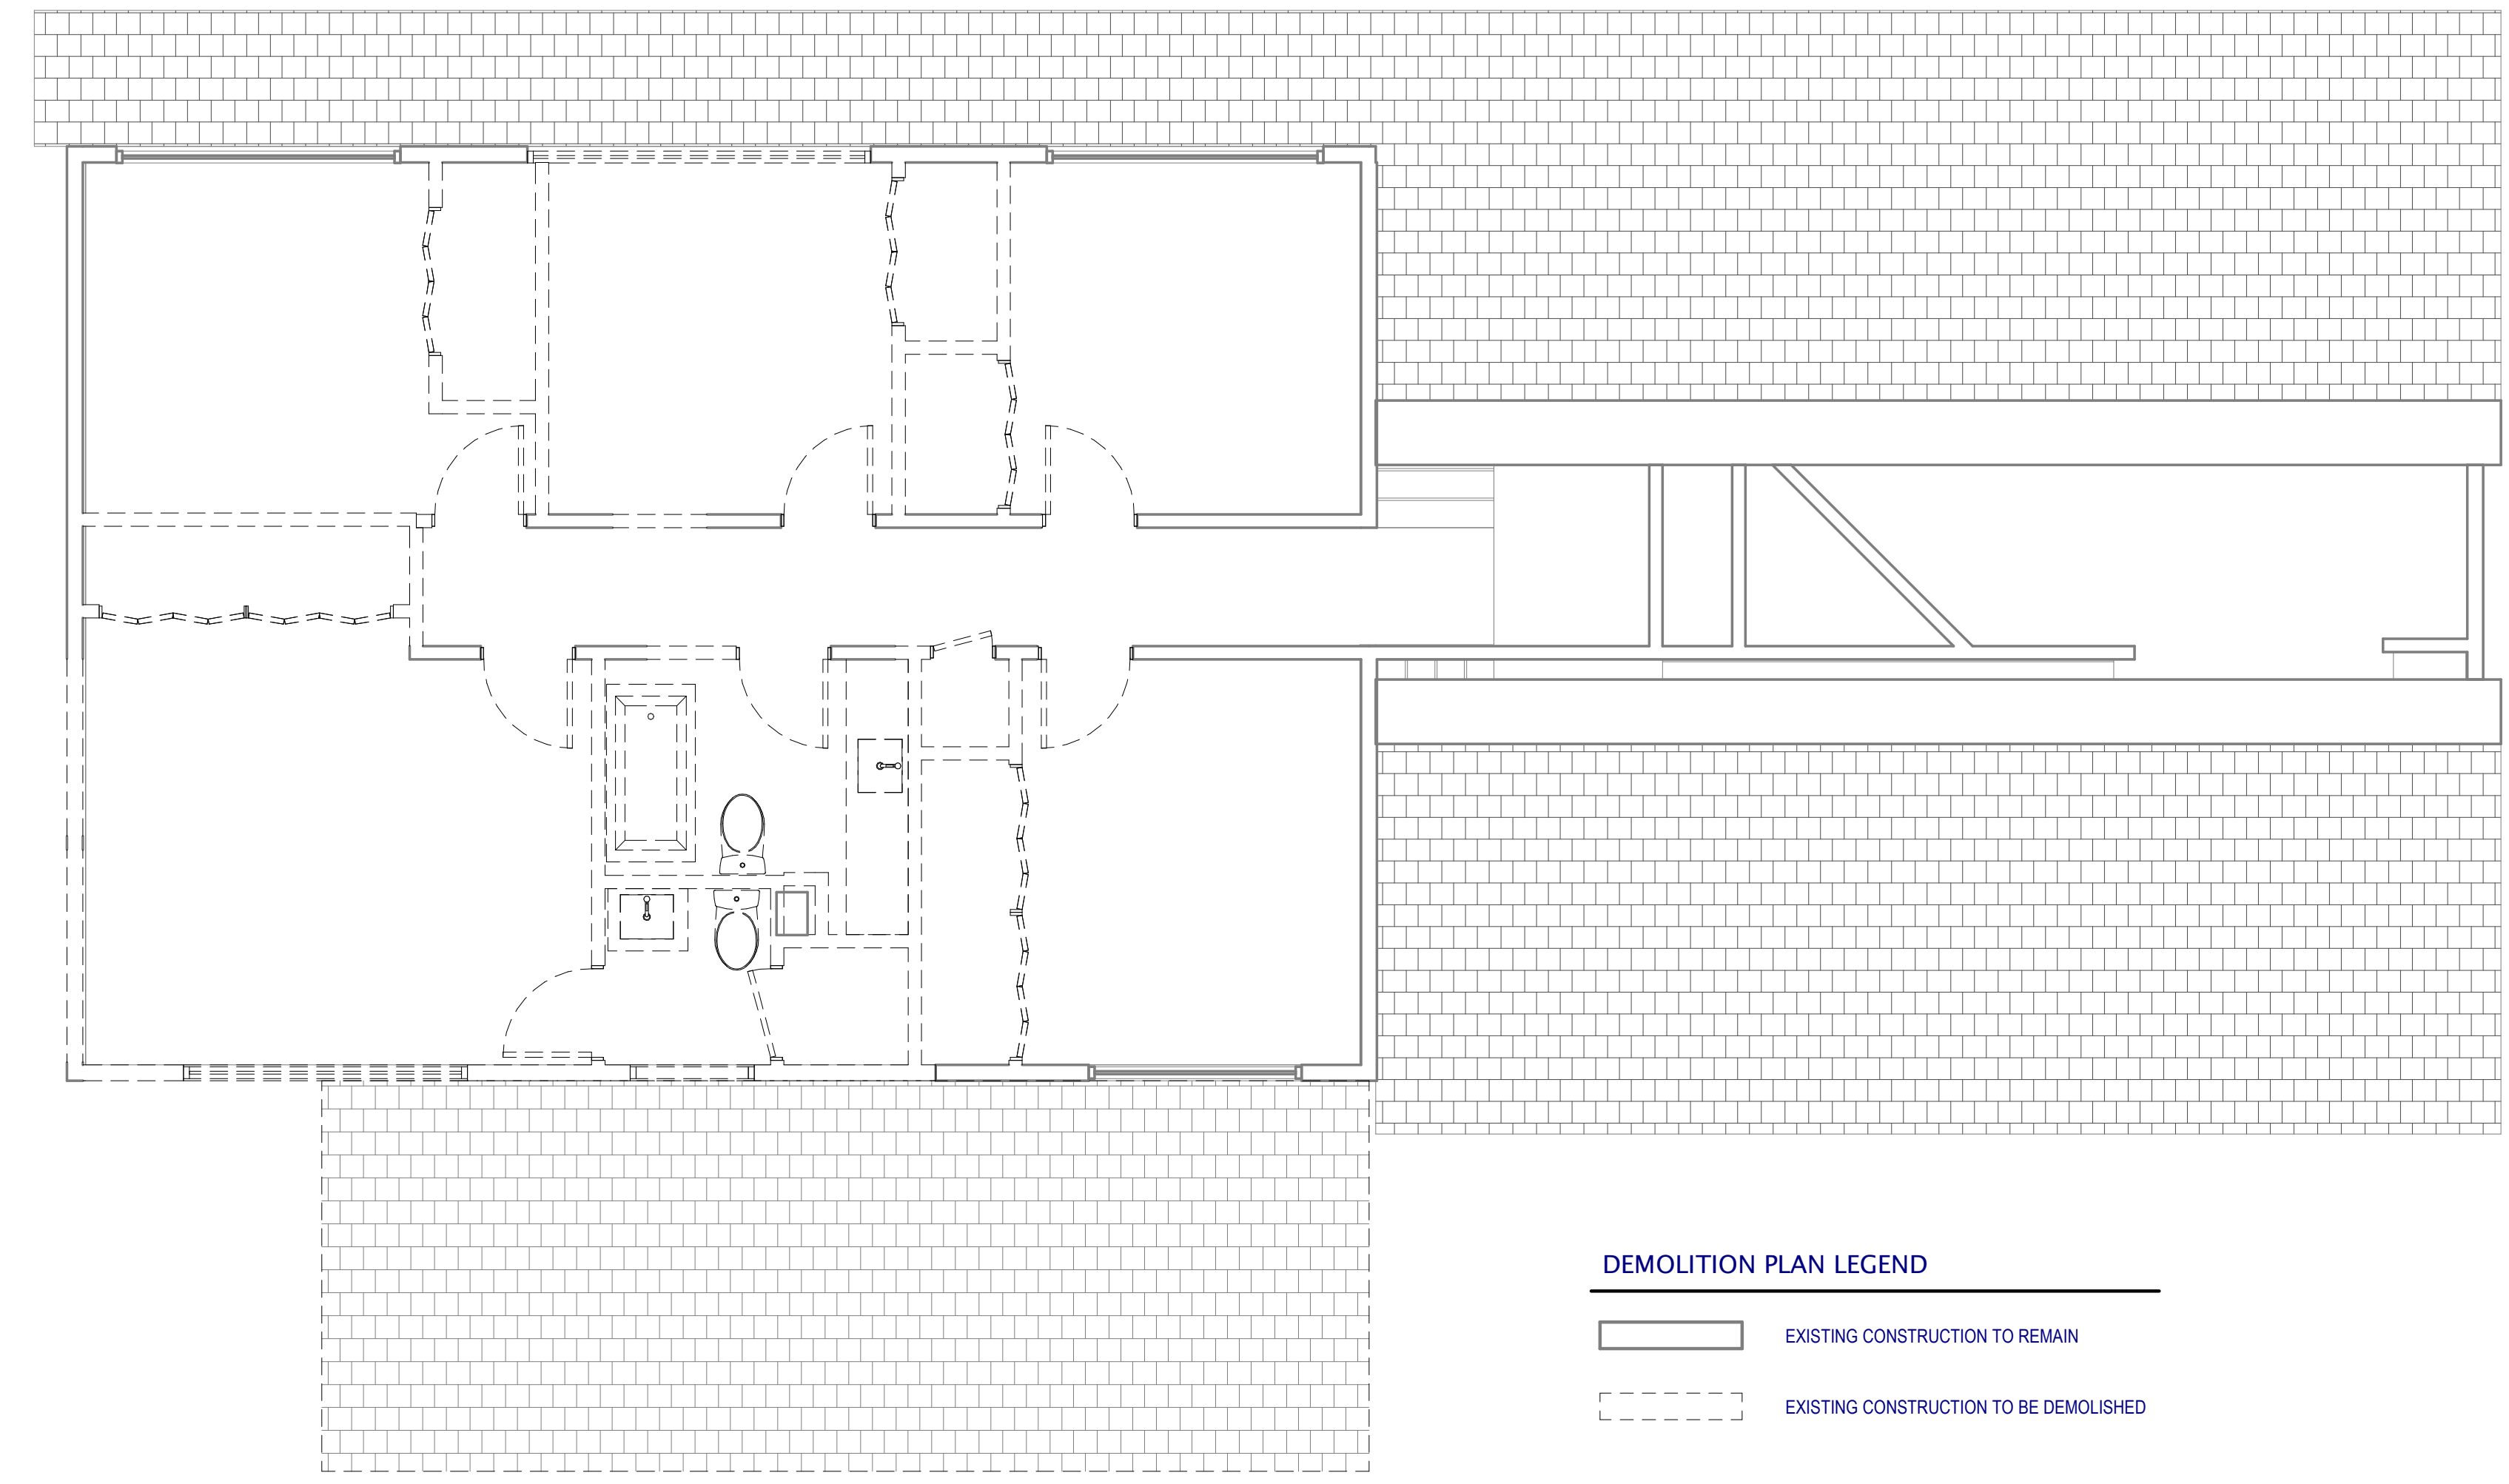

DEMOLITION PLAN LEGEND

EXISTING CONSTRUCTION TO REMAIN
 EXISTING CONSTRUCTION TO BE DEMOLISHED




1 02 UPPER LEVEL DEMO PLAN
SCALE: 1/4" = 1'-0"

principal architect _____
 project manager _____
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 Author
 checked by _____
 job no. _____
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02/13/2023



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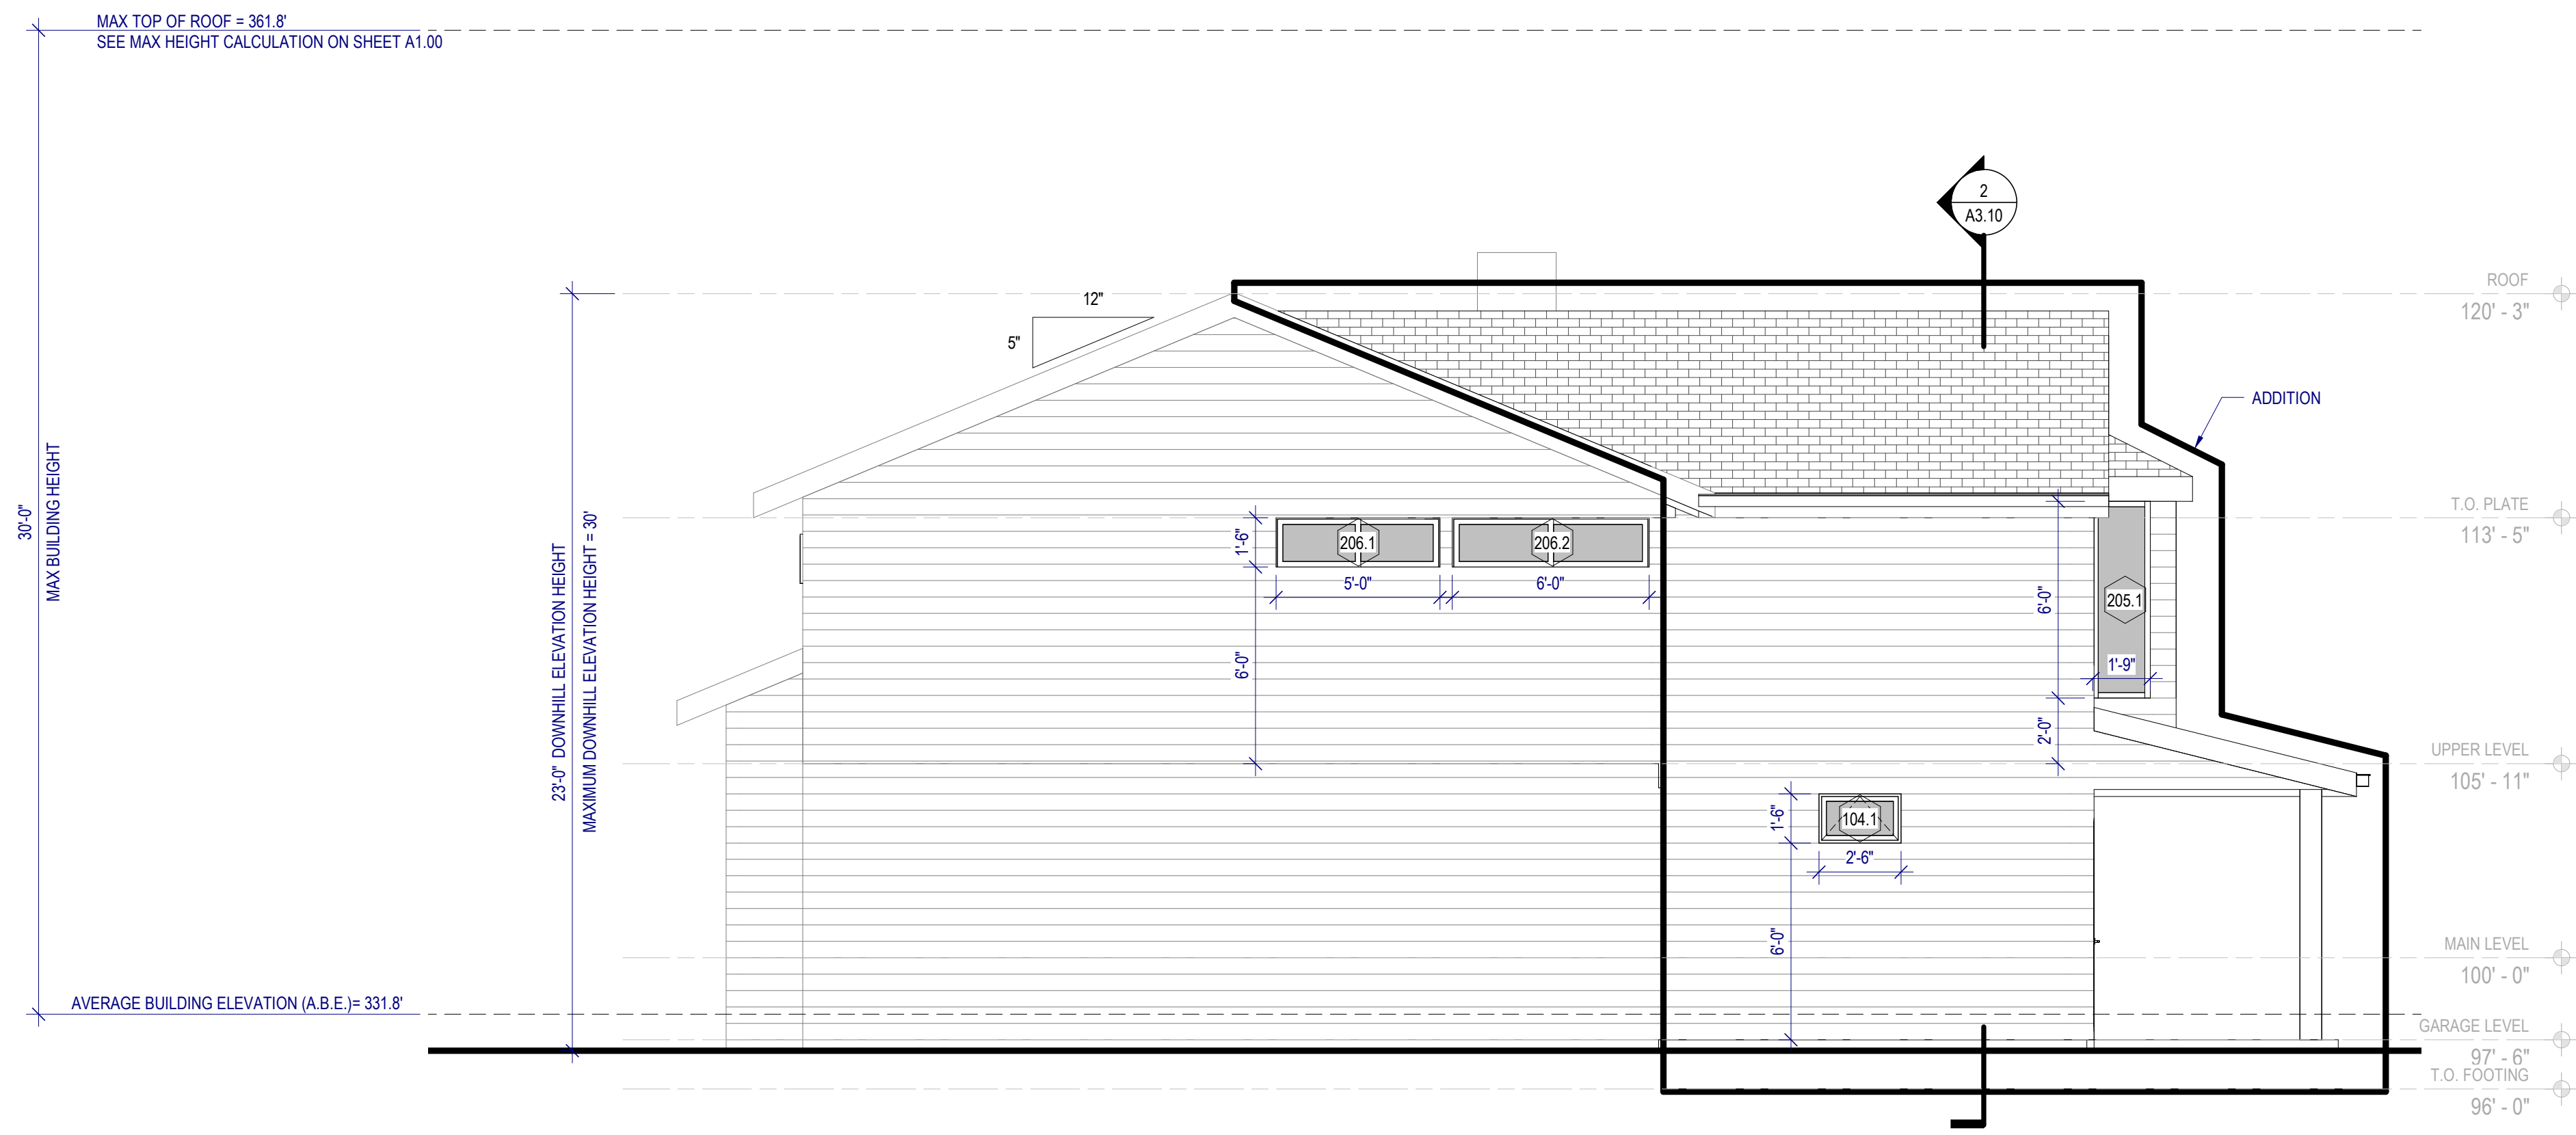
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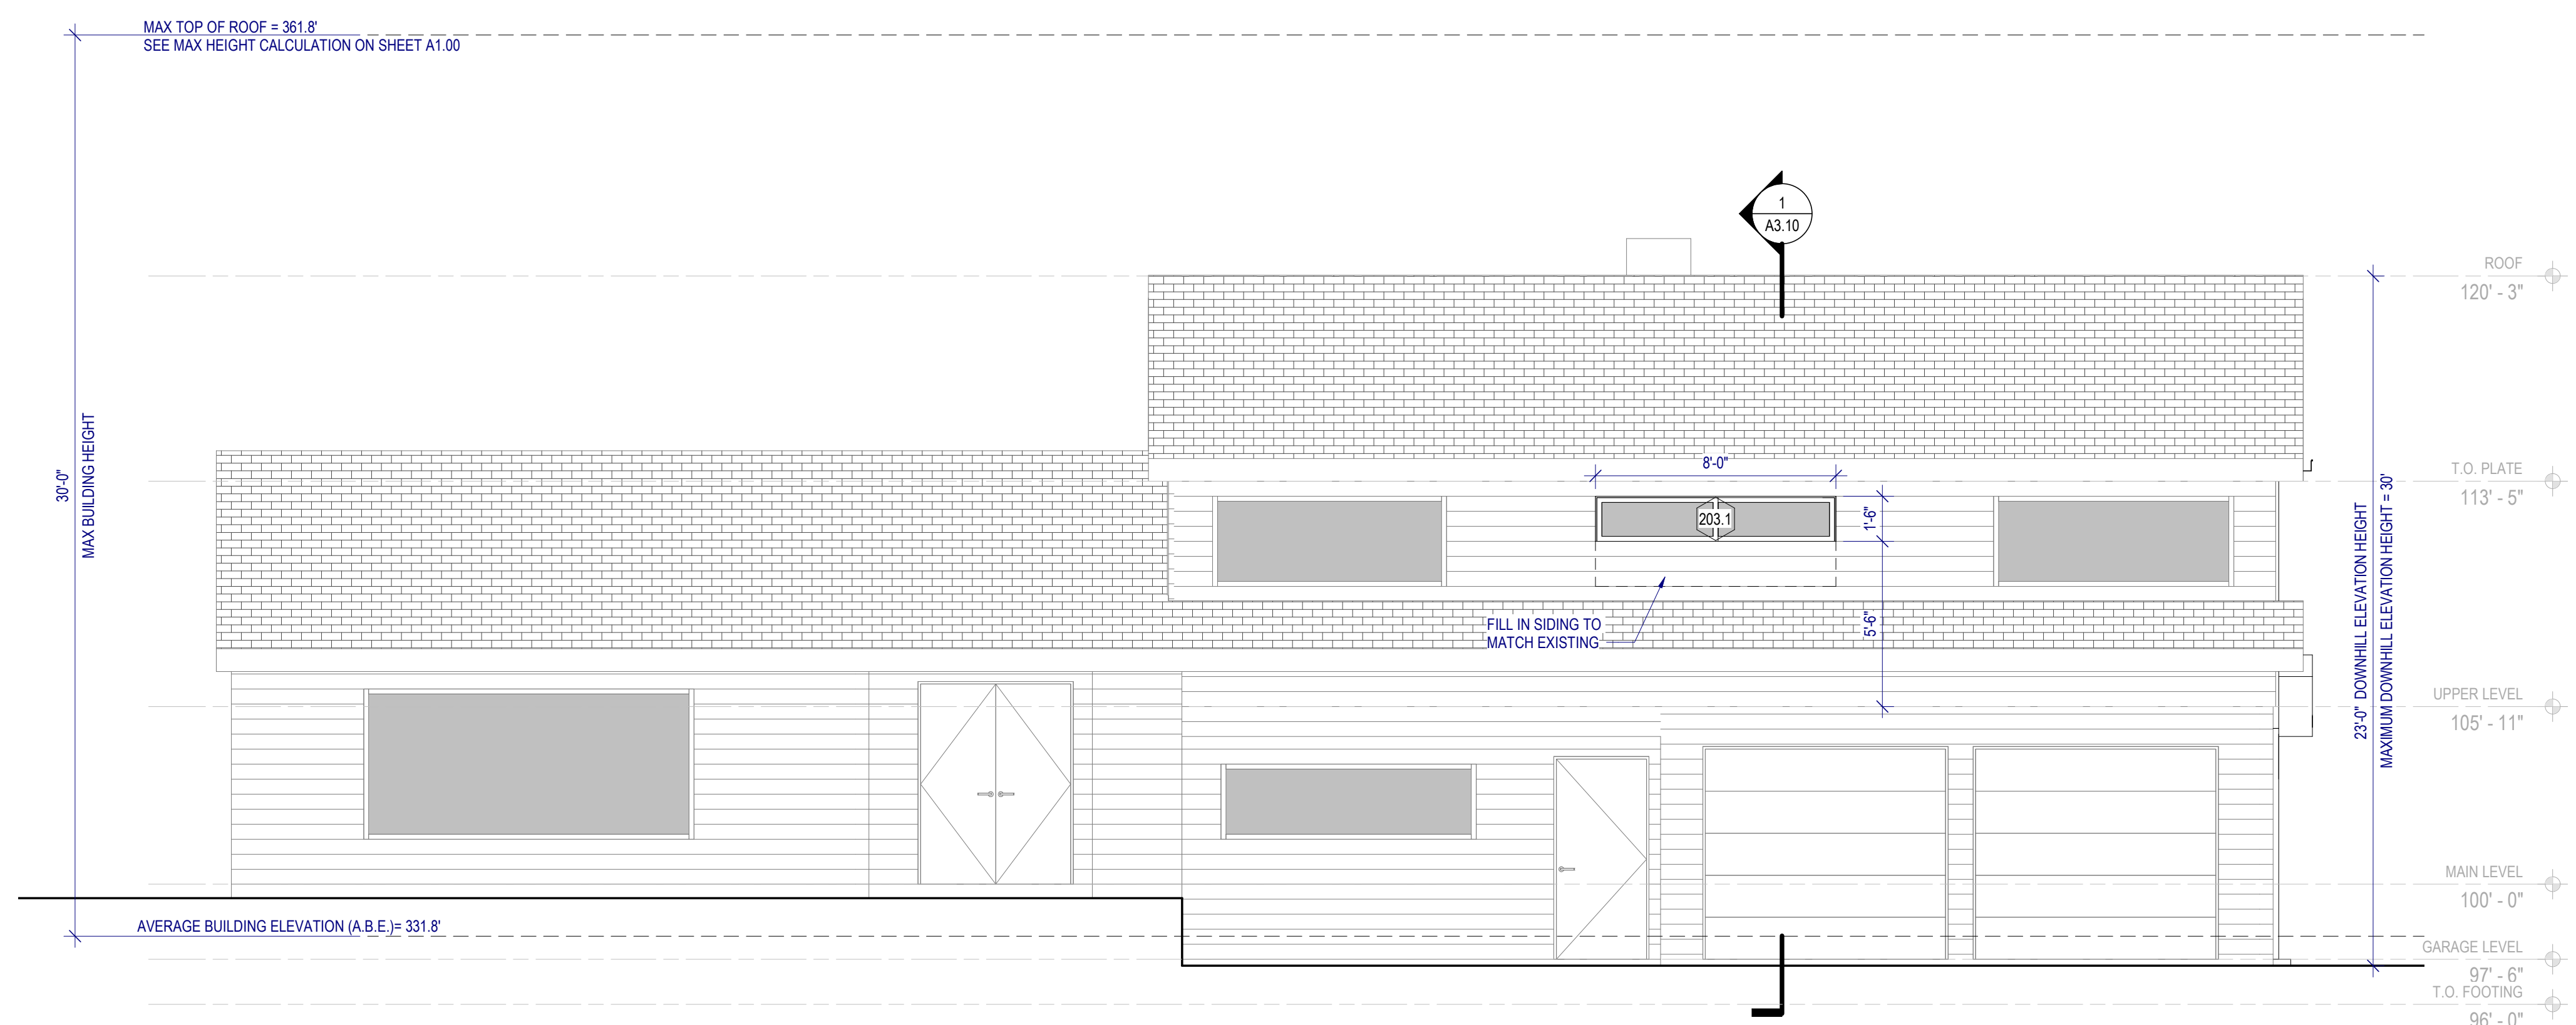
EXTERIOR ELEVATIONS

A3.00

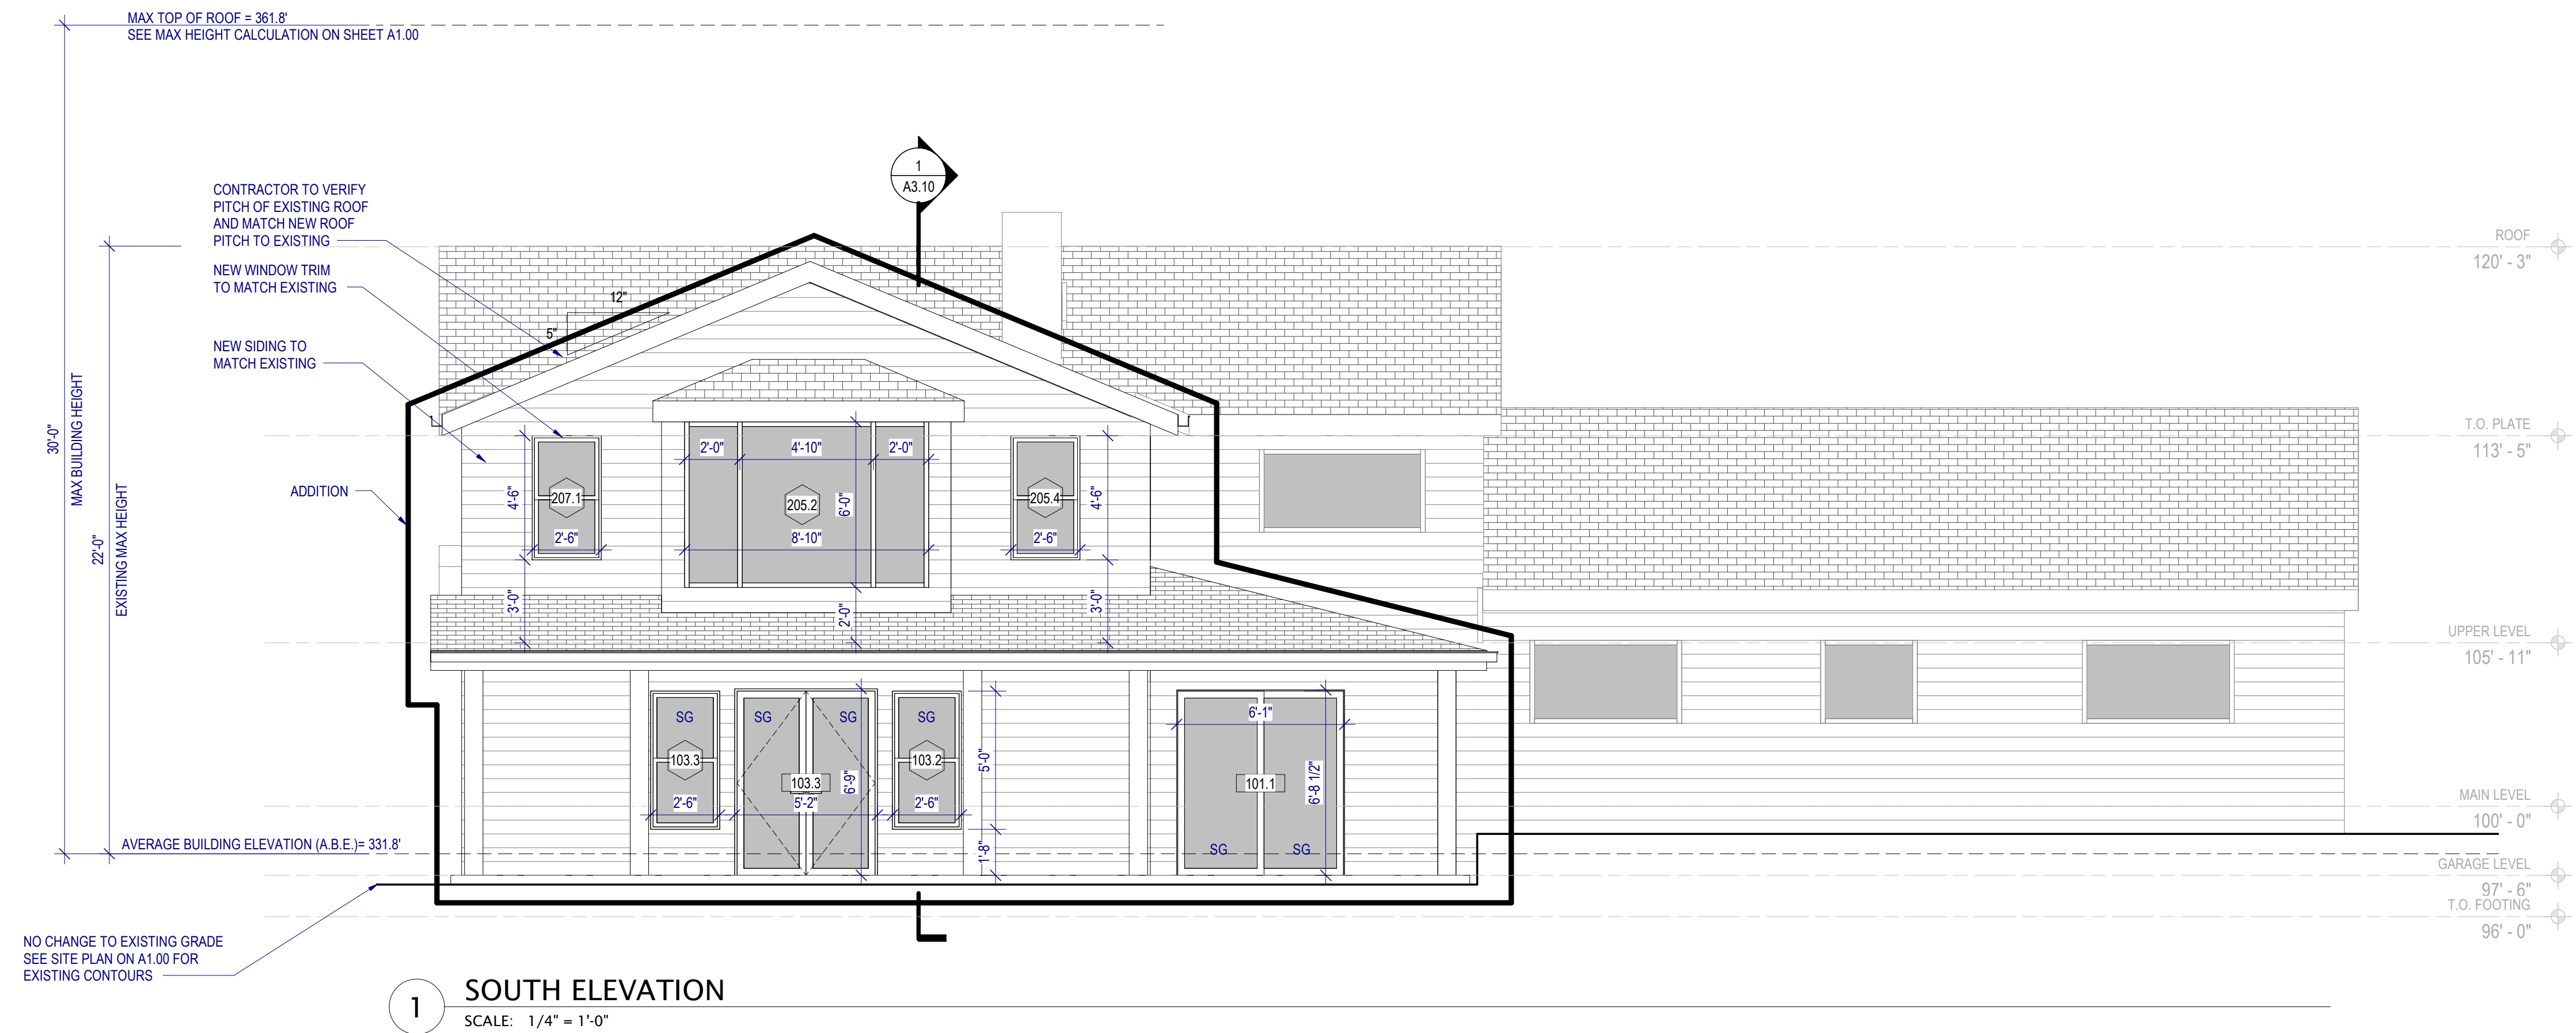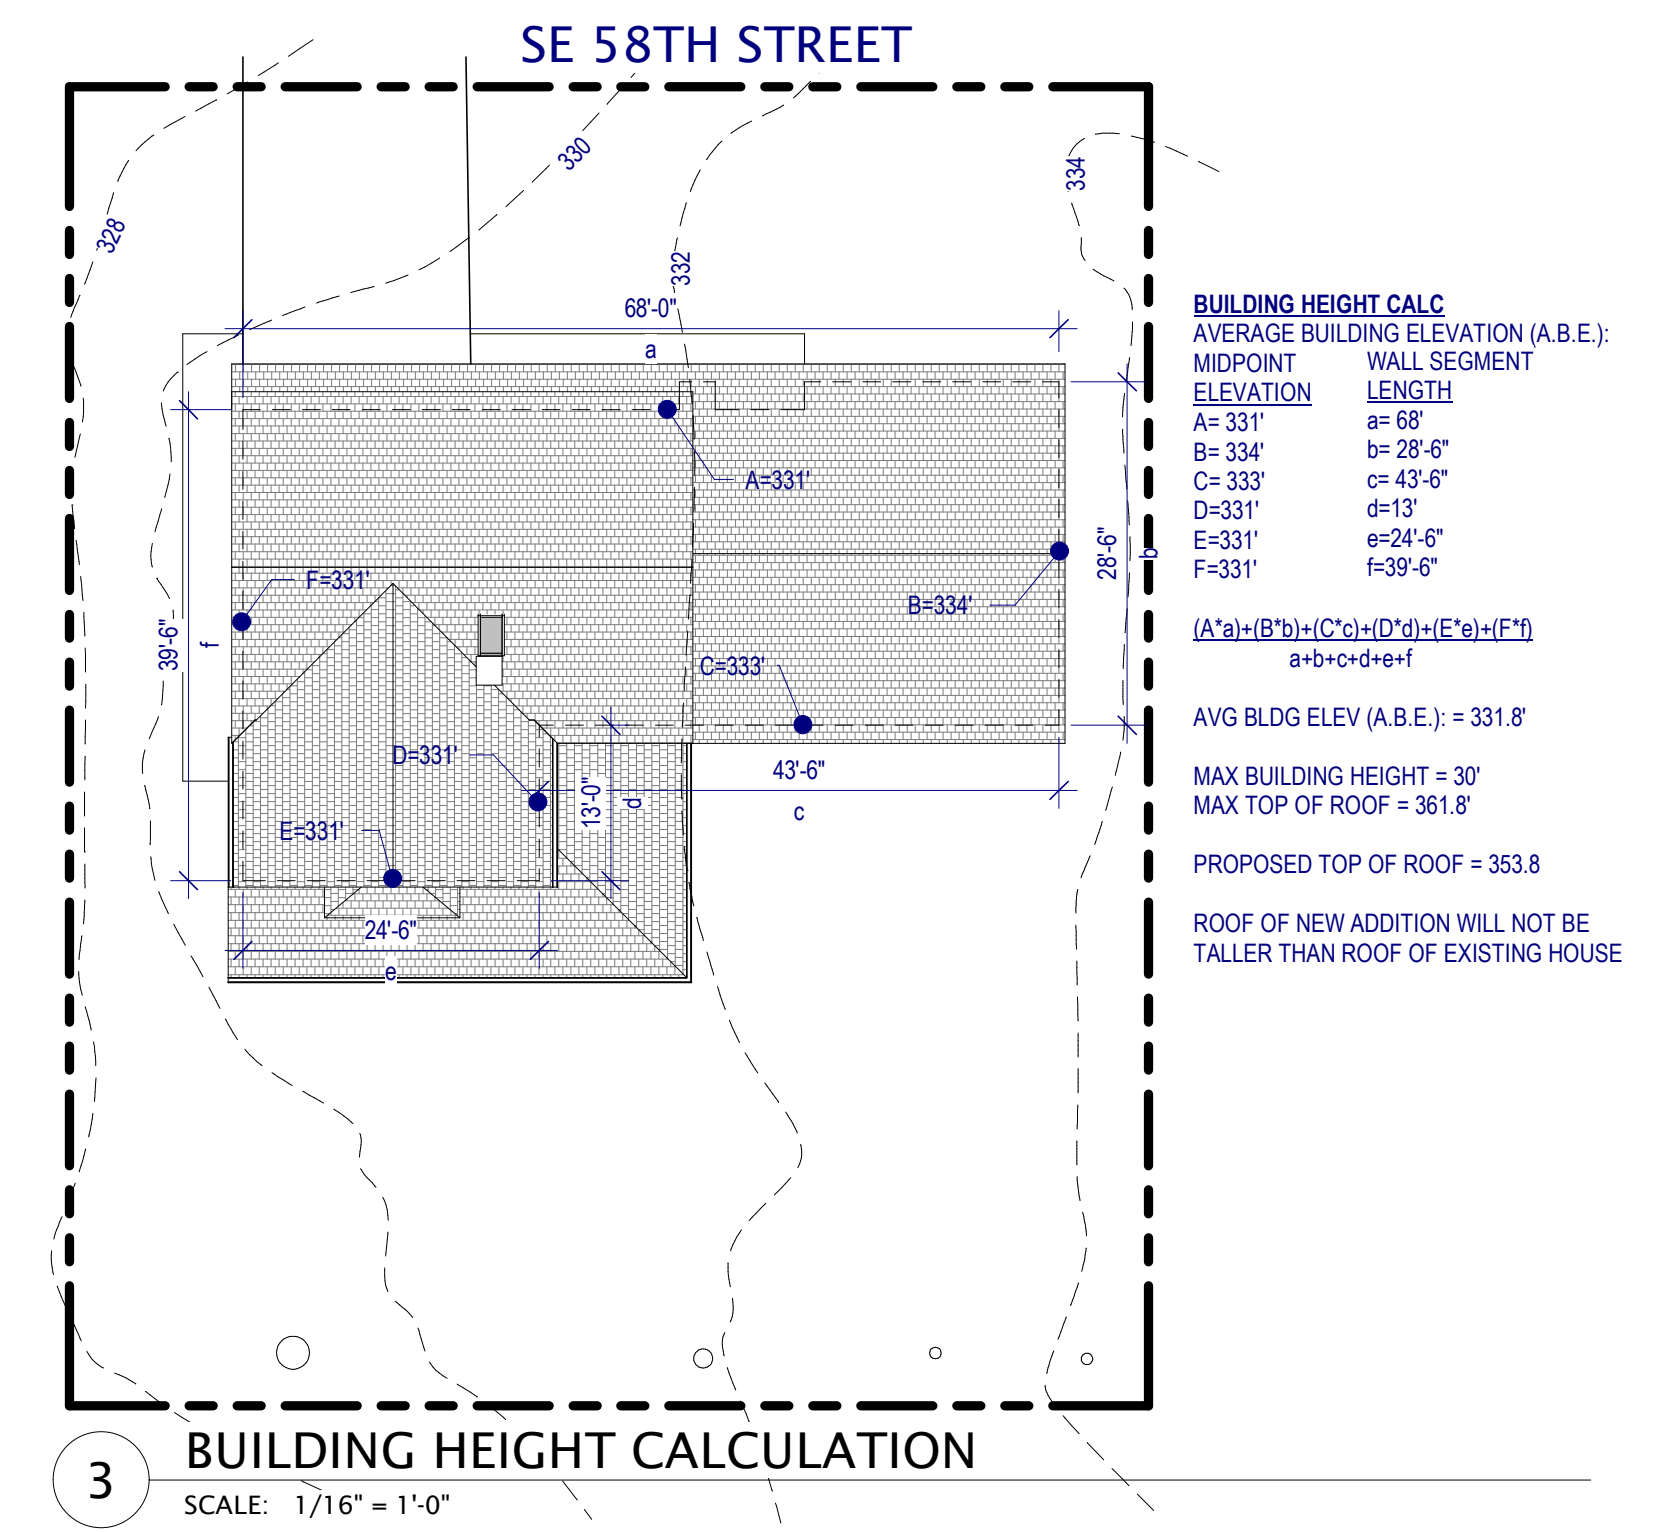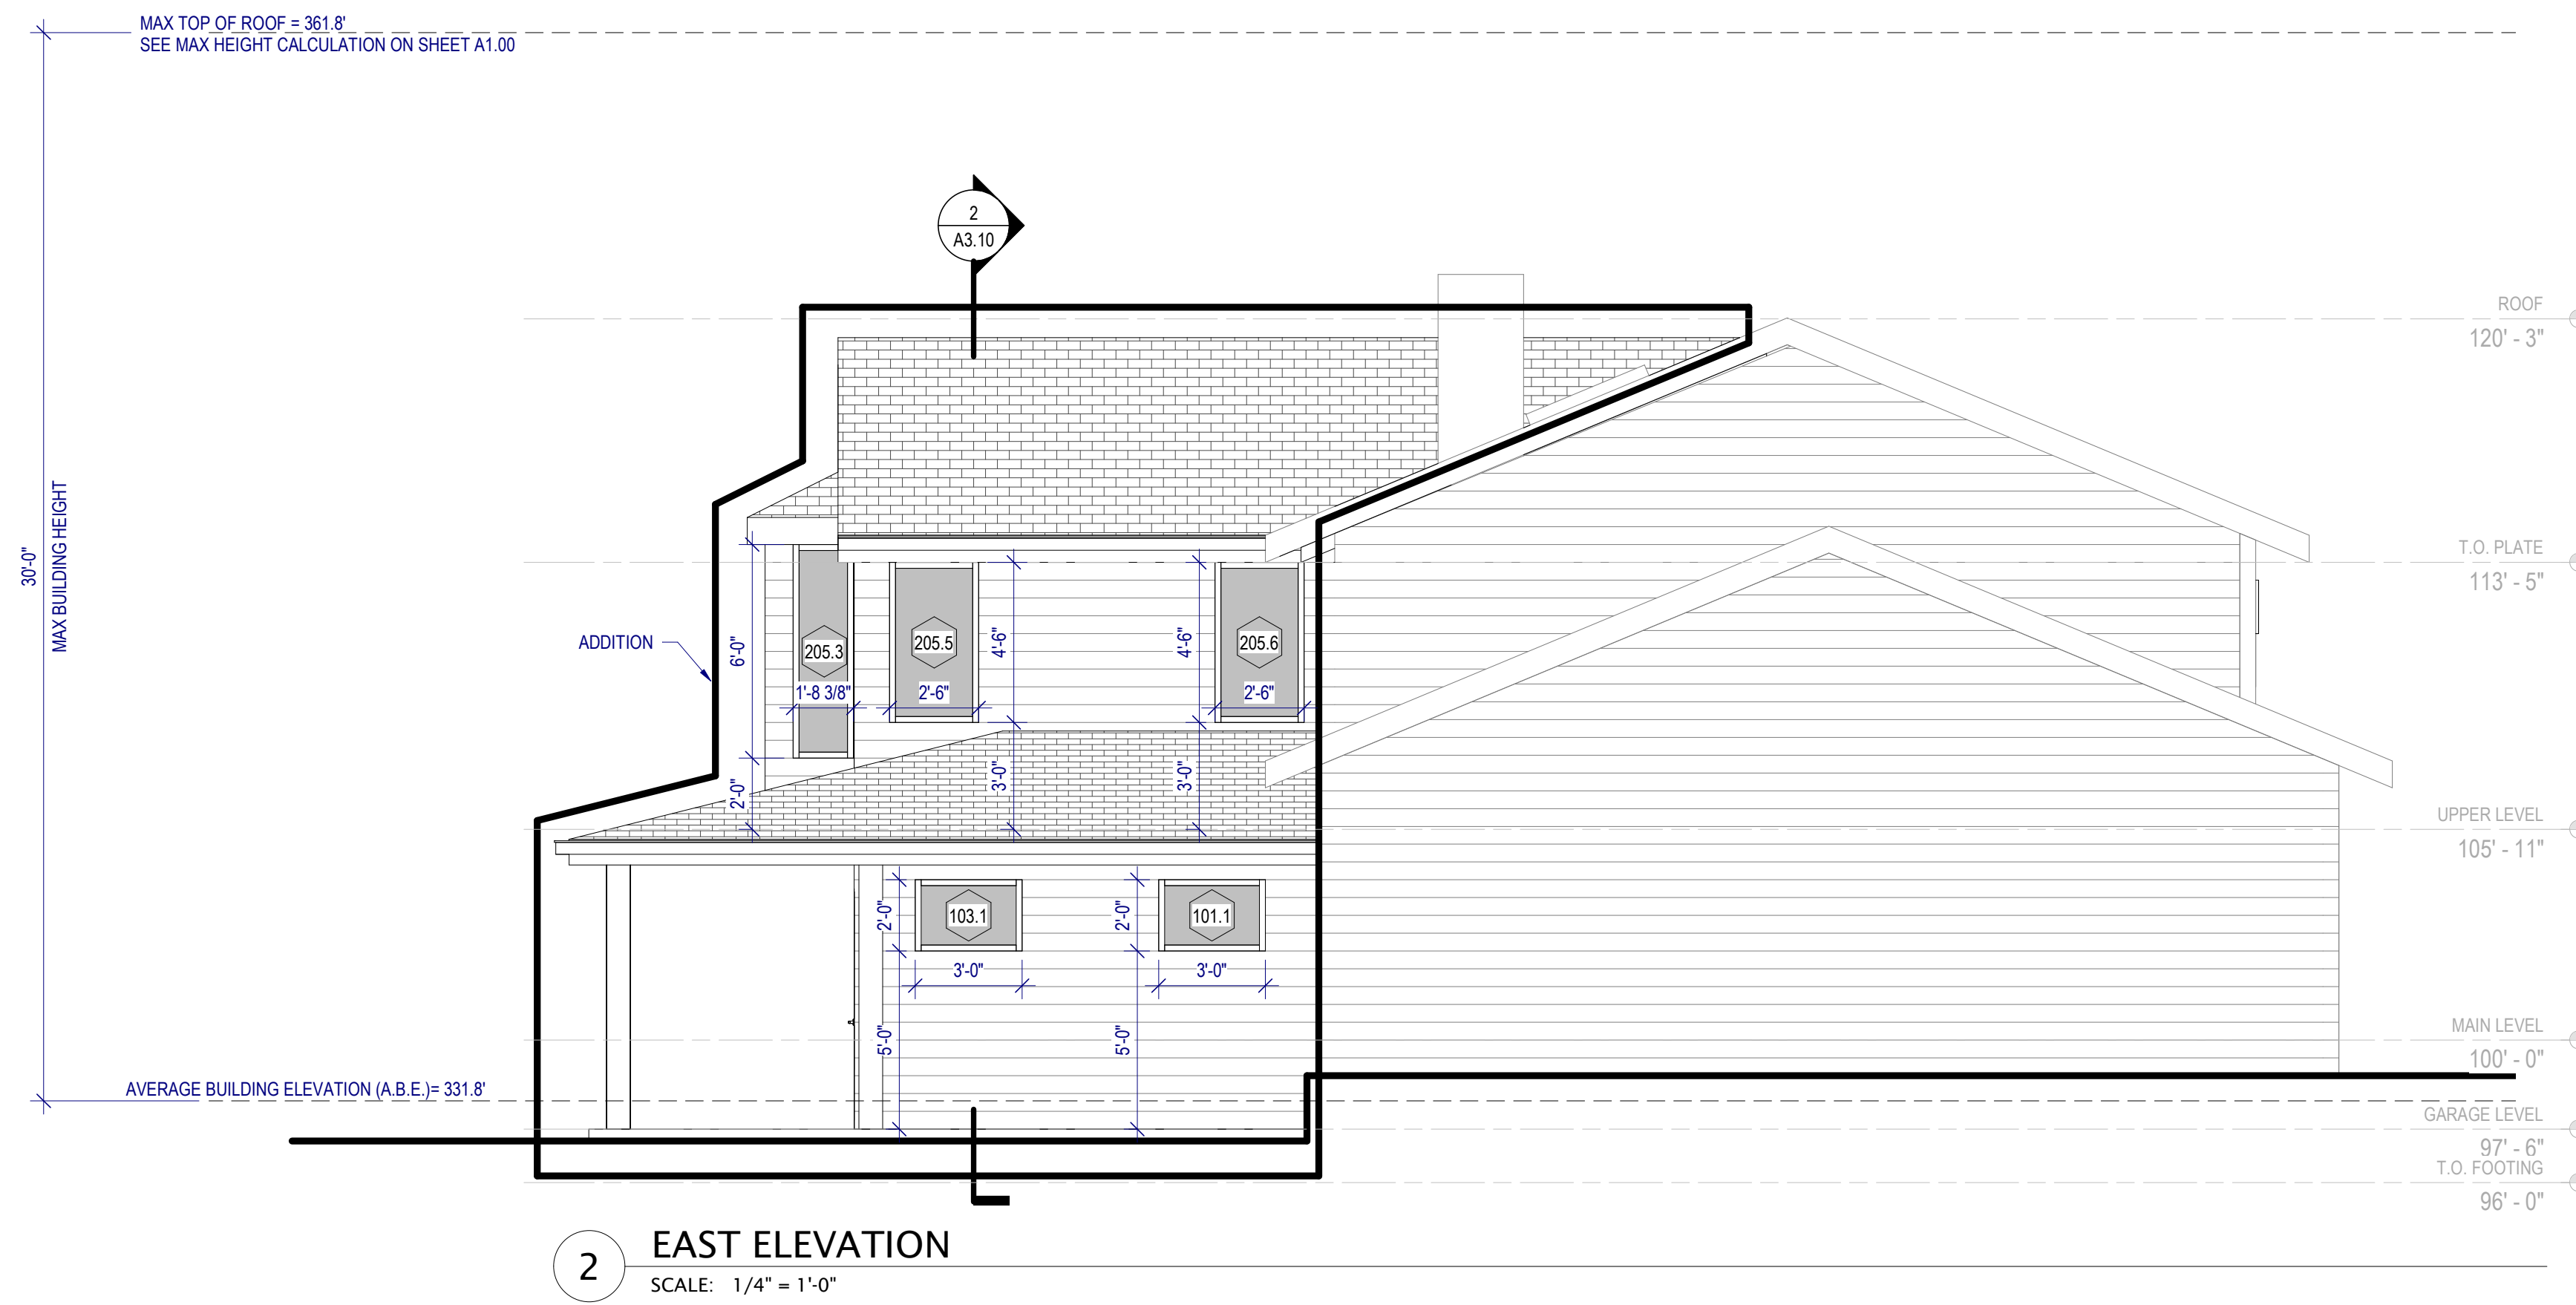065_WINDOWS						
MARK	DIMENSIONS (ROUGH OPENING)			U VALUE	UA VALUE	REMARKS
	WIDTH	HEIGHT	AREA			
101.1	3'-0"	2'-0"	6 SF	0.25	2	
103.1	3'-0"	2'-0"	6 SF	0.25	2	
103.2	2'-6"	5'-0"	13 SF	0.25	3	DOUBLE HUNG, SAFETY GLAZING
103.3	2'-6"	5'-0"	13 SF	0.25	3	DOUBLE HUNG, SAFETY GLAZING
104.1	2'-6"	1'-6"	4 SF	0.25	1	AWNING
203.1	8'-0"	1'-6"	12 SF	0.25	3	SLIDER
205.1	1'-9"	6'-0"	11 SF	0.25	3	FIXED
205.2	8'-10"	6'-0"	53 SF	0.25	13	FIXED
205.3	2'-1"	4'-11"	10 SF	0.25	3	FIXED
205.4	2'-6"	4'-6"	11 SF	0.25	3	DOUBLE HUNG - EGRESS
205.5	2'-6"	4'-6"	11 SF	0.25	3	FIXED
205.6	2'-6"	4'-6"	11 SF	0.25	3	FIXED
206.1	5'-4 1/4"	1'-4 3/4"	8 SF	0.25	2	SLIDER
206.2	6'-5 3/4"	1'-4 3/4"	9 SF	0.25	2	SLIDER
207.1	2'-6"	4'-6"	11 SF	0.25	3	DOUBLE HUNG
15			188 SF		47	



2 WEST ELEVATION
SCALE: 1/4" = 1'-0"




1 NORTH ELEVATION
SCALE: 1/4" = 1'-0"

principal architect _____
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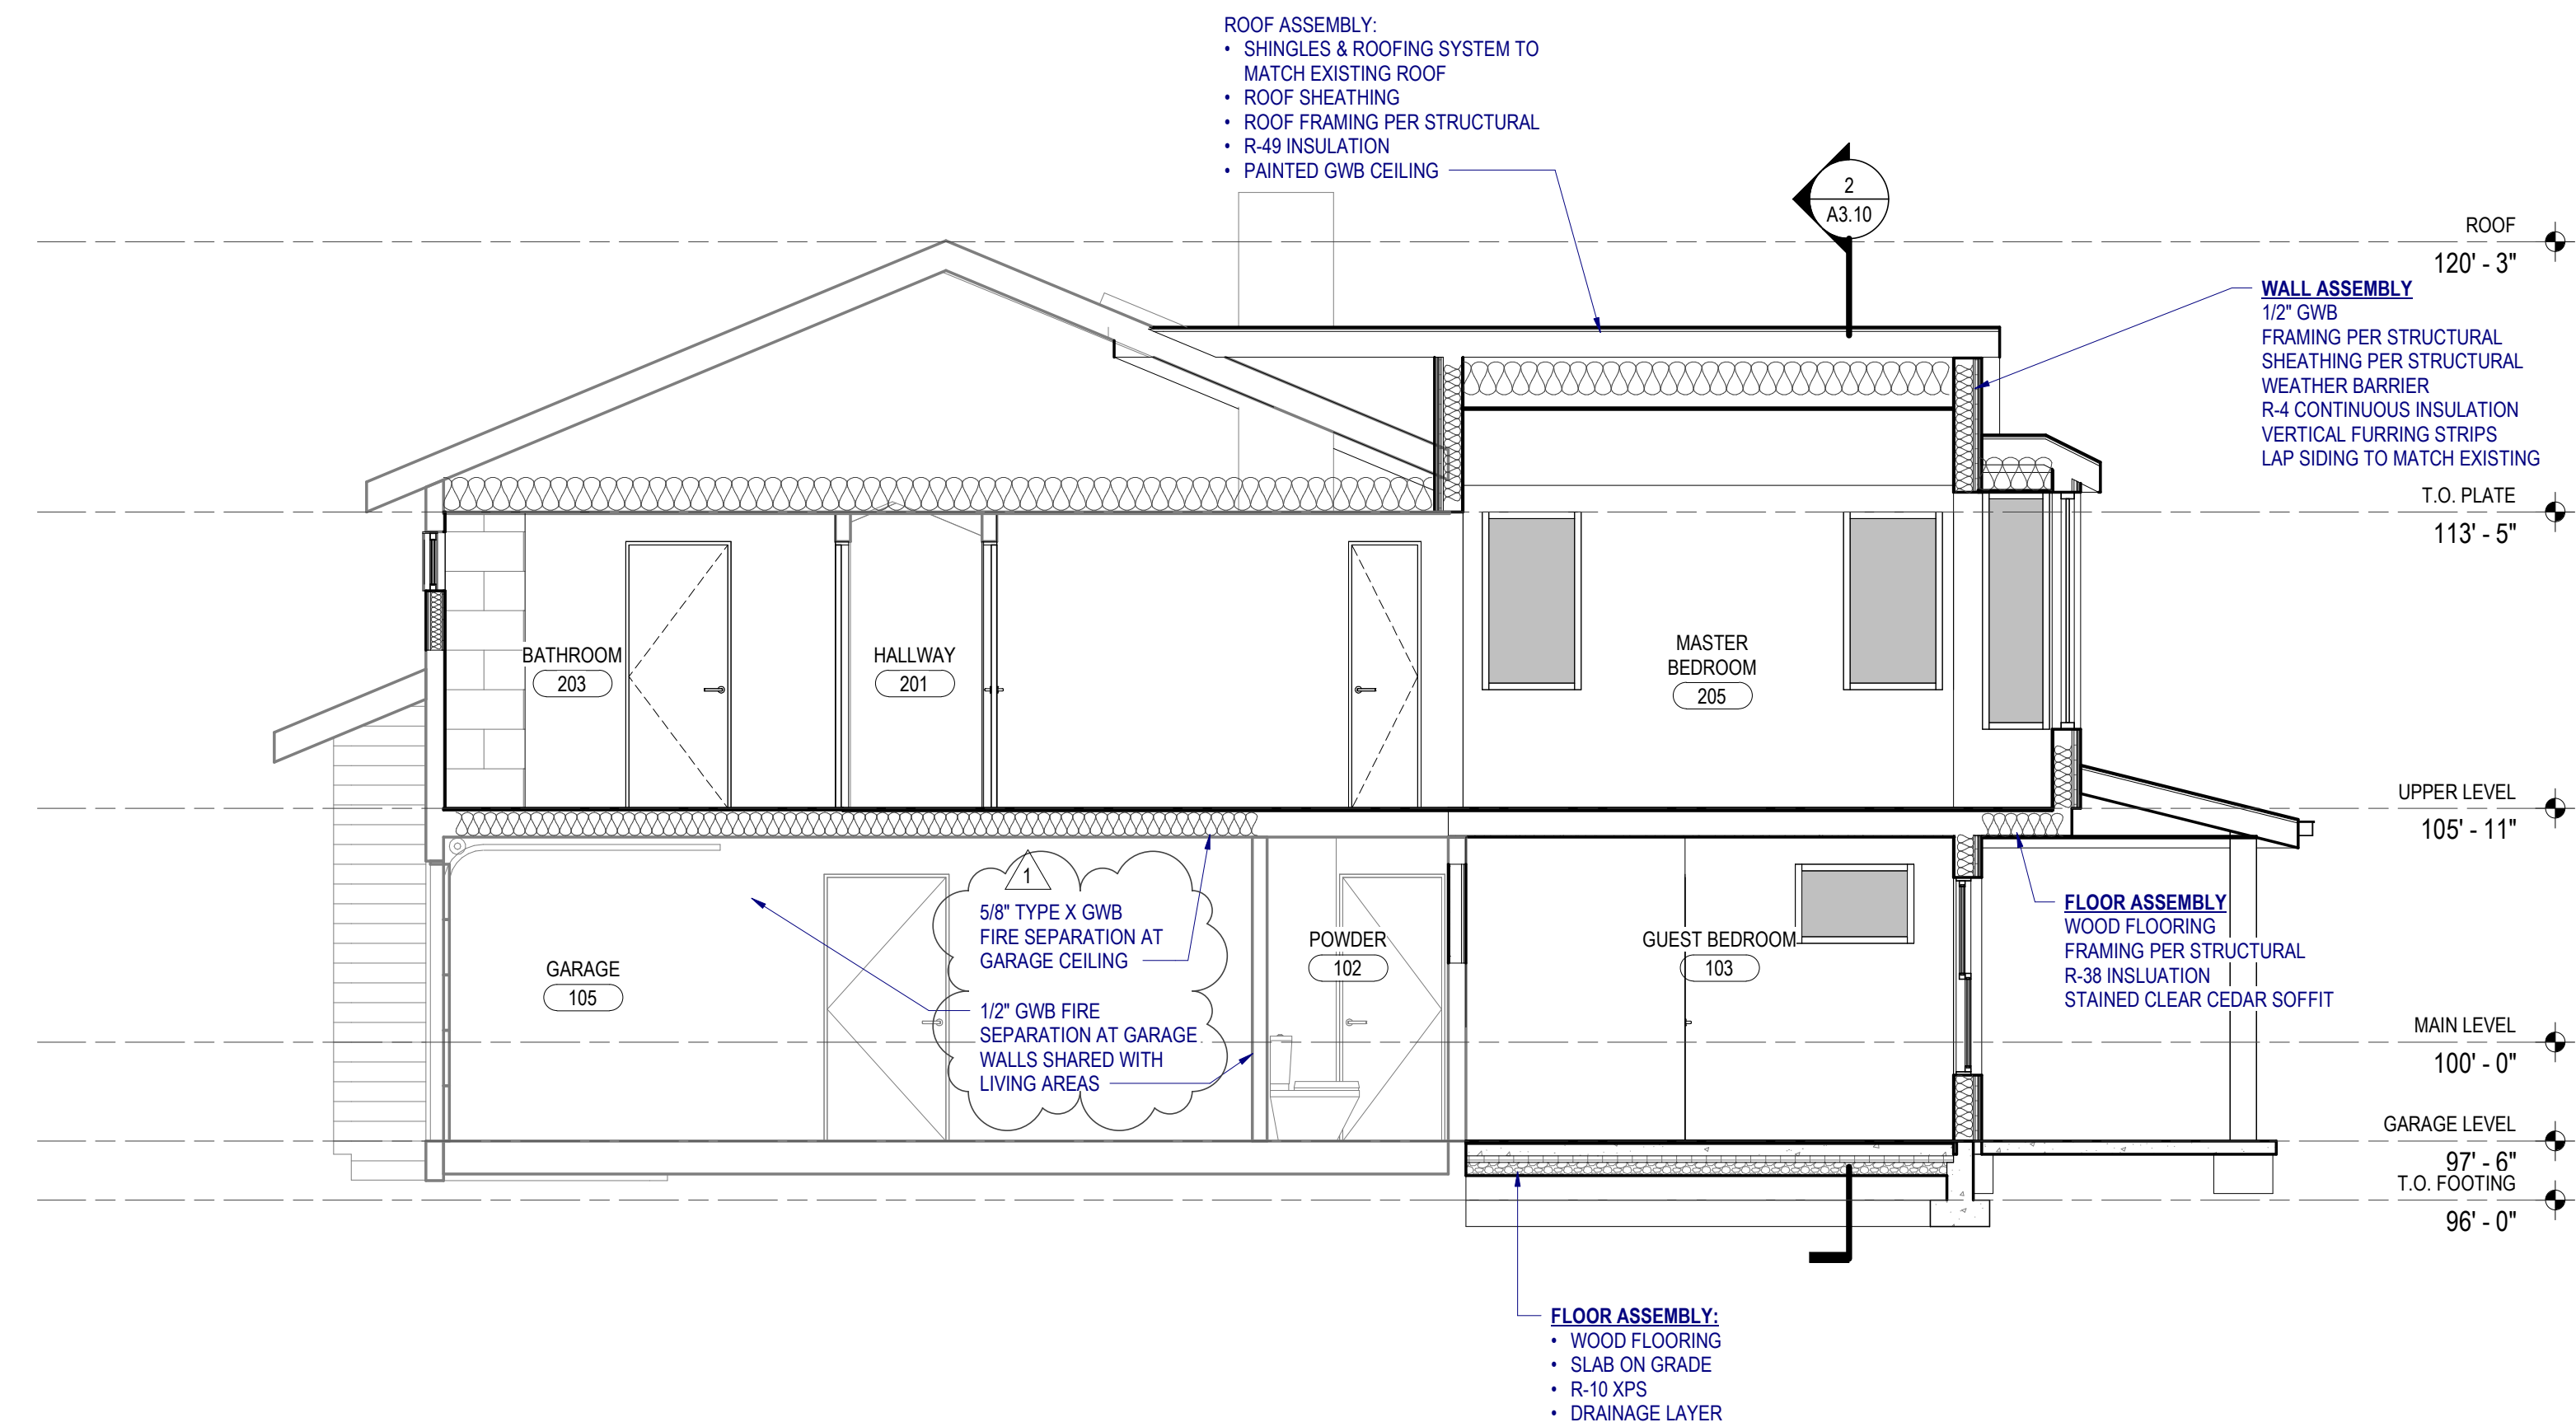
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2 Section 2
SCALE: 1/4" = 1'-0"




1 Section 1
SCALE: 1/4" = 1'-0"

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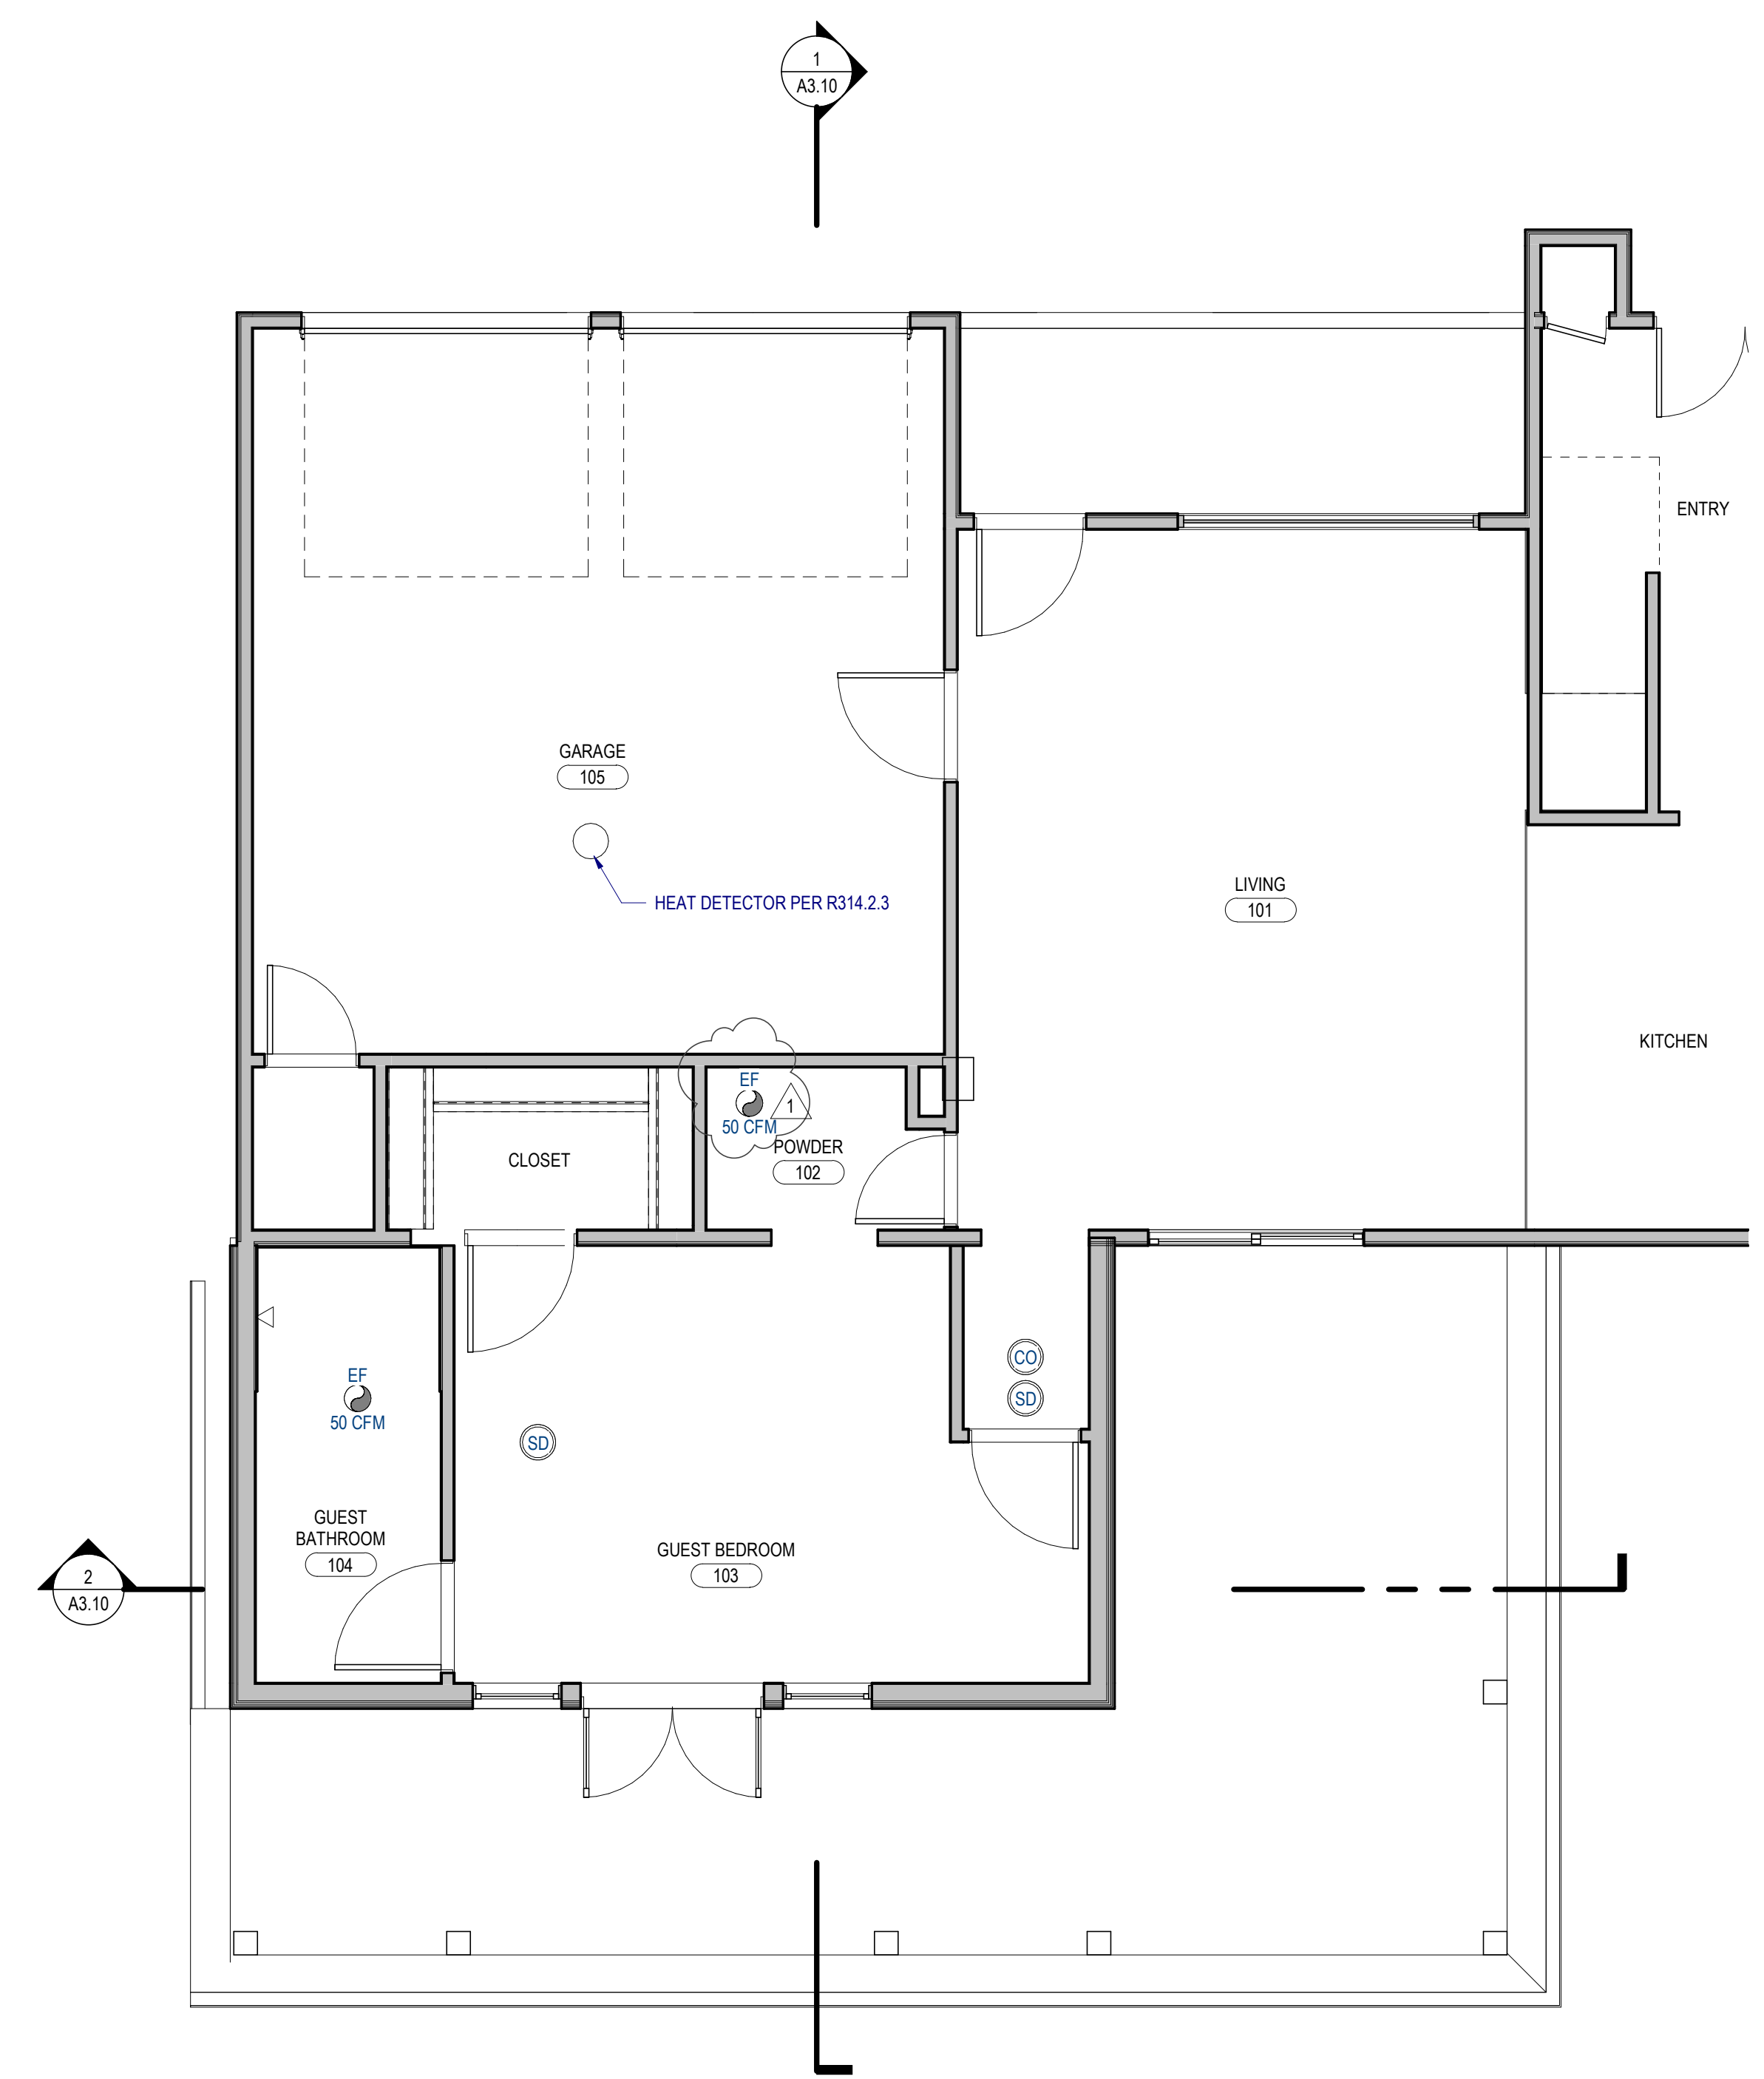
revisions:
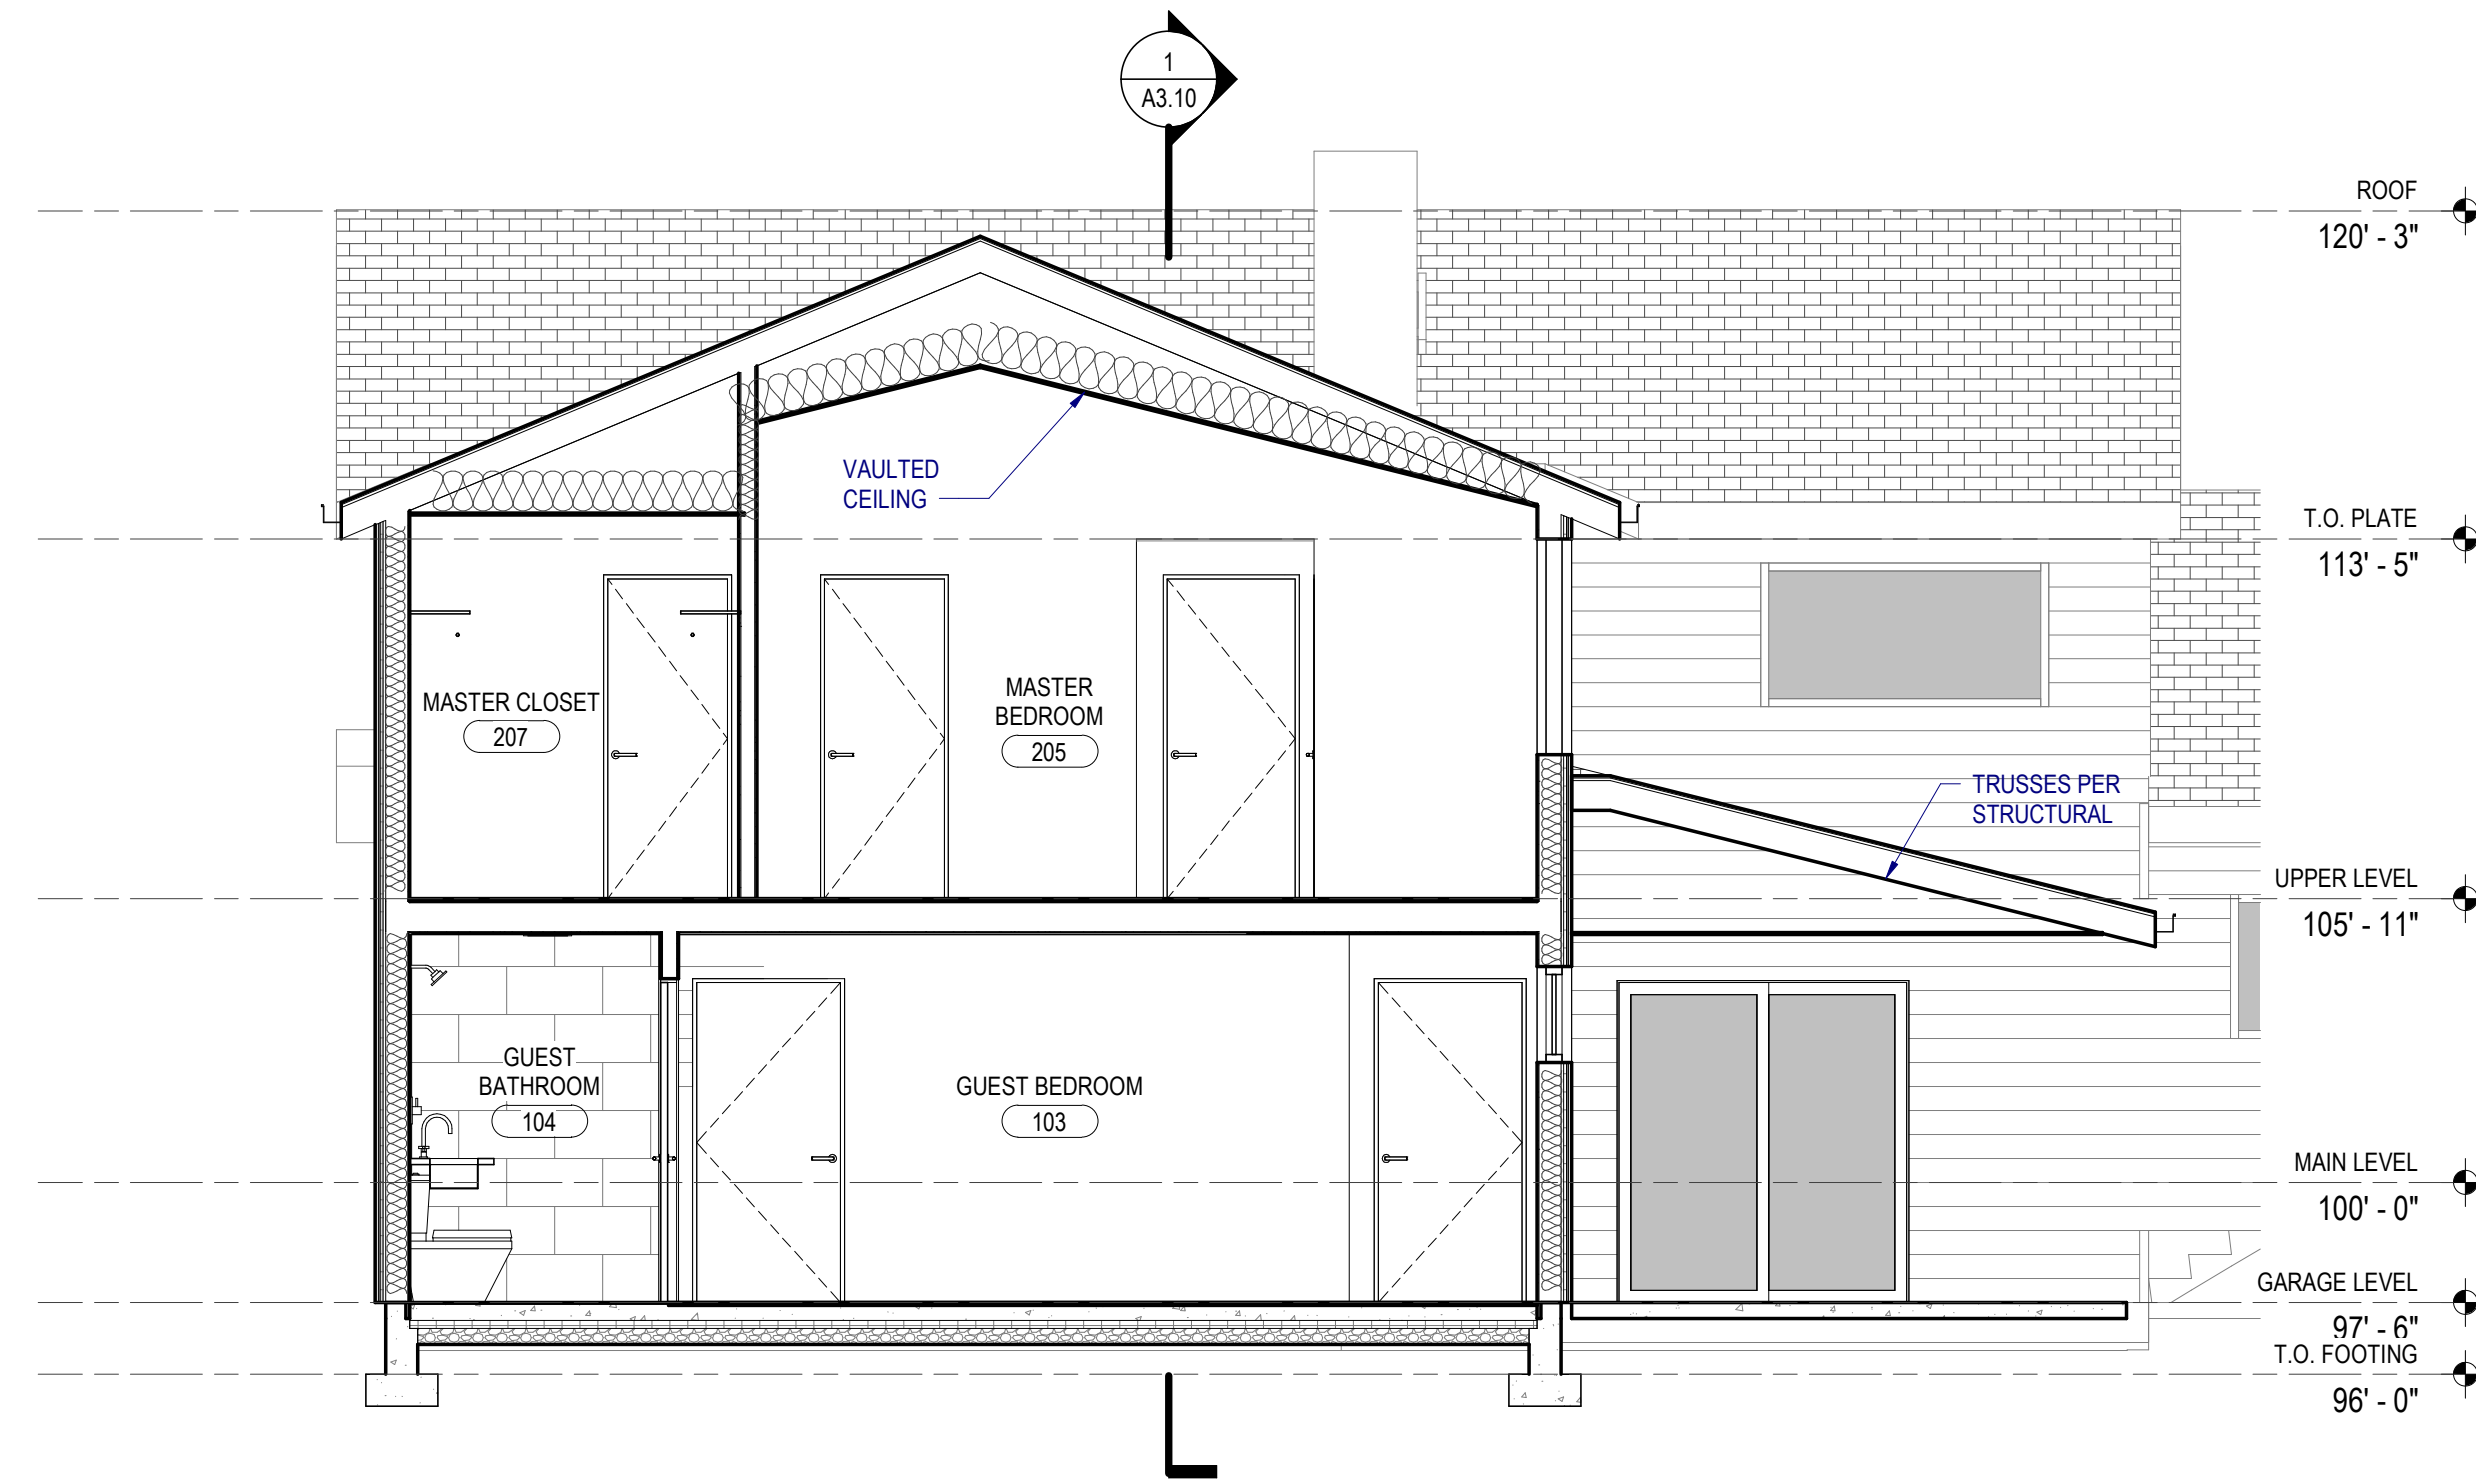
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02/13/2023



2 02 UPPER LEVEL RCP
SCALE: 1/4" = 1'-0"

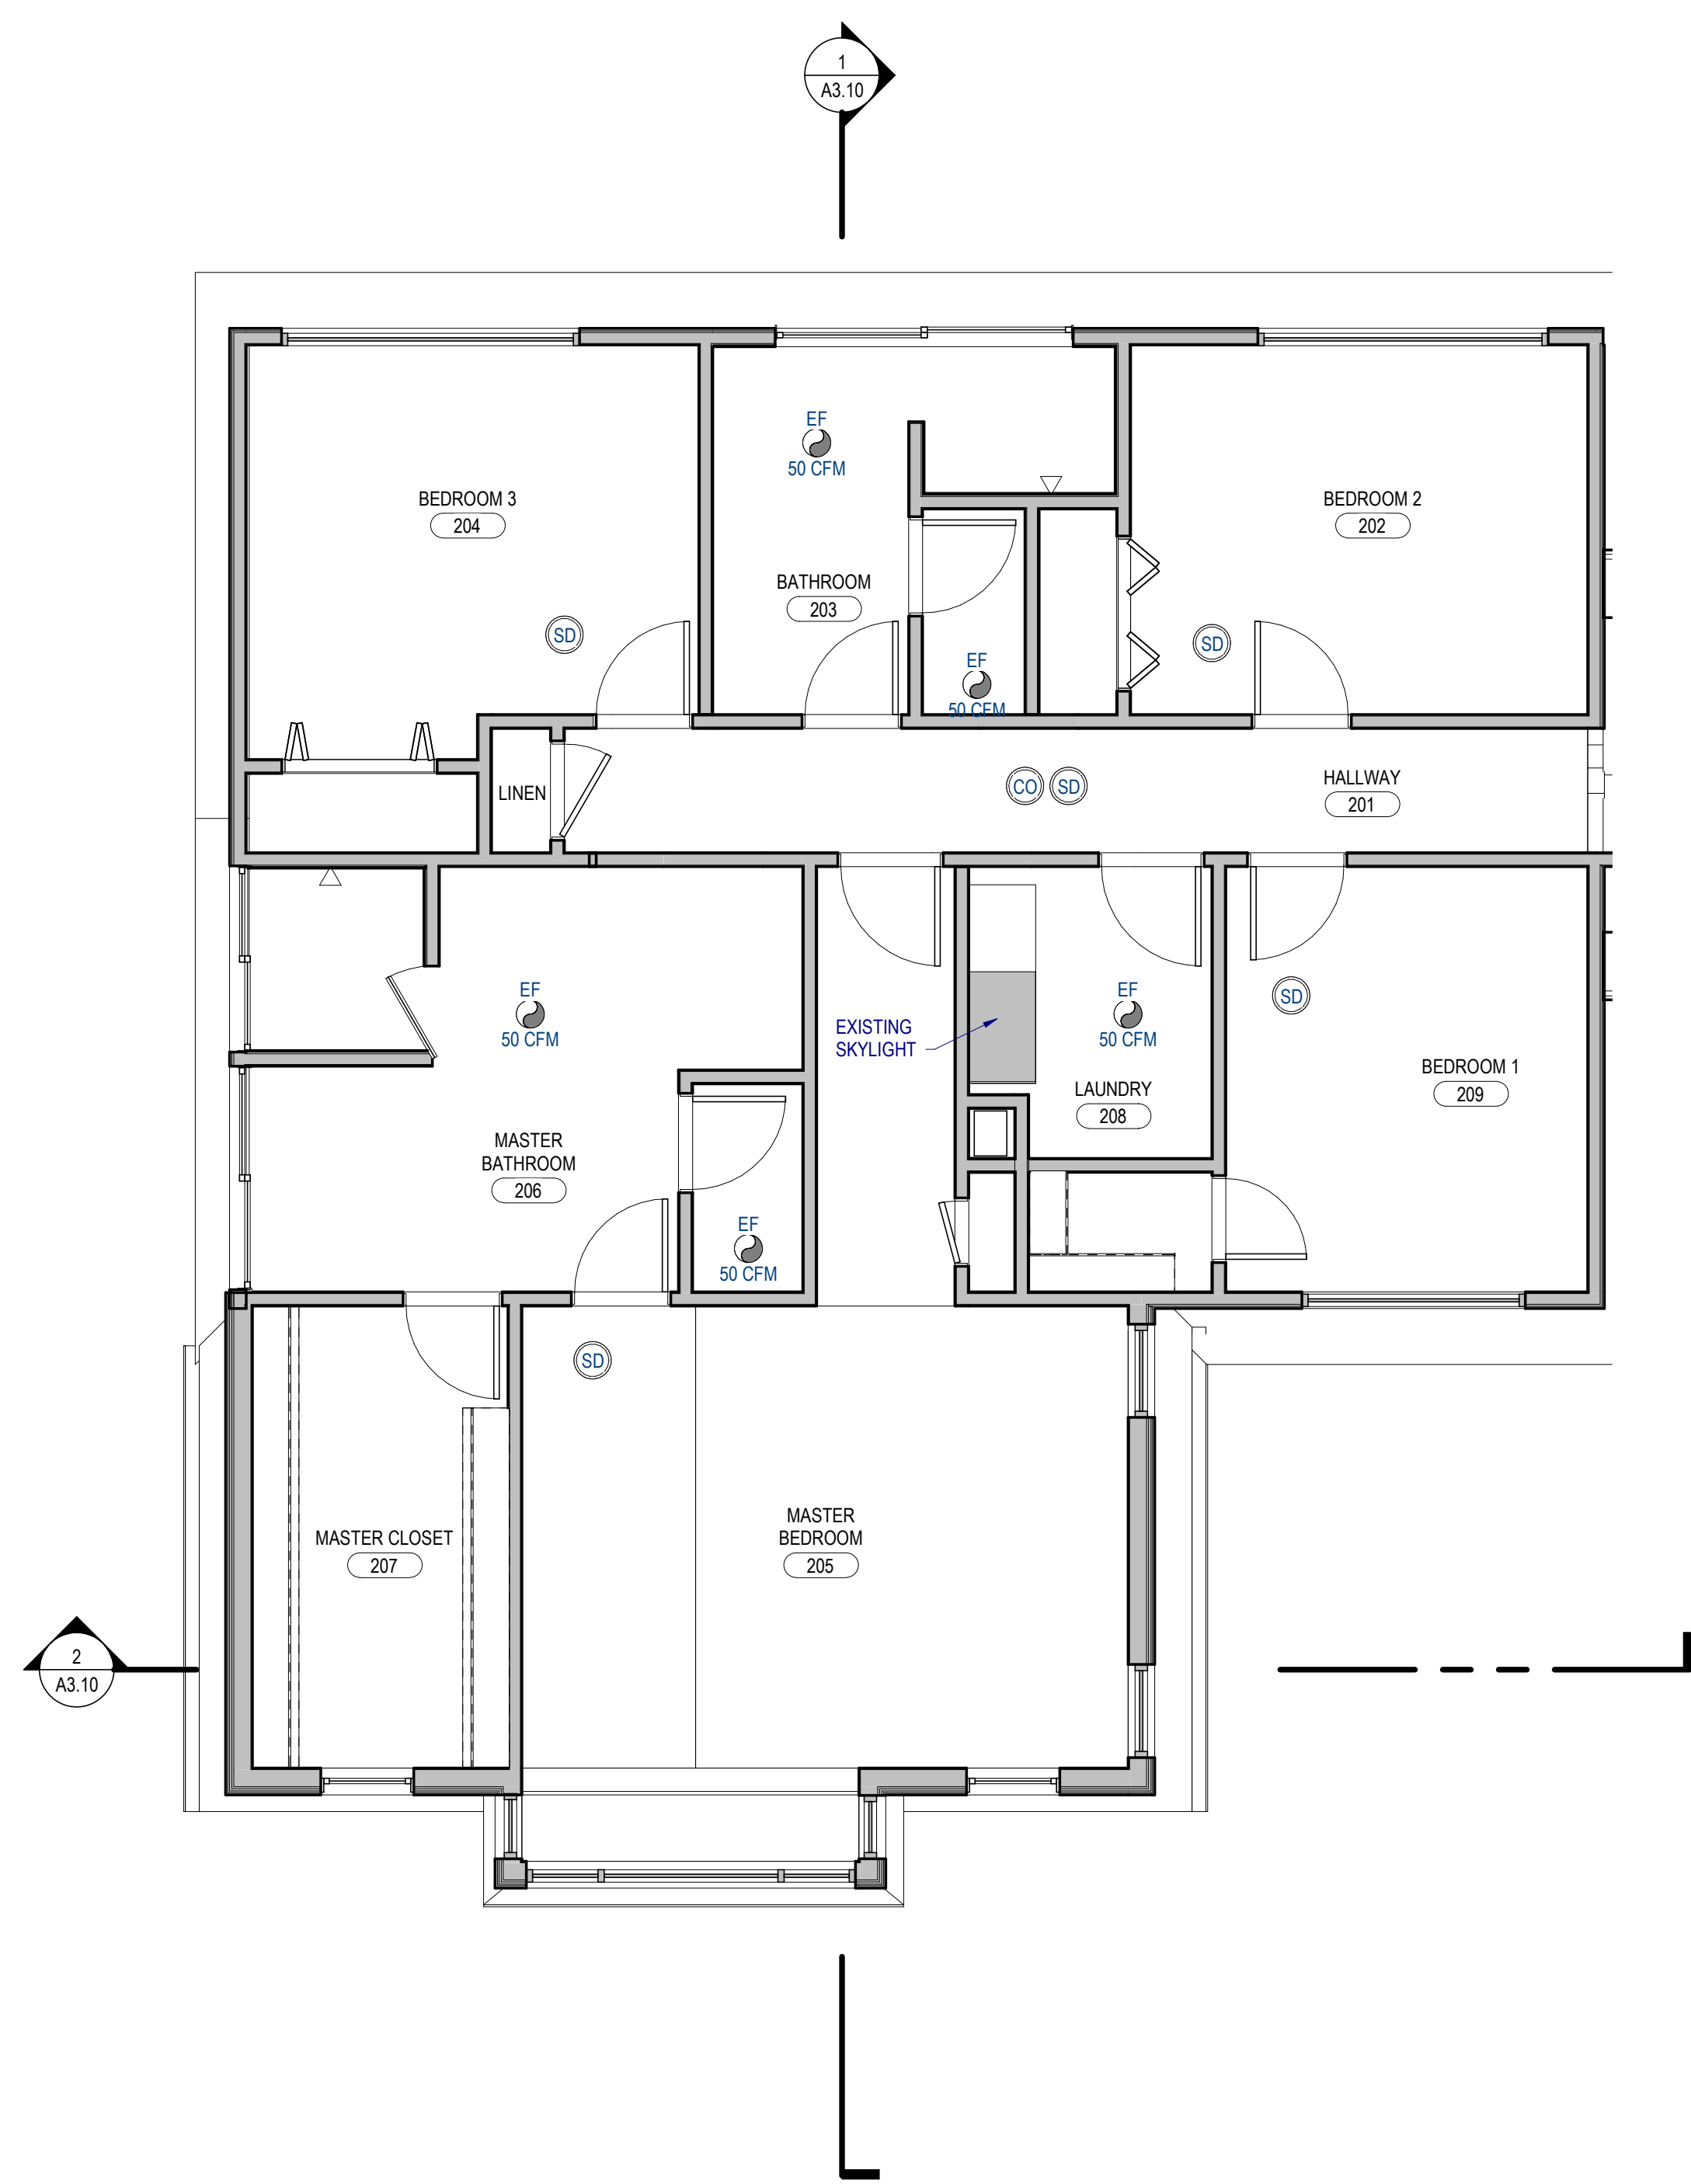

1 01 MAIN LEVEL RCP
SCALE: 1/4" = 1'-0"

GENERAL NOTE:
LIGHTING LAYOUT & ELECTRICAL PLAN TO
BE PROVIDED BY INTERIOR DESIGNER

principal architect _____
project manager _____
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checked by _____
job no. _____
date 02/13/2023


revisions:

1	5/12/23	CORRECTIONS 1	
no.	date		by

PERMIT SET
02/13/2023

REFLECTED CEILING
PLANS


A6.00

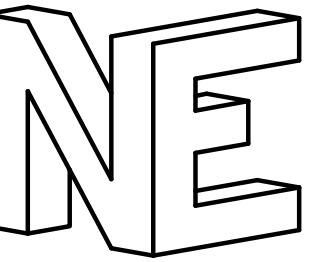


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2221 Everett Ave #202
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425.610.4425

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Stated drawing scale is based on 35" x 24" sheet.

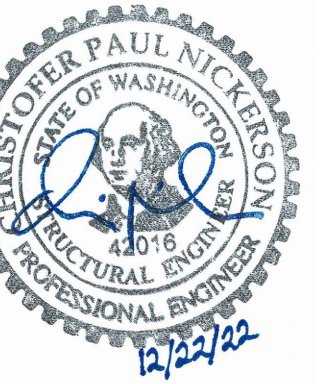


HELLING ADDITION
8925 SE 58TH ST
MERCER ISLAND, WA 98040

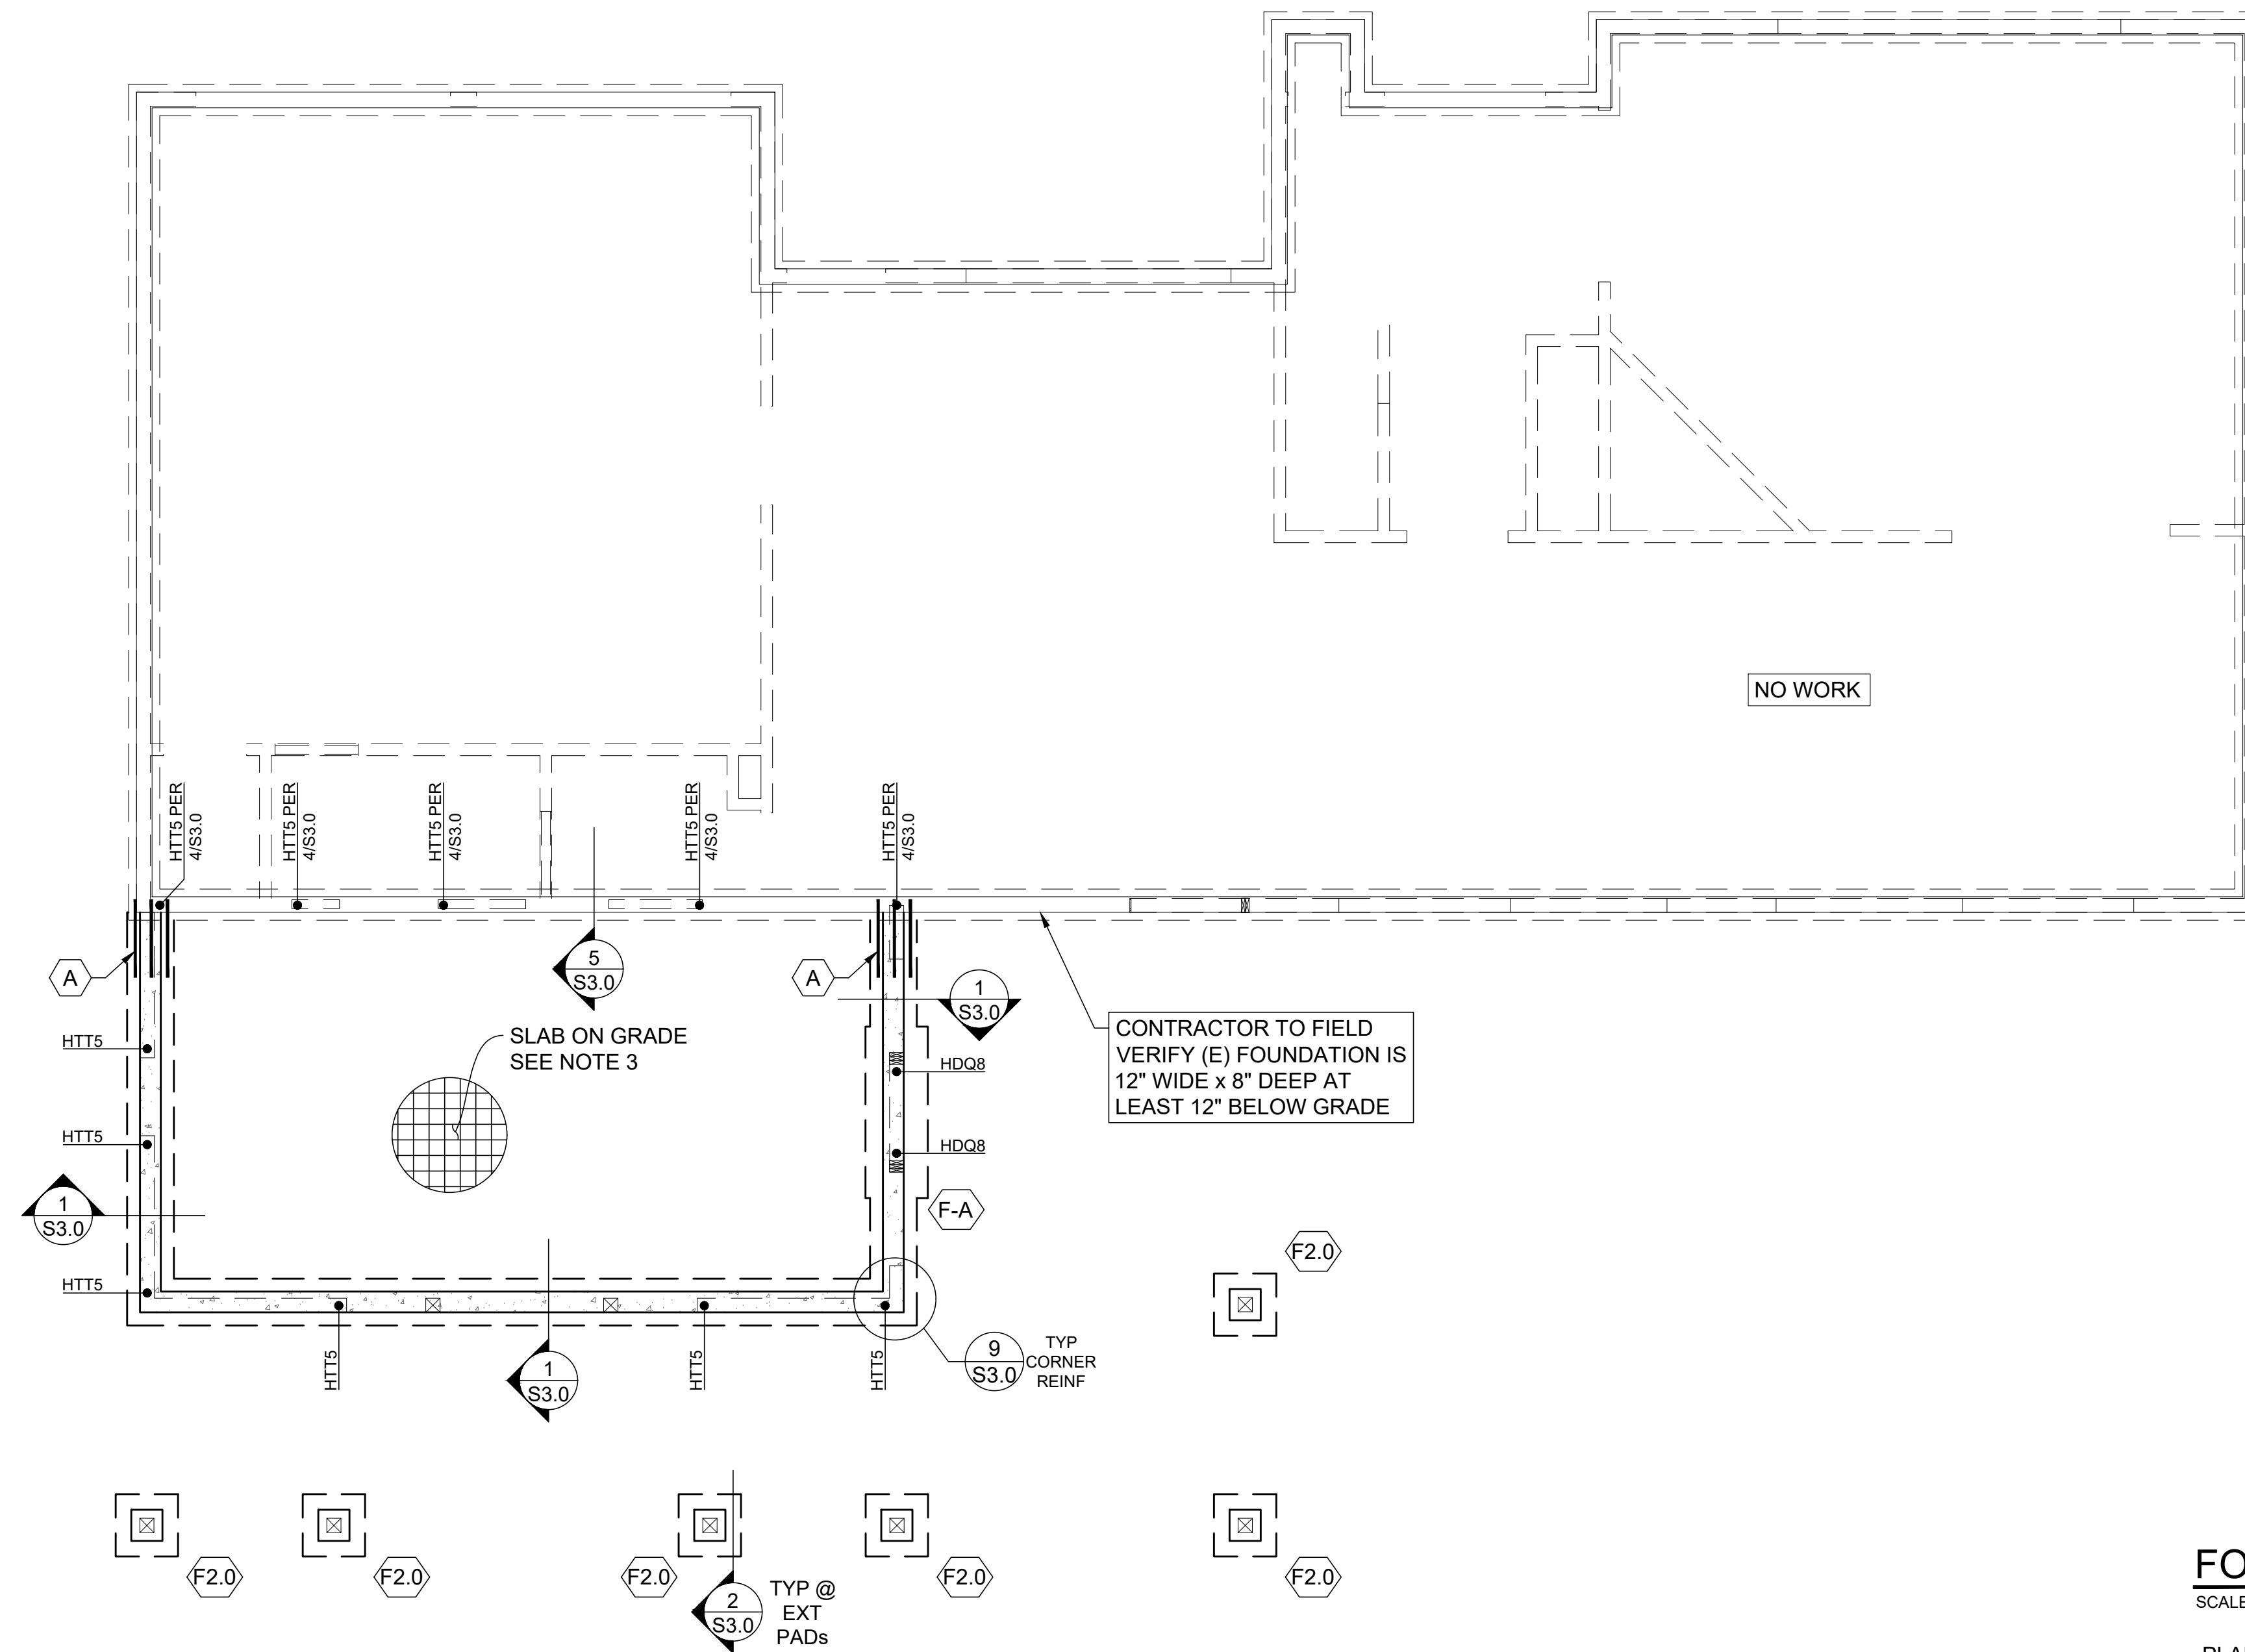

FOUNDATION PLAN

SCALE: 1/4" = 1'-0"

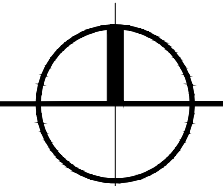

PLAN NOTES

- DO NOT SCALE DRAWINGS. REFER TO ARCH DWGS FOR ALL DIMENSIONS.
- THE BOTTOM OF ALL EXTERIOR FTGS SHALL BE 18" MINIMUM BELOW GRADE.
- 4" CONCRETE SLAB OVER 6 MIL VAPOR BARRIER ON 6" OF GRAVEL OR CRUSHED ROCK OVER FIRM UNDISTURBED SOIL OR ENGINEERED COMPACTED BACK-FILL.
- HTTXX INDICATES HOLD-DOWN @ END OF SHEAR WALL ABOVE. SEE DETAIL 3/S3.0 FOR INSTALLATION REQUIREMENTS.
- HDQ8 INDICATES HOLD-DOWN @ END OF SHEAR WALL ABOVE. SEE DETAIL 6/S3.0 FOR INSTALLATION REQUIREMENTS.
- F# INDICATES FOOTING MARK. SEE FOOTING SCHEDULE FOR SIZE & REINFORCING.
- REFER TO GENERAL STRUCTURAL NOTES FOR ADDITIONAL REQUIREMENTS.

HATCH LEGEND	
	NEW CONCRETE WALLS BELOW

FOOTING SCHEDULE		
MARK	SIZE	REINFORCEMENT
F2.0	2'-0" x 2'-0" x 8" DP	(2)#4 EW 3" FROM BOT
F-A	2'-0" x 5'-6" x 12" DP	#4 @ 12" O.C. EW TOP & BOT

KEY NOTE LEGEND	
	PROVIDE #4x2'-6" DOWELS EMBEDDED 5" MIN INTO EXISTING CONCRETE TO MATCH NEW HORIZ WALL & FTG REINF QTY AND SPACES, EPOXY W/ AT-XP HIGH STRENGTH EPOXY AS MANUF. BY SIMPSON

No.	Date	Issue
0	12.22.22	Building Permit


Sheet Contents
FOUNDATION PLAN

Job No. 22-053

Sheet No.

S2.0




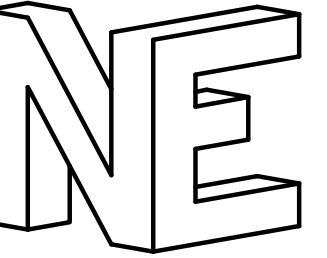


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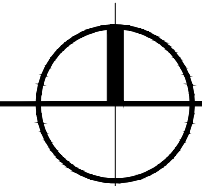


HELLING ADDITION
8925 SE 58TH ST
MERCER ISLAND, WA 98040

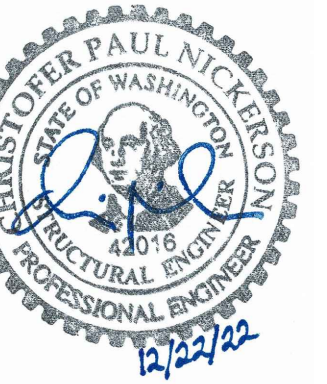

UPPER FLOOR & LOW ROOF FRAMING PLAN

SCALE: 1/4" = 1'-0"

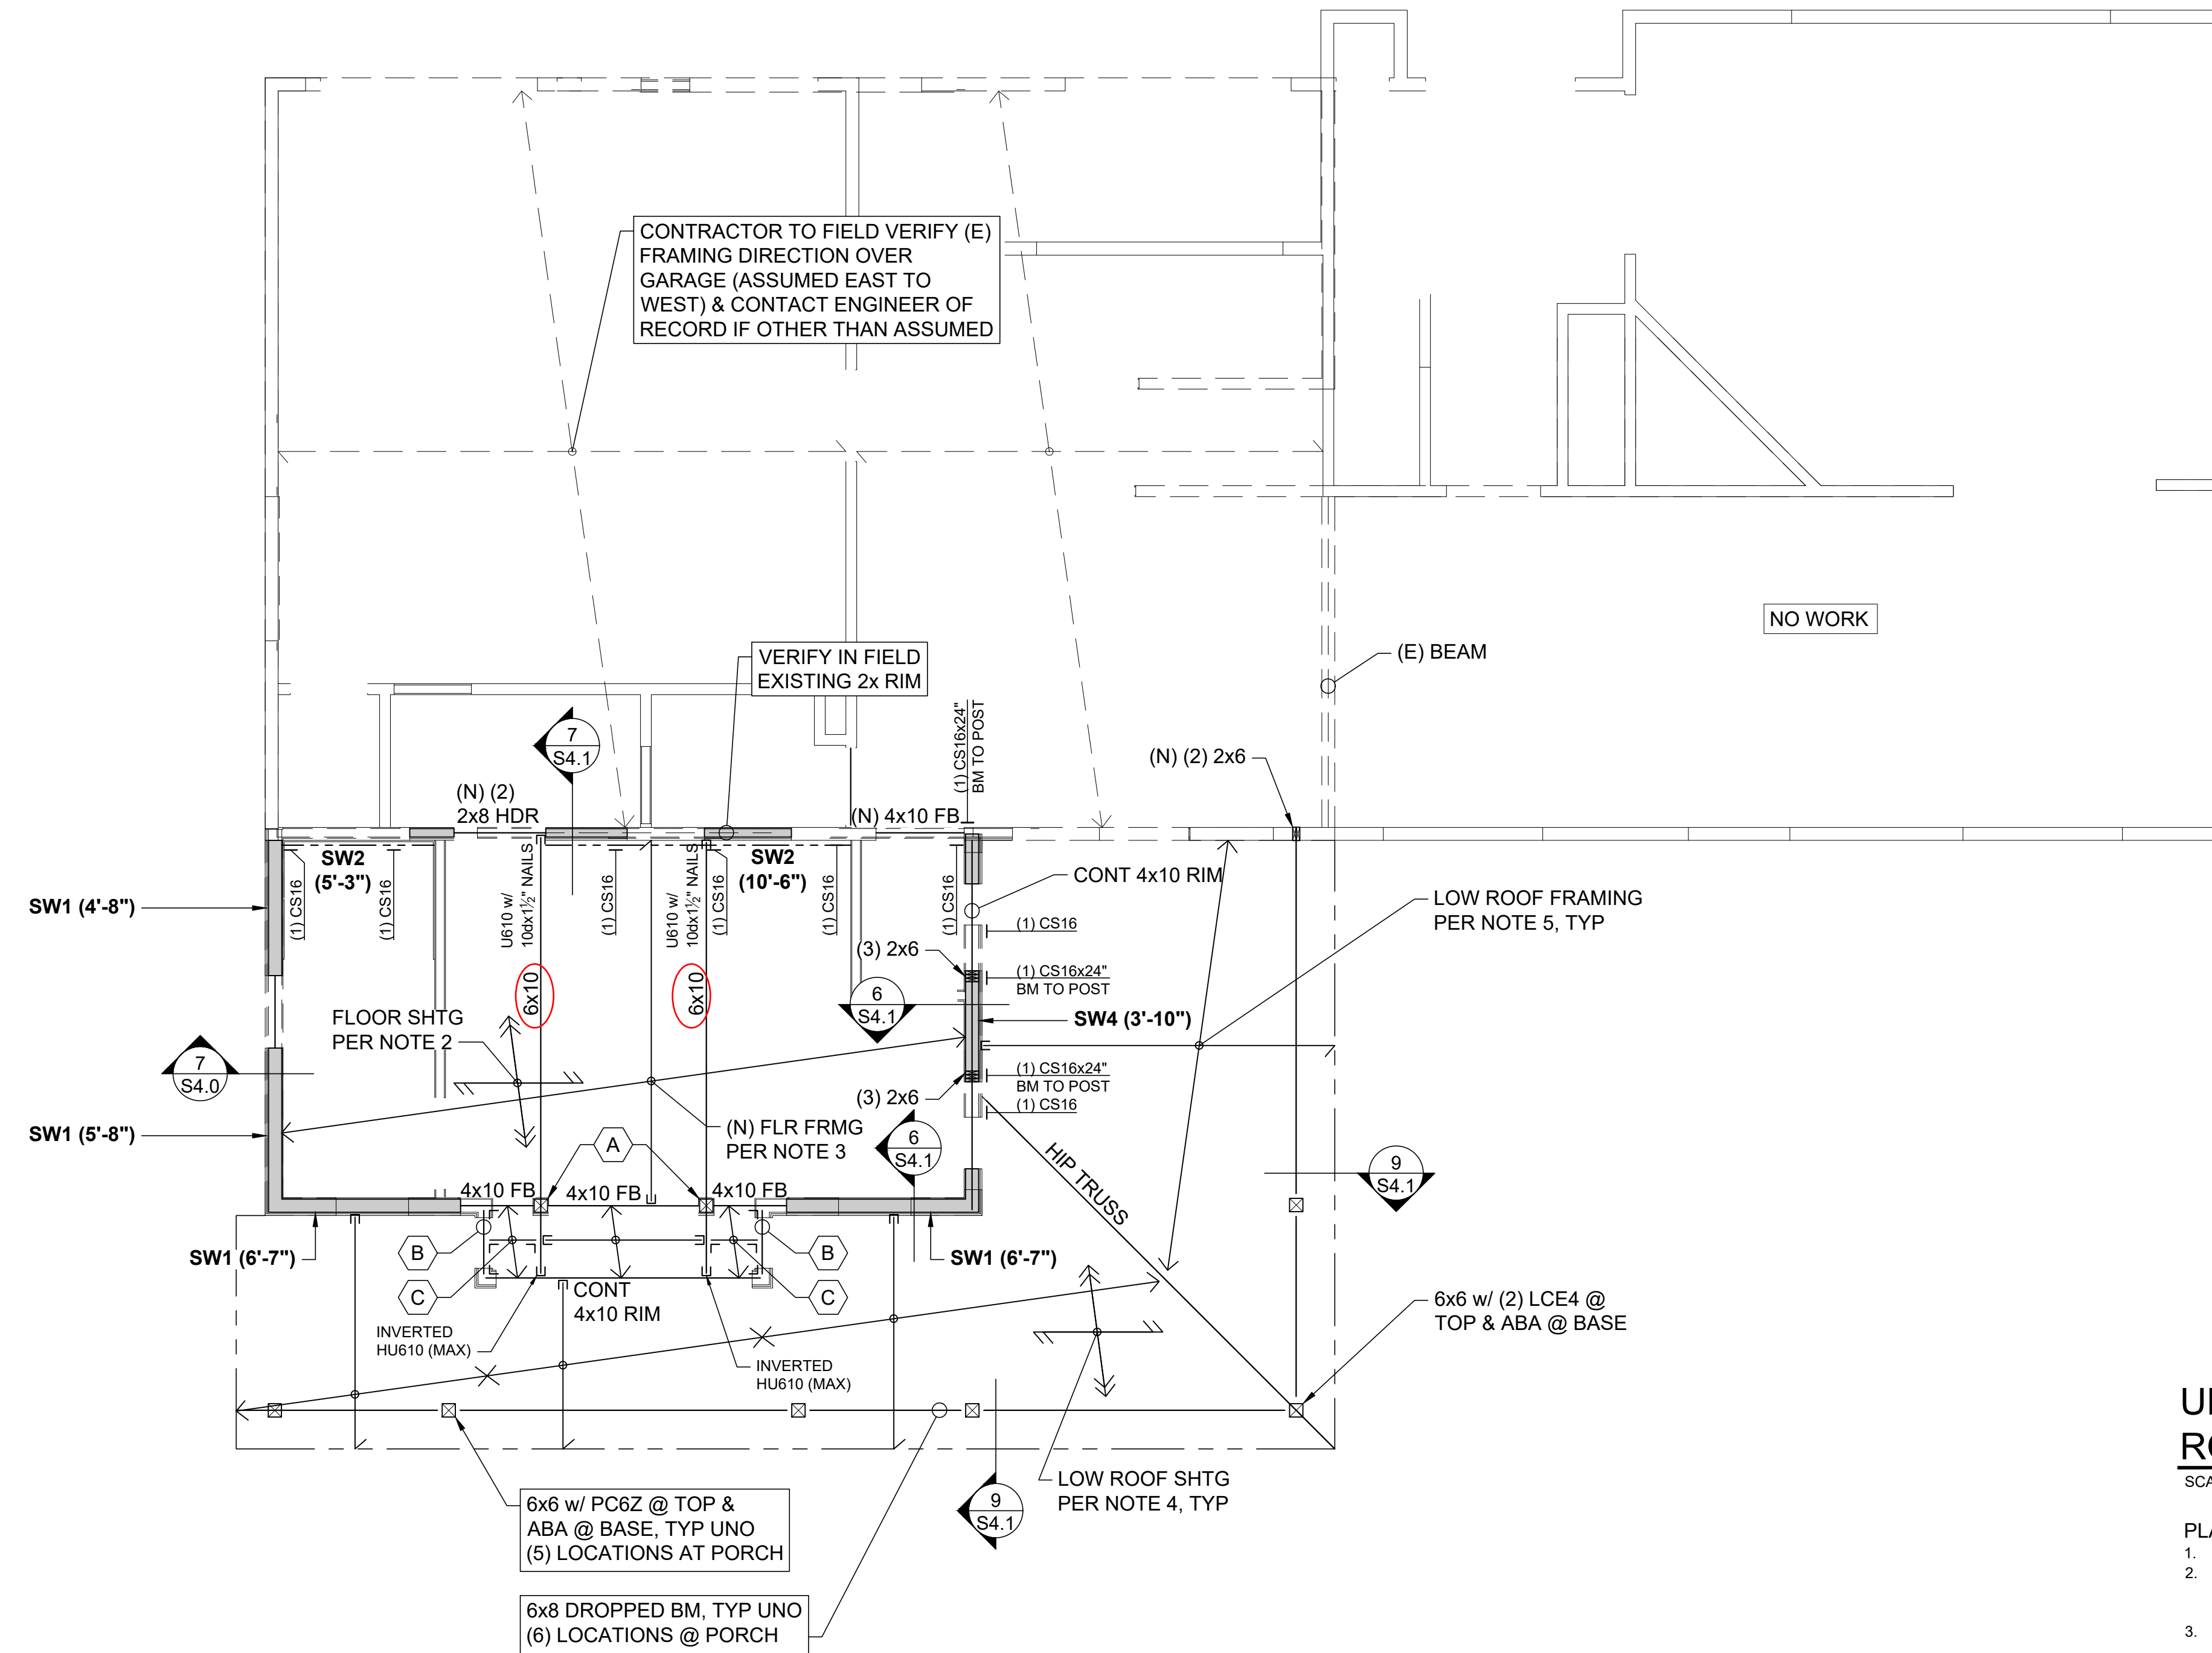

PLAN NOTES

- DO NOT SCALE DRAWINGS. REFER TO ARCH DWGS FOR ALL DIMENSIONS.
- FLOOR SHEATHING SHALL BE 3/4" TONGUE AND GROOVE A.P.A. RATED PANELS (EXPOSURE 1, SPAN RATING 48/24). GLUE AND NAIL @ ALL FRAMED PANEL EDGES WITH 8d @ 6"OC AND TO ALL INTERMEDIATE FRAMING @ 12"OC.
- FLOOR JOISTS SHALL BE 2x10 @ 16"OC TYPICAL JOIST HANGERS TO BE SIMPSON LUS OR JB, UNO.
- LOW ROOF SHEATHING SHALL BE 1/2" A.P.A. RATED PANELS (EXPOSURE 1, SPAN RATING 32/16), FACE GRAIN PERPENDICULAR TO SUPPORTS OVER ROOF FRAMING PER PLAN. NAIL SHEATHING @ ALL FRAMED PANEL EDGES WITH 8d @ 6"OC AND TO ALL INTERMEDIATE FRAMING @ 12"OC.
- LOW ROOF FRAMING SHALL BE PREFABRICATED JACK ROOF TRUSSES @ 24"OC. TRUSS DESIGN TO BE PROVIDED BY OTHERS. SEE STRUCTURAL NOTES FOR DESIGN REQUIREMENTS.
- NEW HEADERS OVER DOOR AND WINDOW OPENINGS SHALL BE (2) 2x8 MINIMUM. PROVIDE (2) TRIMMER STUDS MIN @ EA END OF ALL HEADERS U.N.O. SEE DETAIL 4/S4.0 FOR TYPICAL INSTALLATION.
- PROVIDE (2) STUDS MINIMUM @ EACH END OF ALL NEW BEAMS U.N.O. ON PLANS. BEAR BEAM FULLY ON BUILT UP COLUMN & PROVIDE POSITIVE CONNECTION BY EITHER A35 OR LTP4 CLIPS ON EA SIDE OF BEAM OR W/ AN AC, PC, OR LPC CAP.
- SW# (X"X") INDICATES NEW SHEAR WALL TYPE AND APPROXIMATE LENGTH. SEE 1/S4.0 FOR CONSTRUCTION REQUIREMENTS.
- ALL NEW EXTERIOR WALLS SHALL BE SW1, U.N.O. ON PLANS.
- TYPICAL NEW TOP PLATE CONSTRUCTION PER 3/S4.0.
- (X)CS16 INDICATES VERTICAL HOLD-DOWN STRAP @ END OF SHEAR WALL ABOVE. (X) INDICATES STRAP QTY. SEE DETAIL 8/S4.0 FOR INSTALLATION REQUIREMENTS.
- REFER TO GENERAL STRUCTURAL NOTES FOR ADDITIONAL REQUIREMENTS.

HATCH LEGEND	
	NEW STRUCTURAL WALLS BELOW

KEY NOTE LEGEND	
(A)	6x6 w/ CCTQ
(B)	(2) 2x10 RIM w/ A35 EACH END
(C)	2x10 @ 16"O.C. w/ A35 EACH END




No.	Date	Issue
0	12.22.22	Building Permit

Sheet Contents
UPPER FLOOR & LOW ROOF FRAMING PLAN

Job No. 22-053


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S2.1

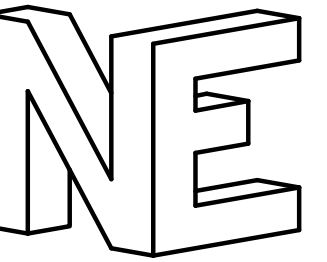


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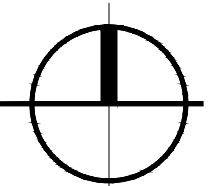


HELLING ADDITION
8925 SE 68TH ST
MERCER ISLAND, WA 98040

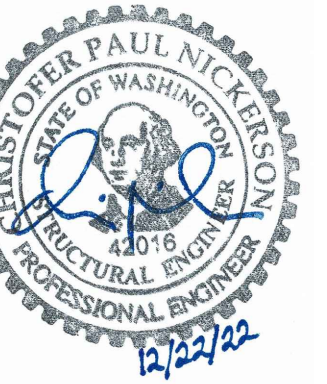

ROOF FRAMING PLAN

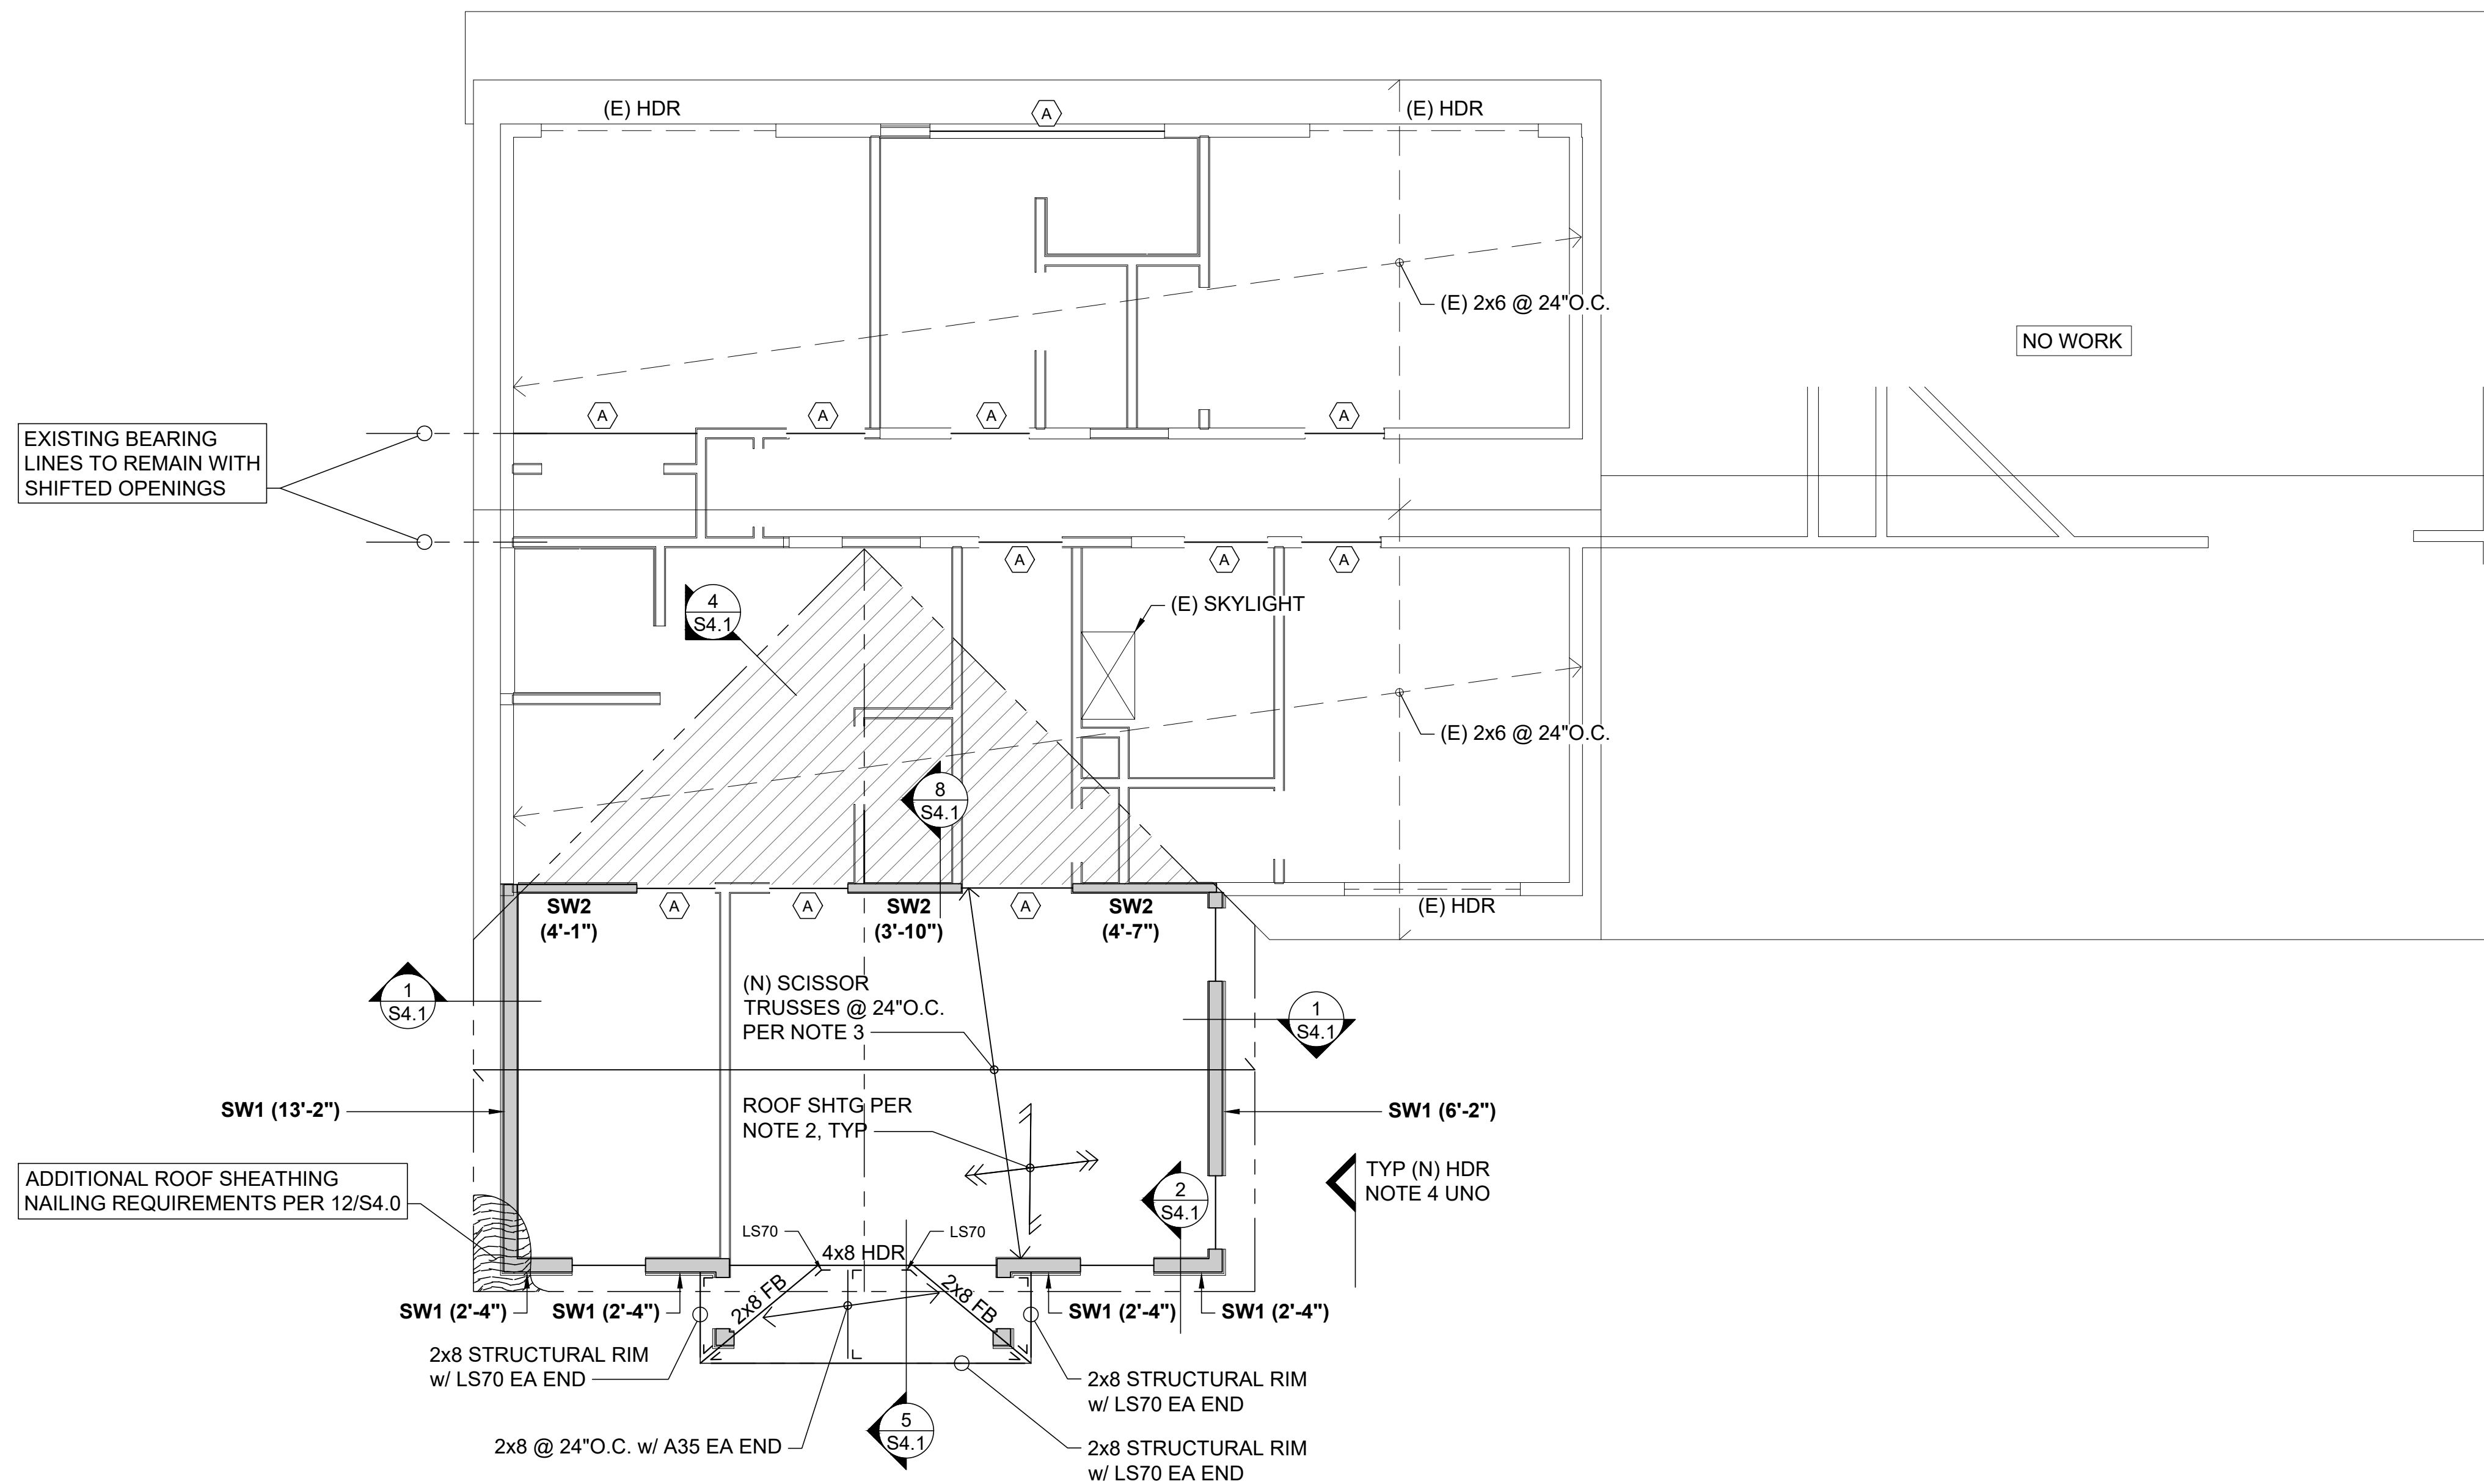SCALE: 1/4" = 1'-0"



PLAN NOTES

- DO NOT SCALE DRAWINGS. REFER TO ARCH DWGS FOR ALL DIMENSIONS.
- NEW ROOF SHEATHING SHALL BE 1/2" A.P.A. RATED PANELS (EXPOSURE 1, SPAN RATING 32/16), FACE GRAIN PERPENDICULAR TO SUPPORTS OVER ROOF FRAMING PER PLAN. NAIL SHEATHING @ ALL FRAMED PANEL EDGES WITH 8d @ 6" OC AND TO ALL INTERMEDIATE FRAMING @ 12" OC.
- NEW ROOF FRAMING SHALL BE PREFABRICATED ROOF SCISSOR TRUSSES @ 24" OC. TRUSS DESIGN TO BE PROVIDED BY OTHERS. SEE STRUCTURAL NOTES FOR DESIGN REQUIREMENTS.
- NEW HEADERS OVER DOOR AND WINDOW OPENINGS SHALL BE (2) 2x8 MINIMUM. PROVIDE (2) TRIMMER STUDS MIN @ EA END OF ALL HEADERS U.N.O. SEE DETAIL 4/S4.0 FOR TYPICAL INSTALLATION.
- PROVIDE (2) STUDS MINIMUM @ EACH END OF NEW ALL BEAMS U.N.O. ON PLANS. BEAR BEAM FULLY ON BUILT UP COLUMN & PROVIDE POSITIVE CONNECTION BY EITHER A35 OR LTP4 CLIPS ON EA SIDE OF BEAM OR W/ AN AC, PC, OR LPC CAP.
- SW# (X'-X") INDICATES NEW SHEAR WALL TYPE AND APPROXIMATE LENGTH. SEE 1/S4.0 FOR CONSTRUCTION REQUIREMENTS.
- ALL NEW EXTERIOR WALLS SHALL BE SW1, U.N.O. ON PLANS.
- TYPICAL NEW TOP PLATE CONSTRUCTION PER 3/S4.0.
- OVERFRAMING TYP TO BE 2x6'S @ 24" OC W/ VERT SUPPORT TO TRUSSES BELOW @ NO MORE THAN 48" OC.
- REFER TO GENERAL STRUCTURAL NOTES FOR ADDITIONAL REQUIREMENTS.

HATCH LEGEND	
	NEW STRUCTURAL WALLS BELOW
	OVERFRAMING PER NOTE 9

KEY NOTE LEGEND	
	NEW (2) 2x8 HEADER

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Sheet Contents


ROOF FRAMING PLAN

Job No. 22-053


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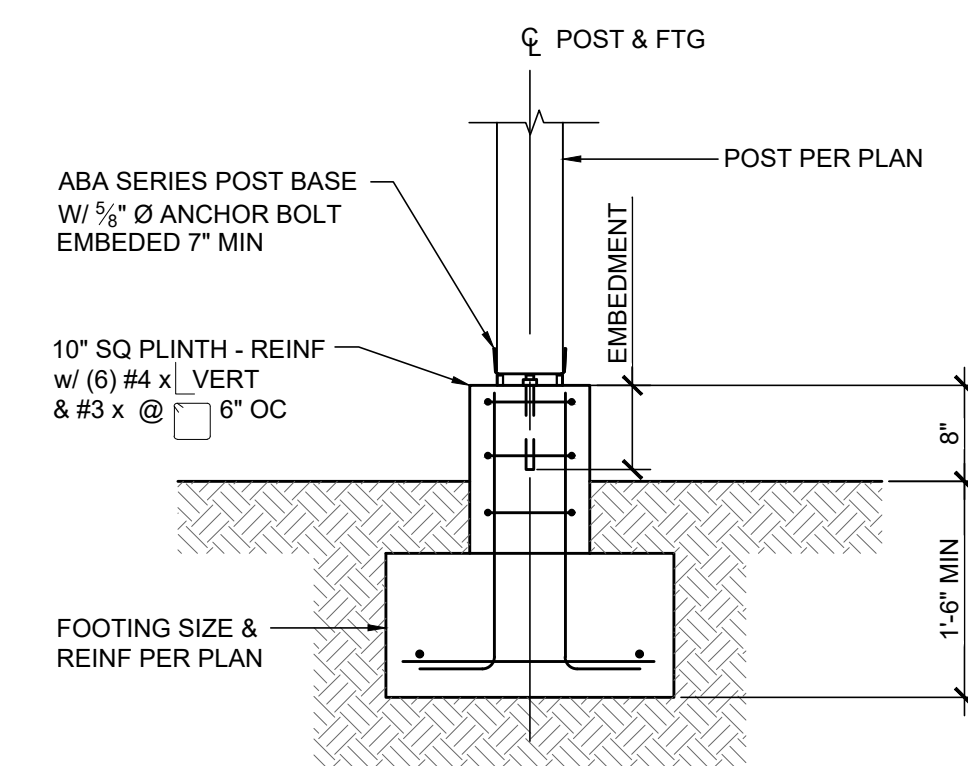





HTT RETROFIT HOLDOWN ANCHOR 4
SCALE: 3/4" = 1'-0" S3.0

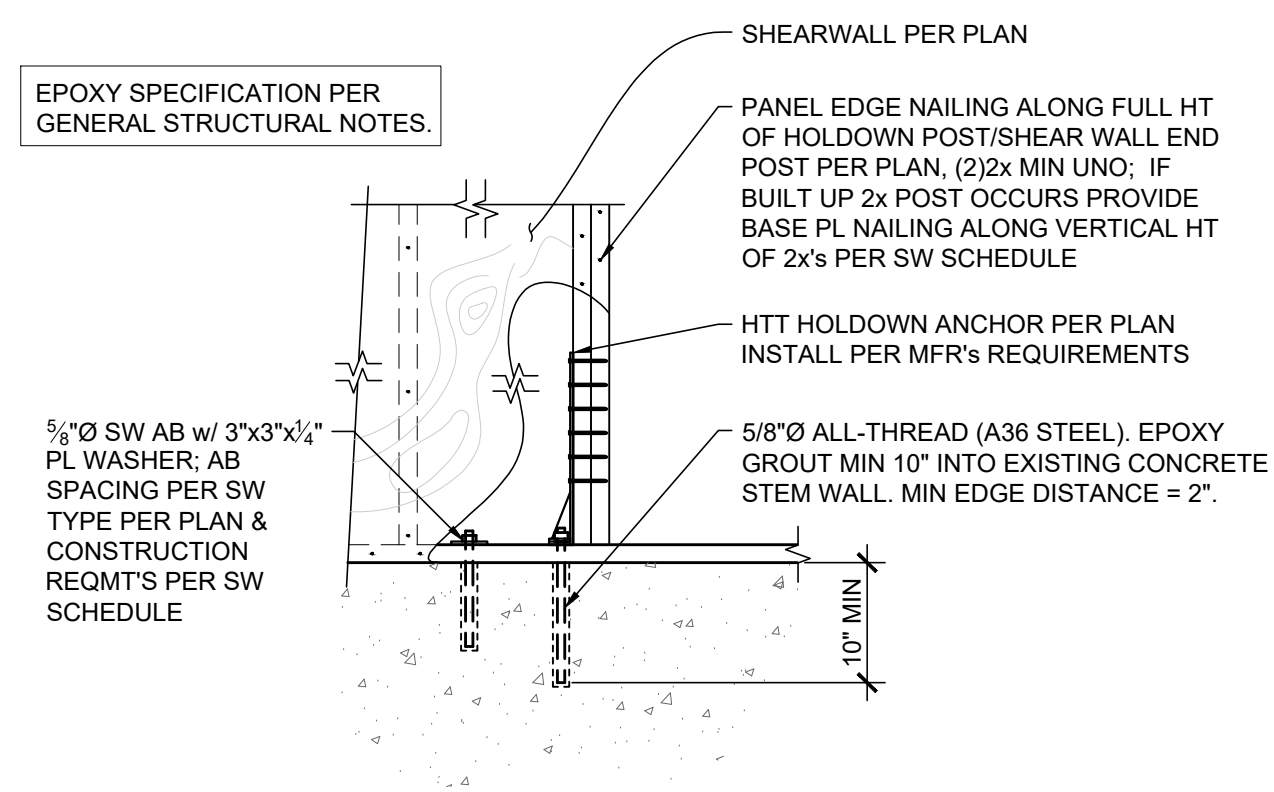


TYPICAL HTT HOLDOWN ANCHOR 3
SCALE: 3/4" = 1'-0" S3.0

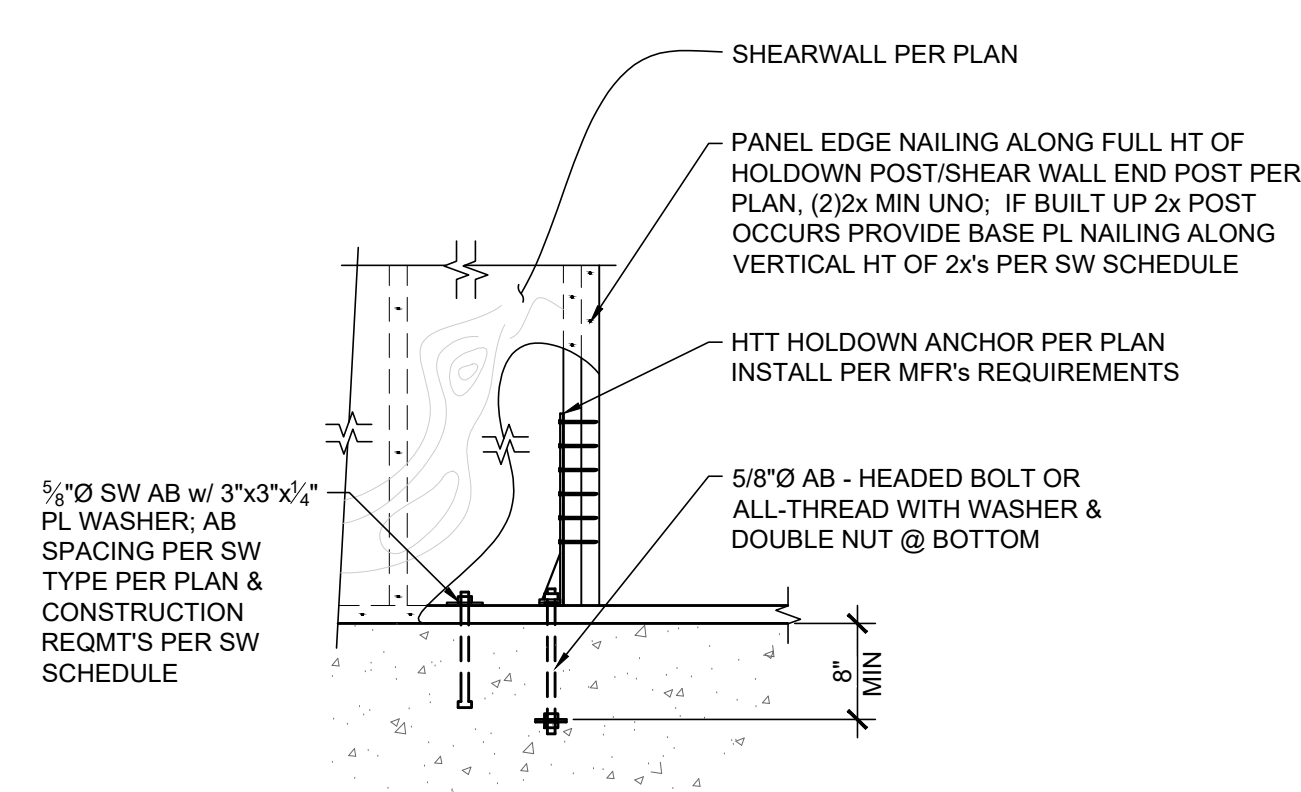


EXTERIOR POST FOOTING 2
SCALE: 3/4" = 1'-0" S3.0

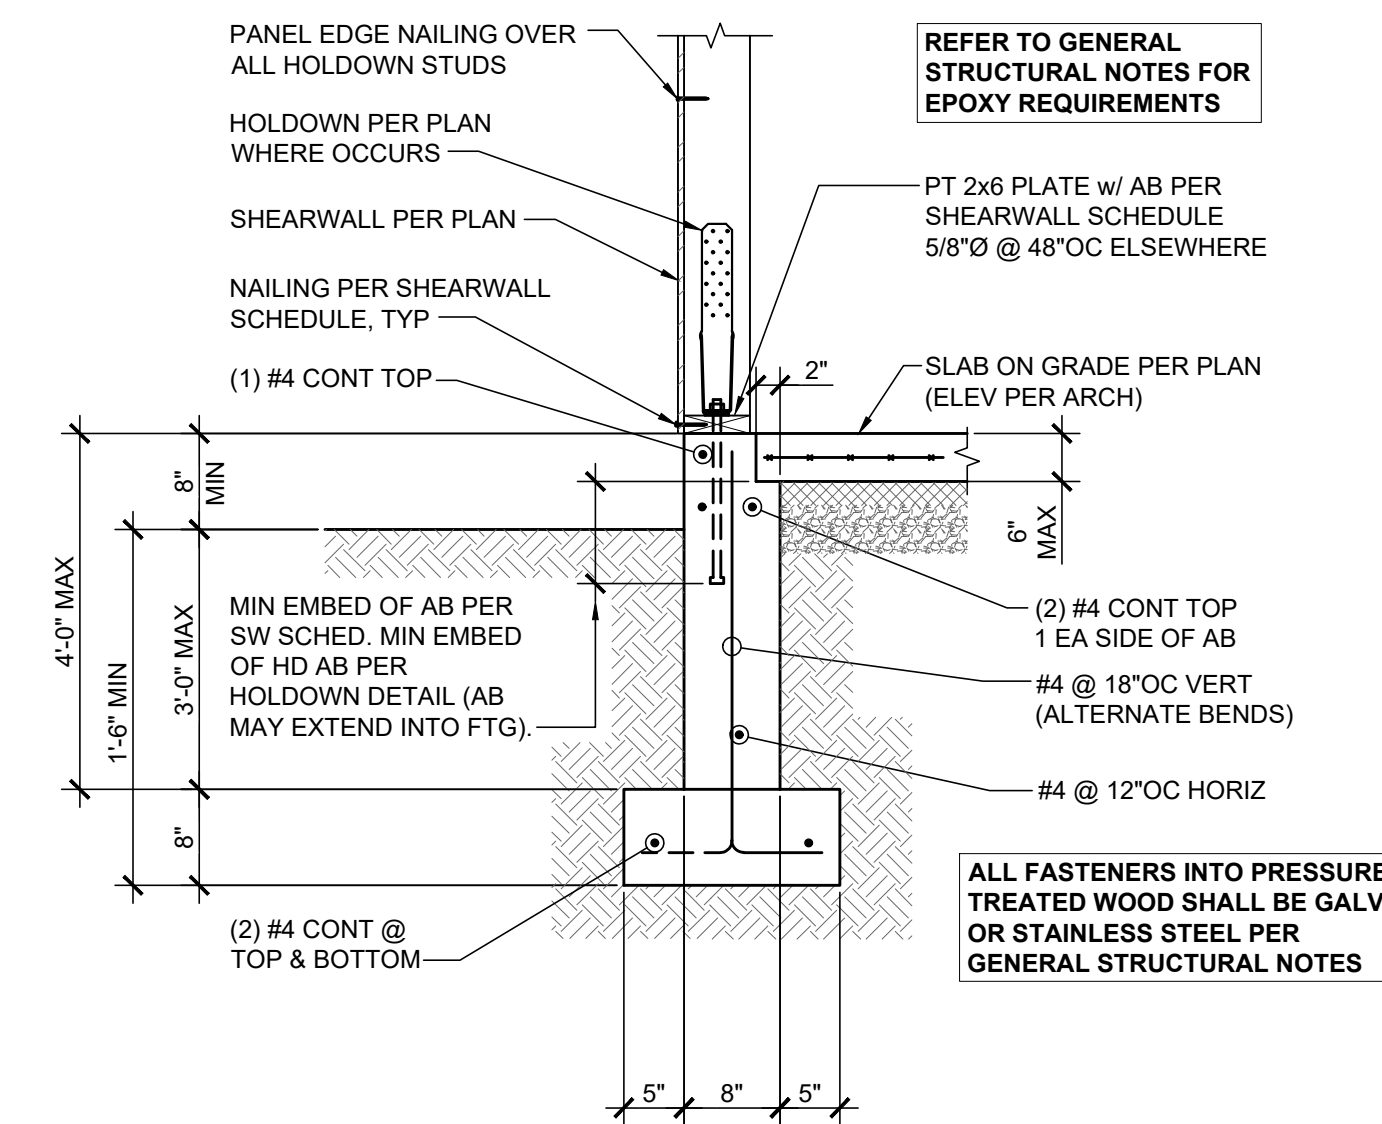


EXTERIOR GRADE BEAM @ SLAB ON GRADE 1
SCALE: 3/4" = 1'-0" S3.0

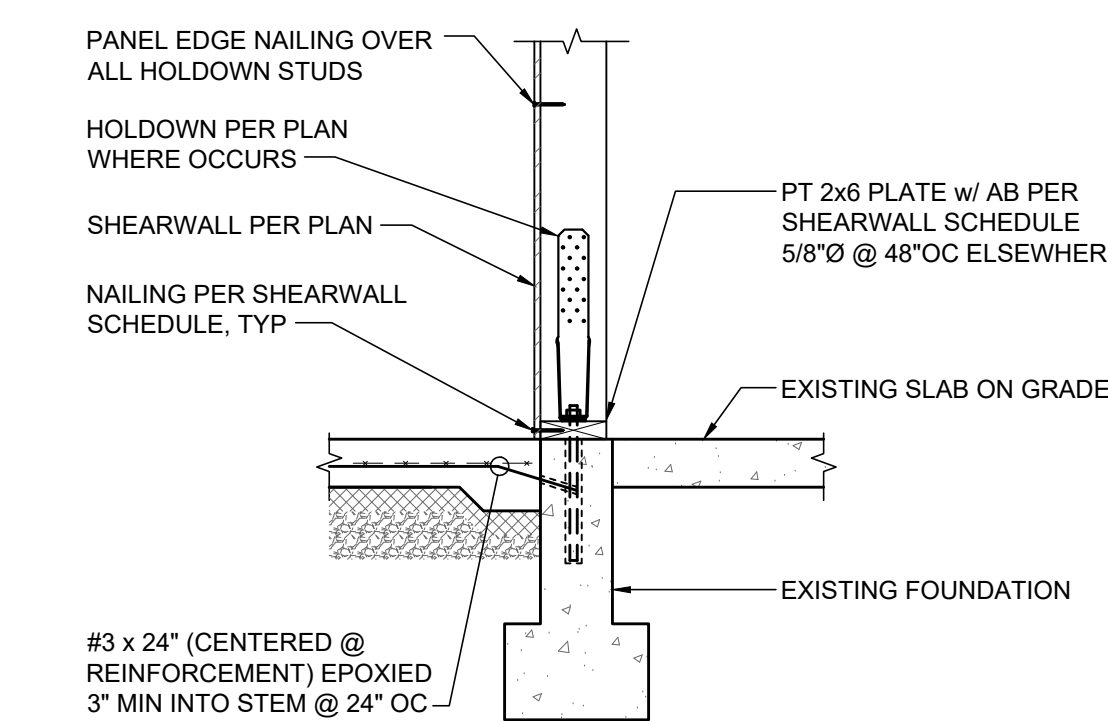

NEW SLAB AGAINST EXISTING FOUNDATION 5
SCALE: 3/4" = 1'-0" S3.0

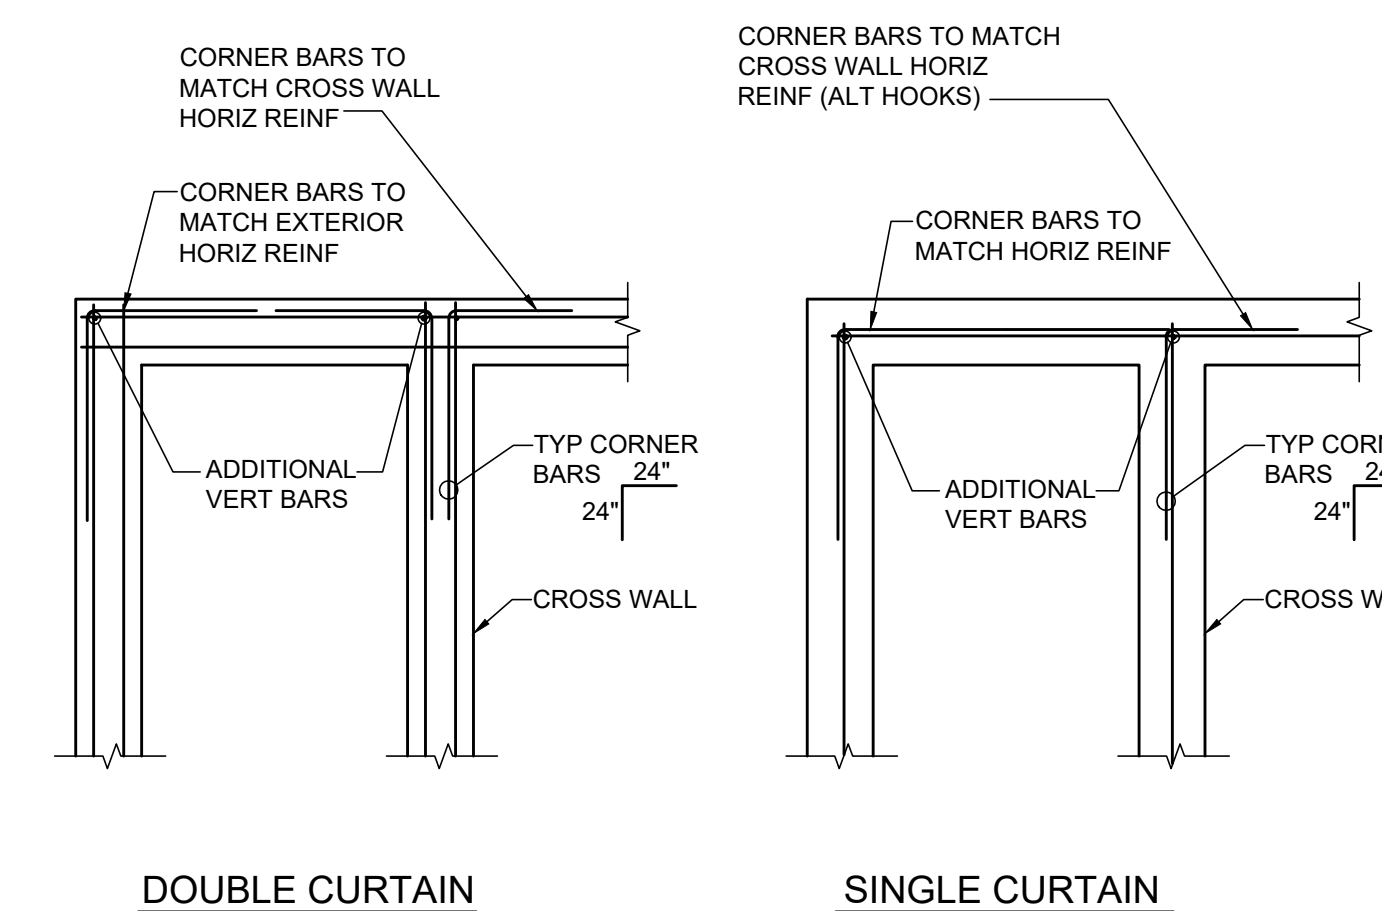


TYP CORNER BARS @ CONC WALLS & FTGS 9
SCALE: 3/4" = 1'-0" S3.0

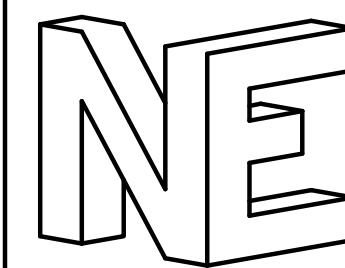

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MERCER ISLAND, WA 98040


No.	Date	Issue
0	12.22.22	Building Permit

Sheet Contents
FOUNDATION DETAILS

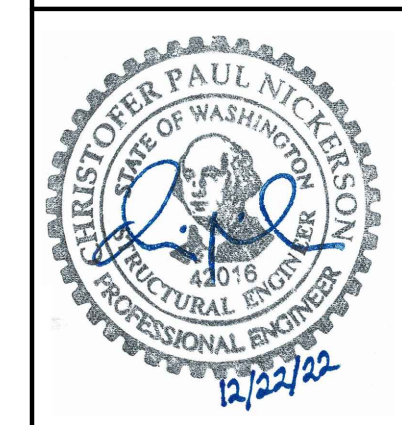Job No. 22-053

Sheet No.


S3.0

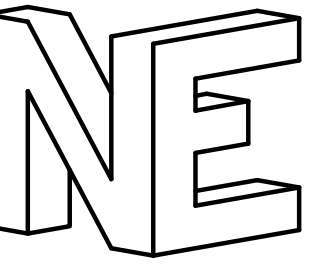



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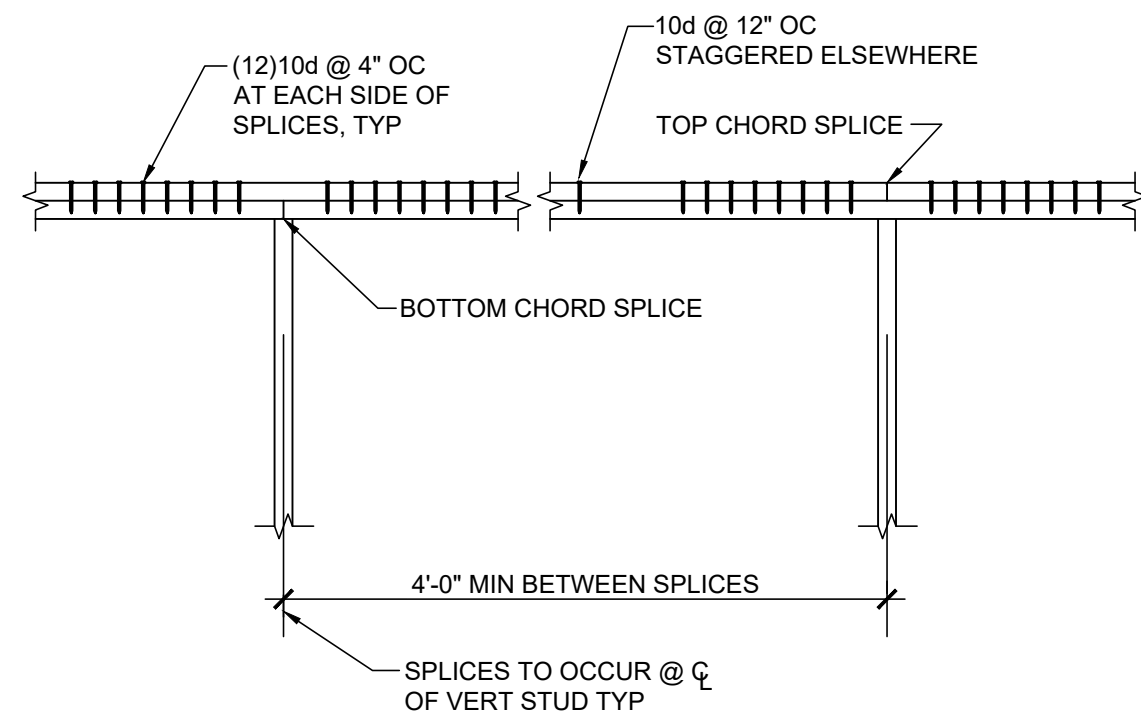
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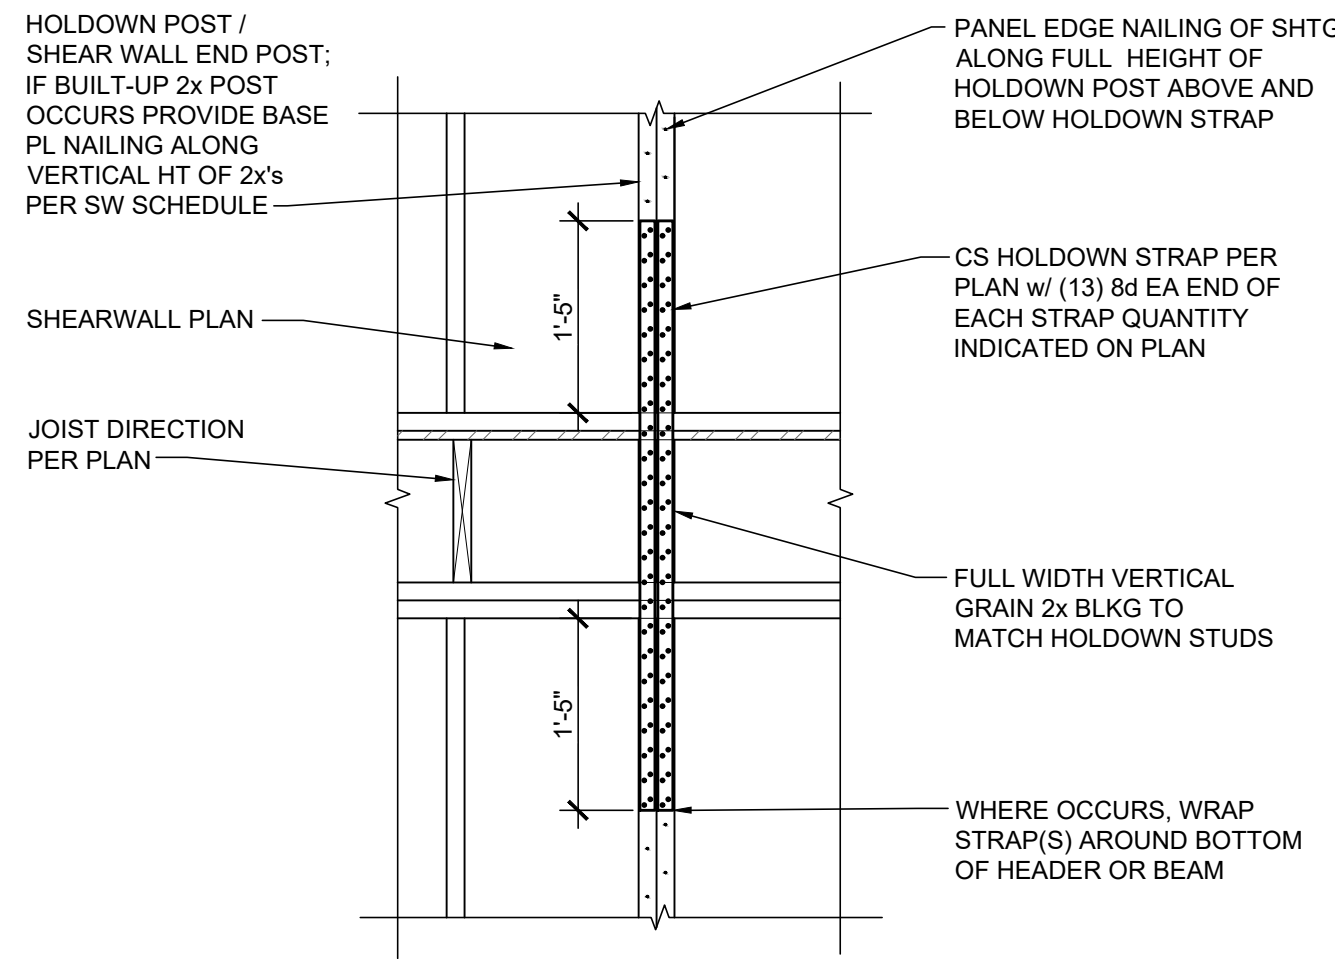
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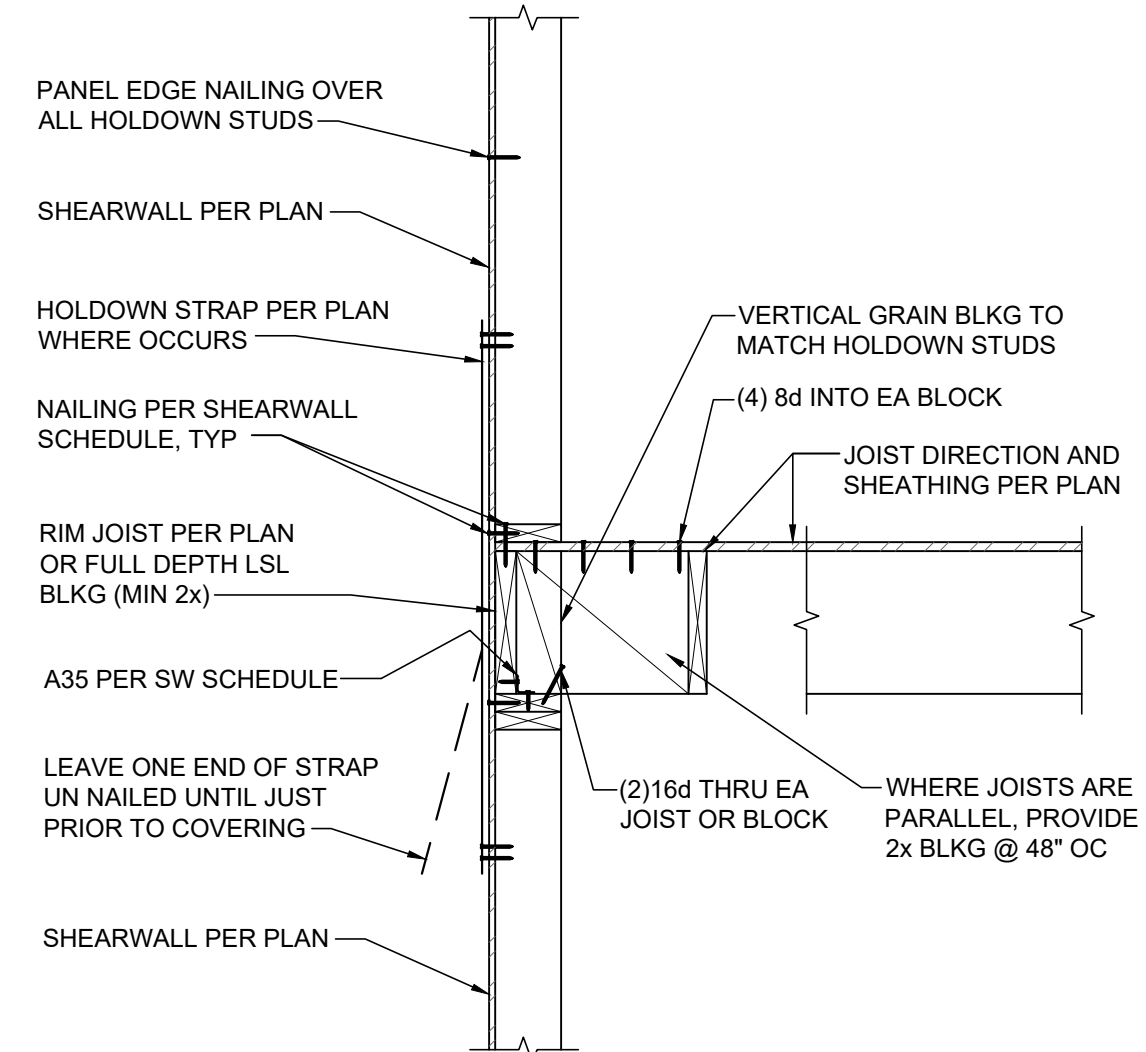
TYPICAL HEADER SUPPORT 4
SCALE: 3/4" = 1'-0" S4.0



TYPICAL TOP PLATE SPLICE 3
SCALE: 3/4" = 1'-0" S4.0

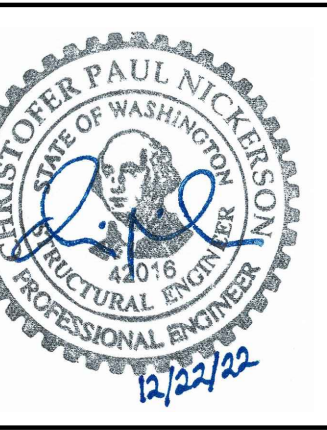

TYPICAL CS HOLDOWN STRAP 8
SCALE: 3/4" = 1'-0" S4.0

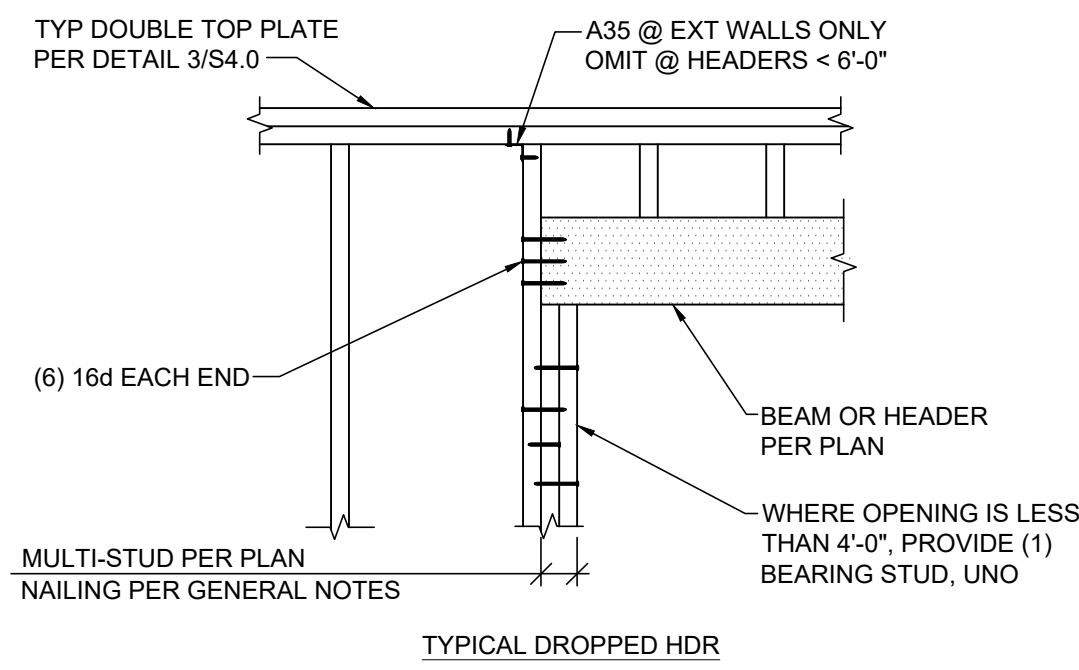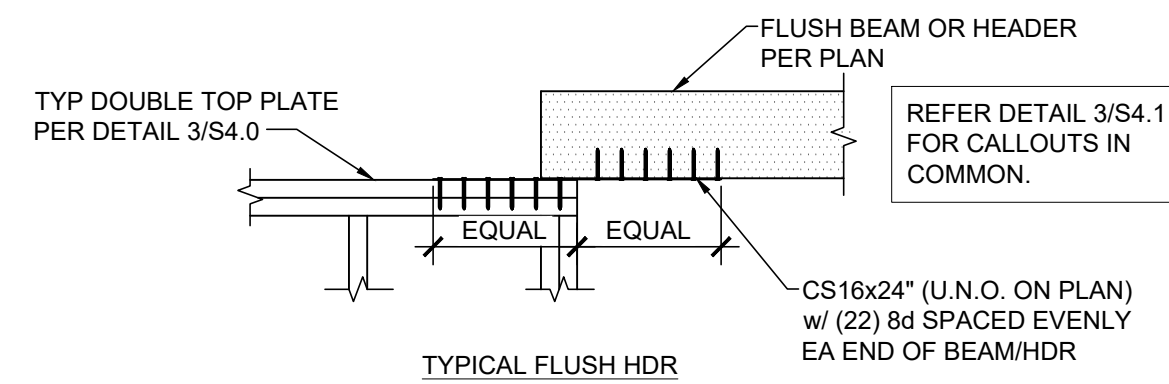


EXTERIOR WALL @ FLOOR 7
SCALE: 3/4" = 1'-0" S4.0


SHEARWALL (SW) SCHEDULE 147

MARK	SHEATHING	PANEL EDGE NAILING	TOP PL CONNECTION	BASE PLATE CONNECTION	
				at WOOD	at CONCRETE
SW1	1/2" PLYWOOD	8d @ 6" OC	A35 @ 24" OC	16d @ 6" OC	3/8" AB @ 48" OC
SW2	1/2" PLYWOOD	8d @ 4" OC	A35 @ 16" OC	16d @ 4" OC	3/8" AB @ 32" OC
SW3	1/2" PLYWOOD	8d @ 3" OC	A35 @ 12" OC	16d @ 3" OC	3/8" AB @ 16" OC
SW4	1/2" PLYWOOD	8d @ 2" OC	A35 @ 9" OC	(2) ROWS 16d @ 4" OC	3/8" AB @ 12" OC
SW5	1/2" PLYWOOD EACH SIDE	8d @ 3" OC EACH SIDE	A35 @ 6" OC	(2) ROWS 16d @ 3" OC	3/8" AB @ 12" OC

- BLOCK PANEL EDGES WITH 2x LAID FLAT AND NAIL PANELS TO INTERMEDIATE SUPPORTS WITH 8d @ 12" OC.
- 8d NAILS SHALL BE 0.131"Ø x 2 1/2" (COMMON); ACCEPTABLE SUBSTITUTE FOR 8d's ARE 10d's OF 0.131"Ø x 3" AT CONTRACTOR'S OPTION; 16d NAILS SHALL BE 0.135"Ø x 3 1/2" (BOX), 0.148"Ø x 3 1/4" (SINKER), OR 0.162"Ø x 3 1/2" (COMMON WIRE)
- EMBED ANCHOR BOLTS (AB'S) 7" MIN & PROVIDE 3"x3"x1/4" PL WASHER AT EA AB; EXPANSION BOLTS, TITEN HD ANCHORS, OR EPOXY EMBEDDED THREADED RODS MAY BE POST INSTALLED IN LIEU OF AB'S; ALL POST INSTALLED ANCHORS SHALL HAVE 3"x3"x1/4" PL WASHER; EPOXY EMBEDDED OPTION SHALL UTILIZE SIMPSON AT-XP EPOXY.
- (2)2x STUDS MIN ARE REQUIRED AT THE END OF ALL SHEAR WALLS TO RECEIVE THE PANEL EDGE NAILING, UNLESS NOTED OTHERWISE. AT BUILT-UP 2x STUDS, PROVIDE 16d FACE NAILS ALONG FULL HEIGHT OF 2x's, SPACED PER BASE PLATE NAILING REQUIREMENTS OF THE SPECIFIC SW TYPE (PER PLAN).
- SW3, SW4 & SW5 REQUIREMENTS: 3x STUDS OR (2) 2x STUDS ARE REQUIRED AT ABUTTING PANEL EDGES. WHERE (2)2x STUDS ARE UTILIZED, PROVIDE 16d FACE NAILS ALONG FULL HEIGHT OF 2x's, SPACED PER BASE PLATE NAILING REQUIREMENTS OF THE SPECIFIC SW TYPE (PER PLAN) - SEE DETAIL B. EACH ROW OF PANEL EDGE NAILING TO BE STAGGERED HORIZONTALLY - SEE DETAIL D. FOR SW5, ABUTTING PANEL EDGES SHALL BE OFFSET EACH SIDE OF WALL.
- SW3, SW4 & SW5 ANCHOR BOLT & PLATE WASHER PLACEMENT - PLATE WASHERS SHALL BE NO MORE THAN 1/2" FROM INTERIOR FACE OF SHEATHING/SILL PLATE EDGE WHERE NAILING OCCURS - SEE DETAIL C. AT SW5, ANCHOR BOLTS TO BE STAGGERED.
- ALL EXTERIOR WALLS SHALL BE SW1, UNLESS NOTED OTHERWISE.
- ALTERNATIVE CONNECTIONS FOR A35'S: LTP4 FLAT PL'S AT SAME SPACING FROM RIM/BLOCKING/BEAM TO TOP PL'S. WHEN LTP4'S ARE INSTALLED OVER 1/2" SHEATHING, PROVIDE 0.131"Ø x 2 1/2" NAILS INSTEAD. OTHER ALTERNATIVE CONNECTIONS FOR A35'S: A 2x NAILER FOR CEILING CONNECTION, OR THE HORIZONTAL SHEATHING SPLICE/Joint TO OCCUR ON RIM/BLKG/BEAM (ABOVE TOP PL'S & BELOW BOTTOM PL) - SEE DETAIL A. AT SW5 & SW6, INSTALL LTP4 FLAT PL'S AS SPECIFIED TO EACH SIDE OF FULL DEPTH BLOCKING OR BEAM. BLOCKING/BEAM WIDTH TO MATCH SW WIDTH.
- 3/16" OSB IS ACCEPTABLE SUBSTITUTE FOR 1/2" CDX PLYWOOD w/ SIMILAR SPAN RATING.
- ALL RIMS TO BE 2x TO MATCH FLOOR/DECK JOISTS ADJACENT (10" OR 12" PER PLAN) MIN U.N.O. AS WIDER PER PLAN.

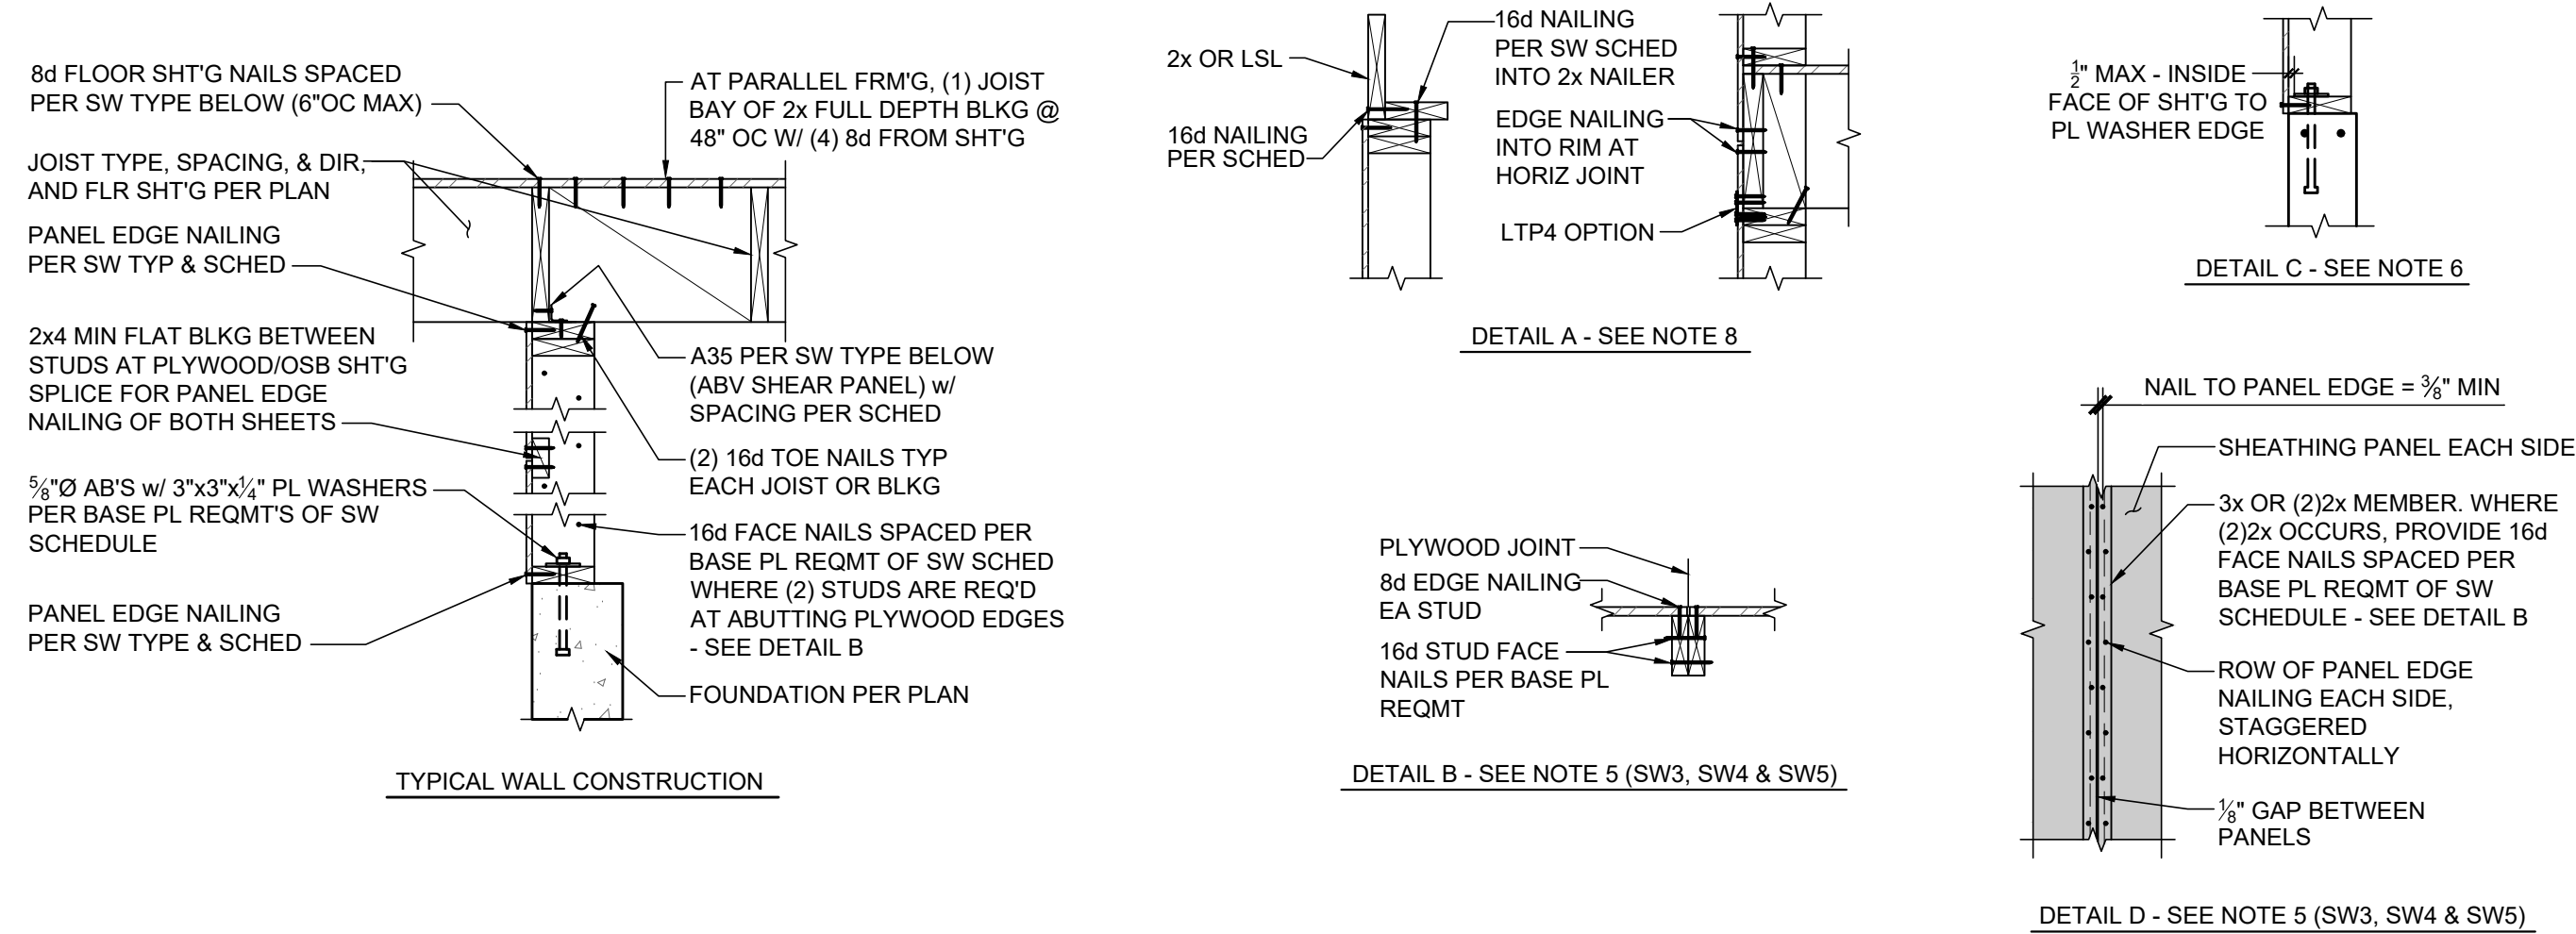

SHEARWALL SCHEDULE AND TYPICAL CONSTRUCTION 1
SCALE: NTS S4.0

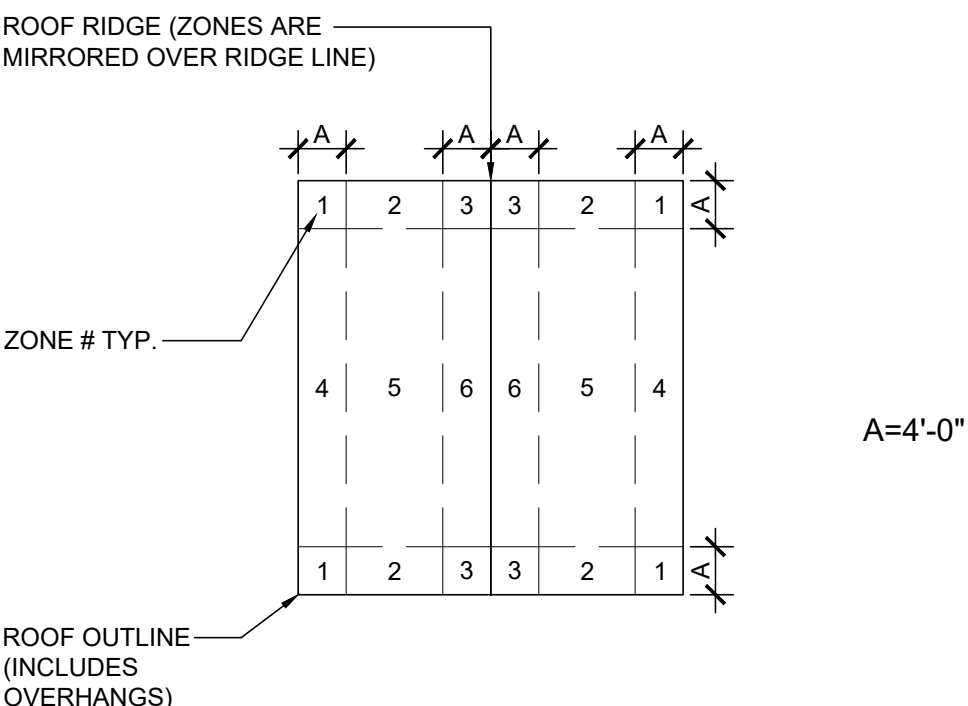

ZONE	PANEL EDGE NAILING	INTERMEDIATE FRAMING NAILING
1	8d @ 6" OC	8d @ 6" OC
2	8d @ 6" OC	8d @ 12" OC
3	8d @ 6" OC	8d @ 12" OC
4	8d @ 6" OC	8d @ 12" OC
5	8d @ 6" OC	8d @ 12" OC
6	8d @ 6" OC	8d @ 12" OC

ADDITIONAL ROOF NAILING (PITCHED ROOF) 12
SCALE: 3/4" = 1'-0" S4.0


No.	Date	Issue
0	12.22.22	Building Permit

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Sheet No.



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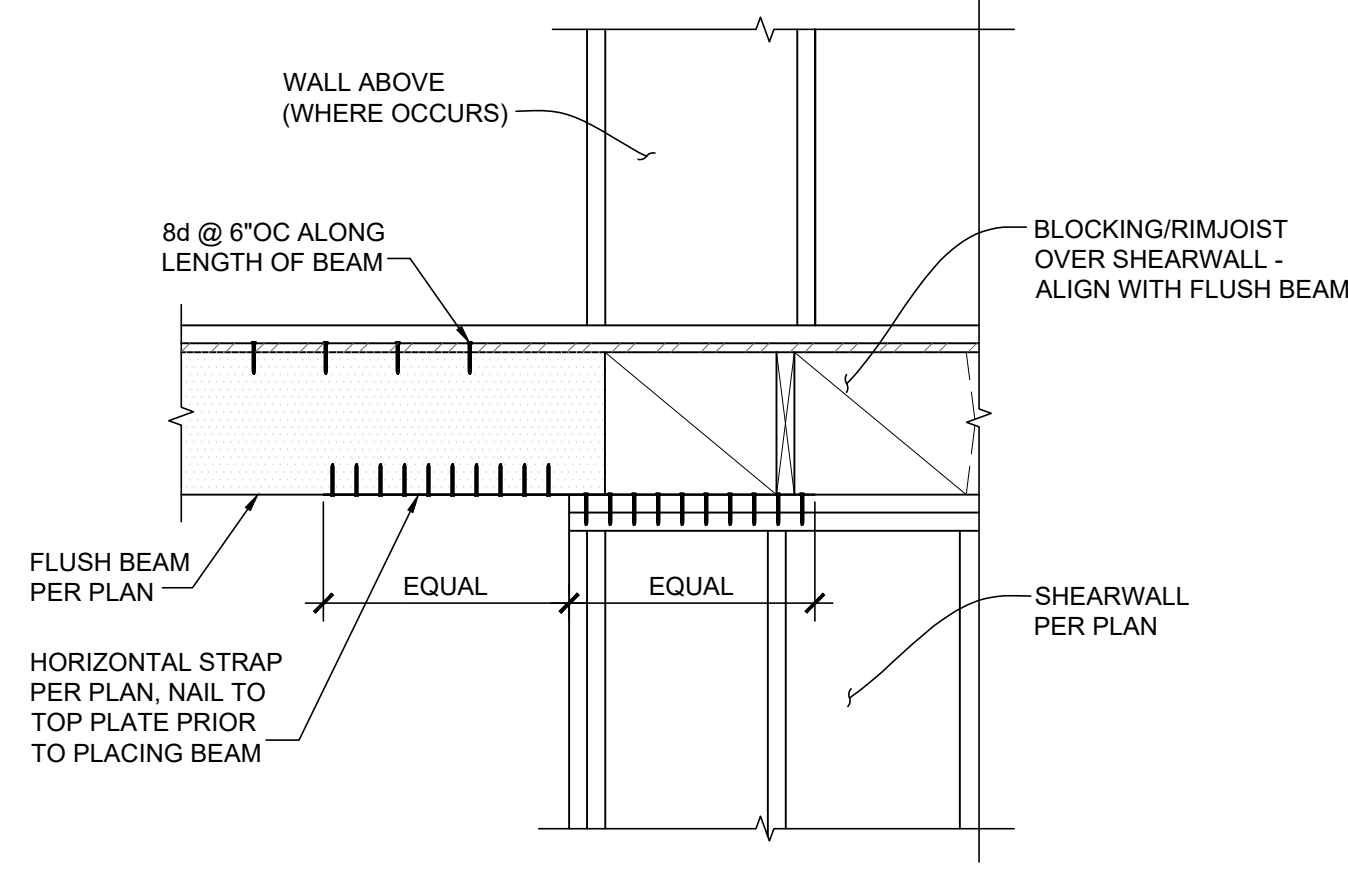
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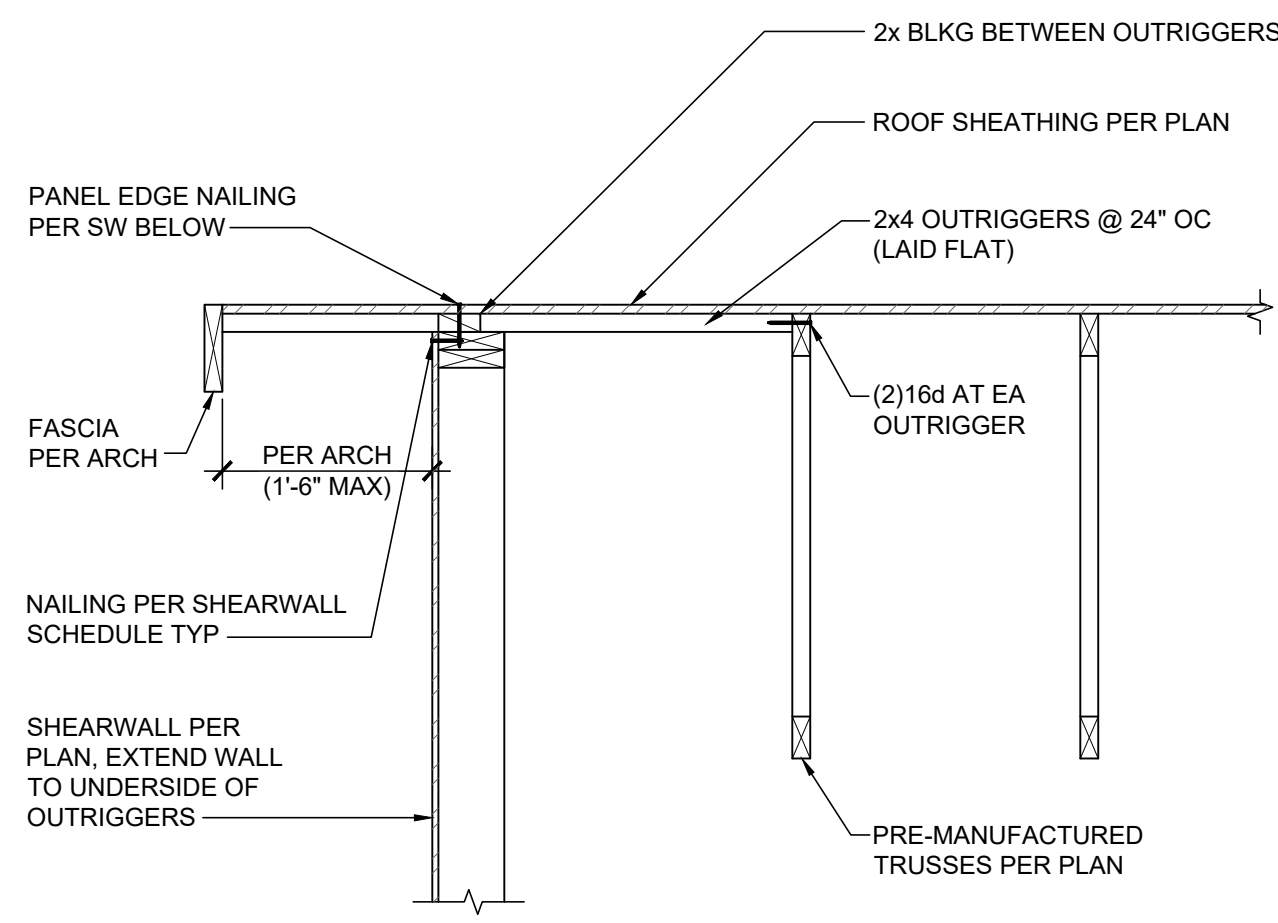
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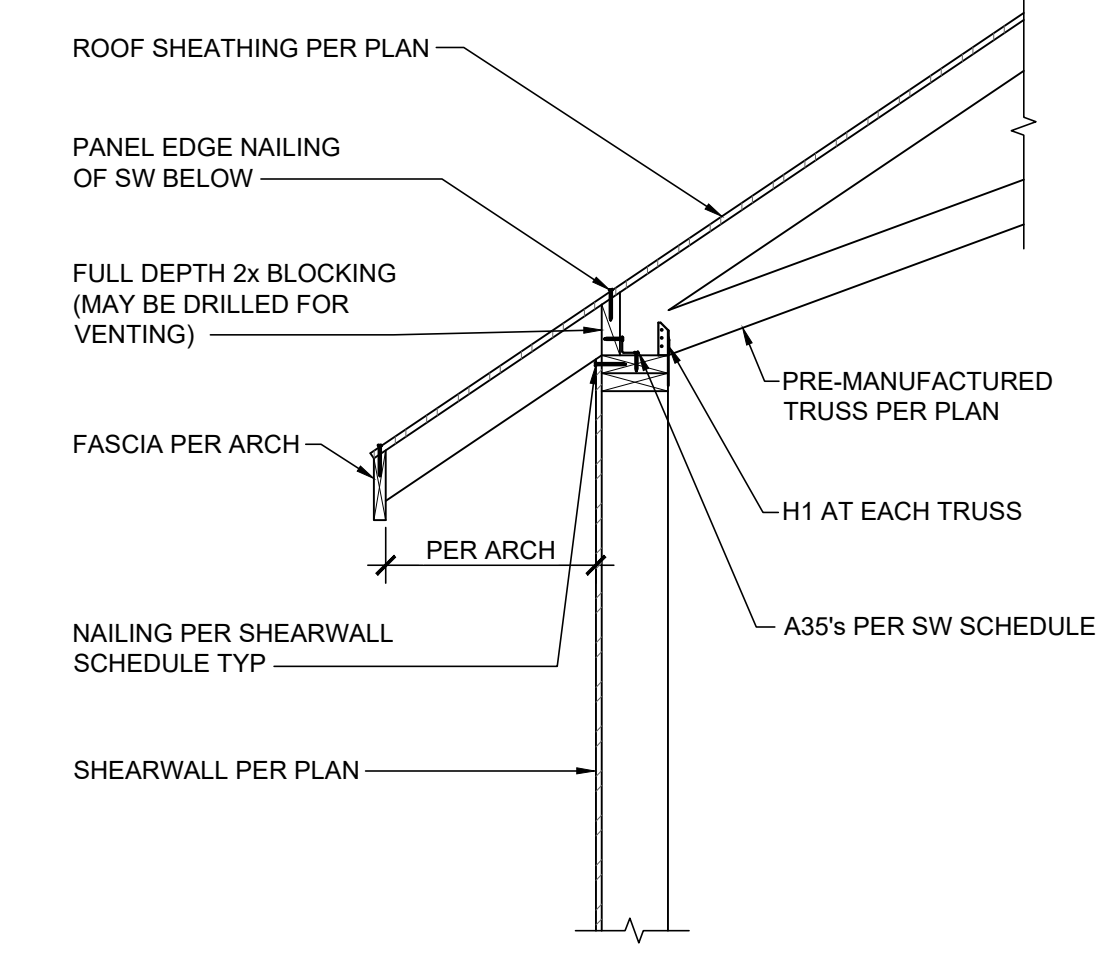
OVER FRAMING CONNECTION 4
SCALE: 3/4" = 1'-0"
S4.1




TYPICAL DRAG STRUT STRAP 3
SCALE: 3/4" = 1'-0"
S4.1

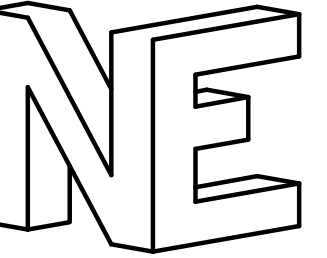


EXTERIOR WALL @ GABLE END 2
SCALE: 3/4" = 1'-0"
S4.1

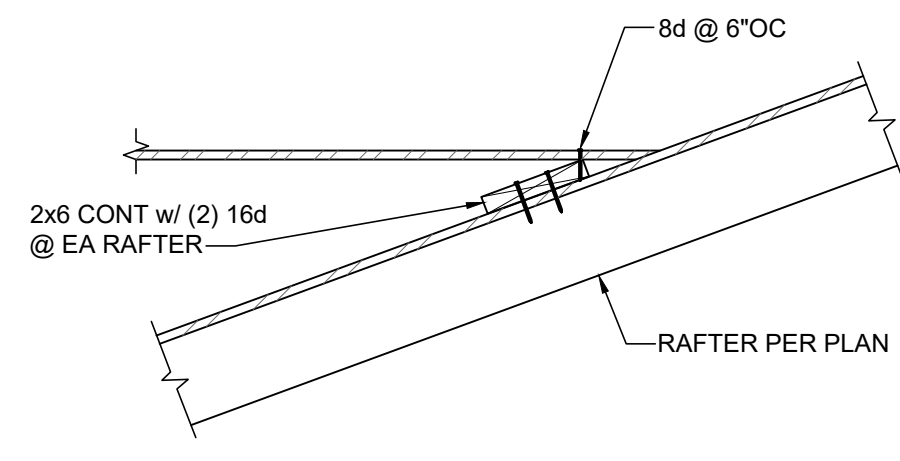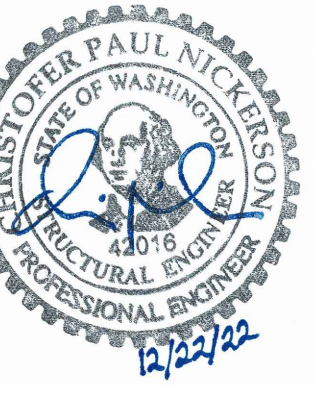


EXTERIOR WALL @ EAVE 1
SCALE: 3/4" = 1'-0"
S4.1

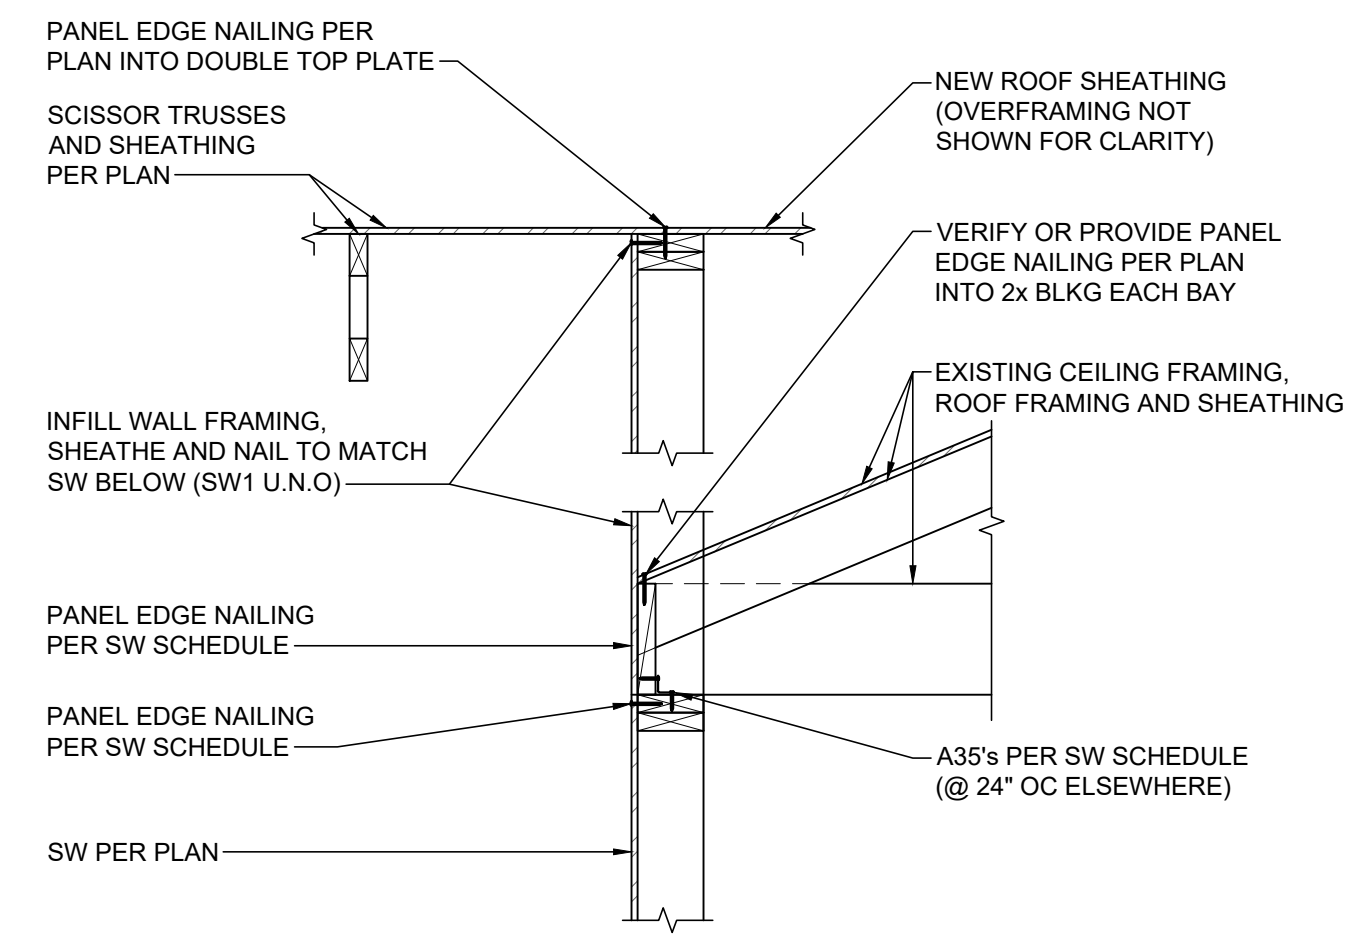


NEW ROOF AT OVERFRAMING 8
SCALE: 3/4" = 1'-0"
S4.1

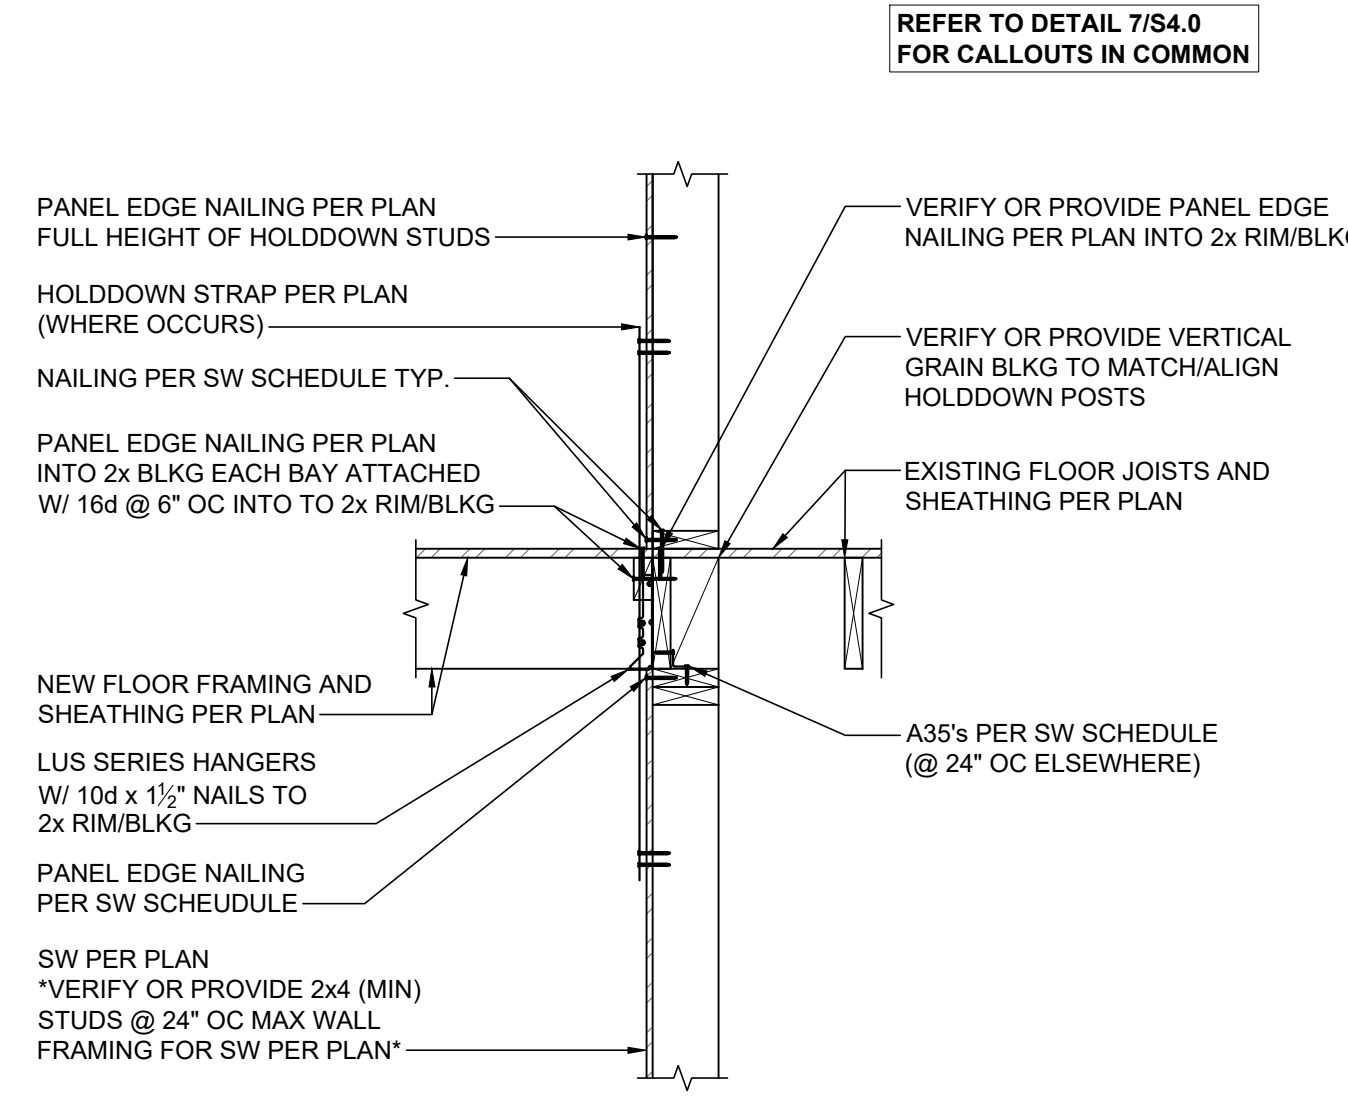


NEW FLOOR FRAMING AT EXISTING EXTERIOR WALL 7
SCALE: 3/4" = 1'-0"
S4.1

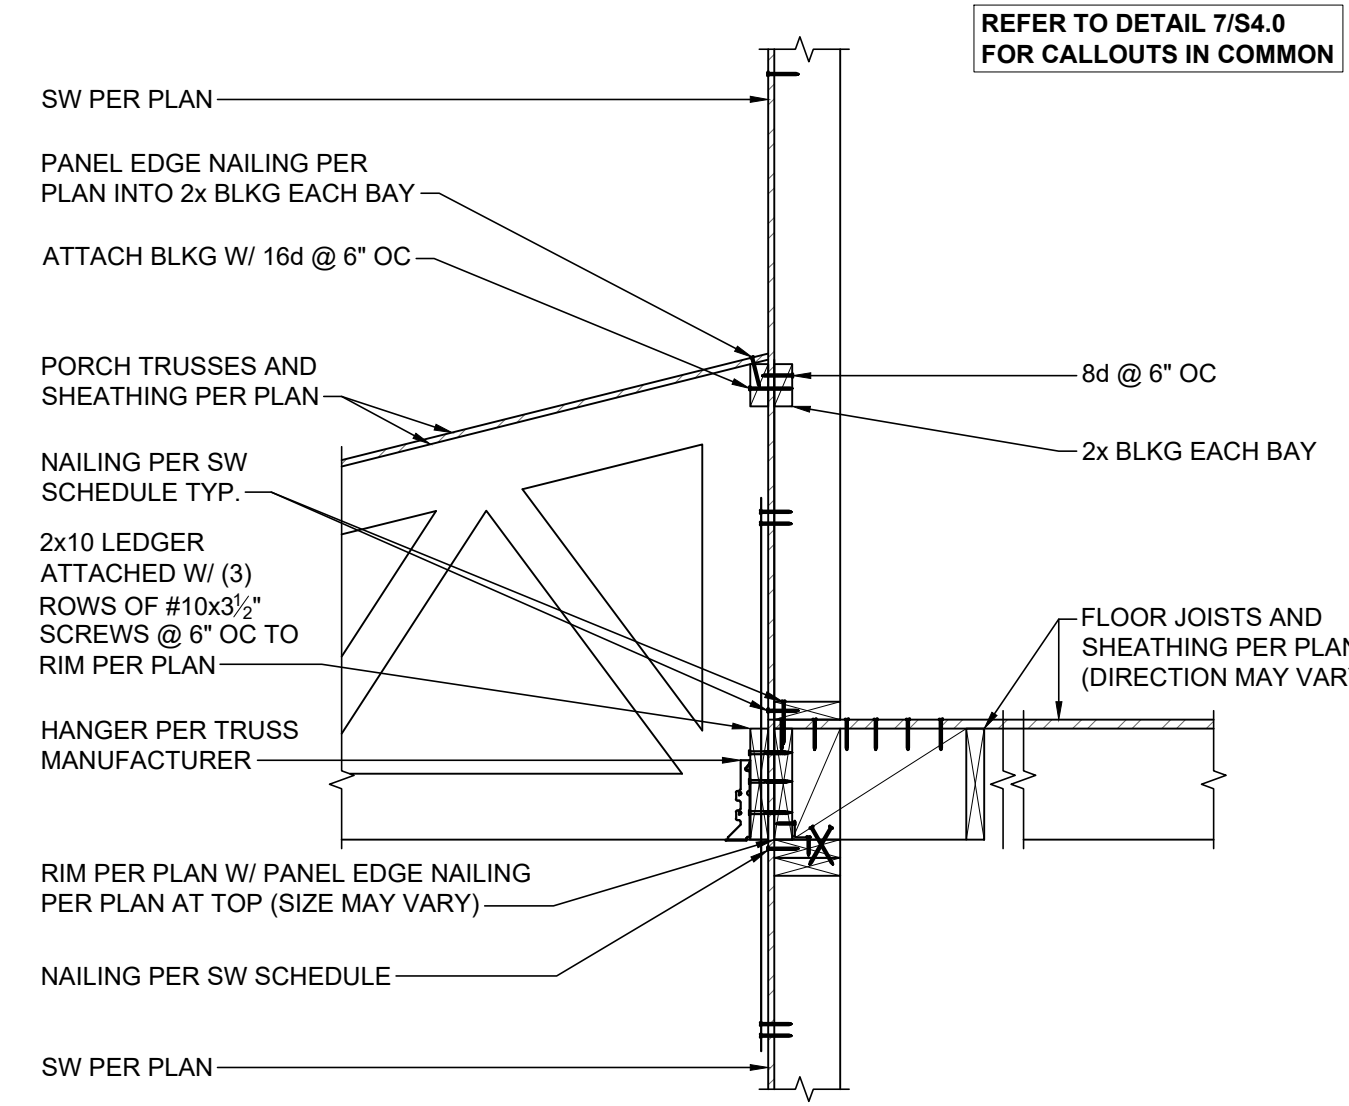

PORCH TRUSSES AT EXTERIOR WALL 6
SCALE: 3/4" = 1'-0"
S4.1

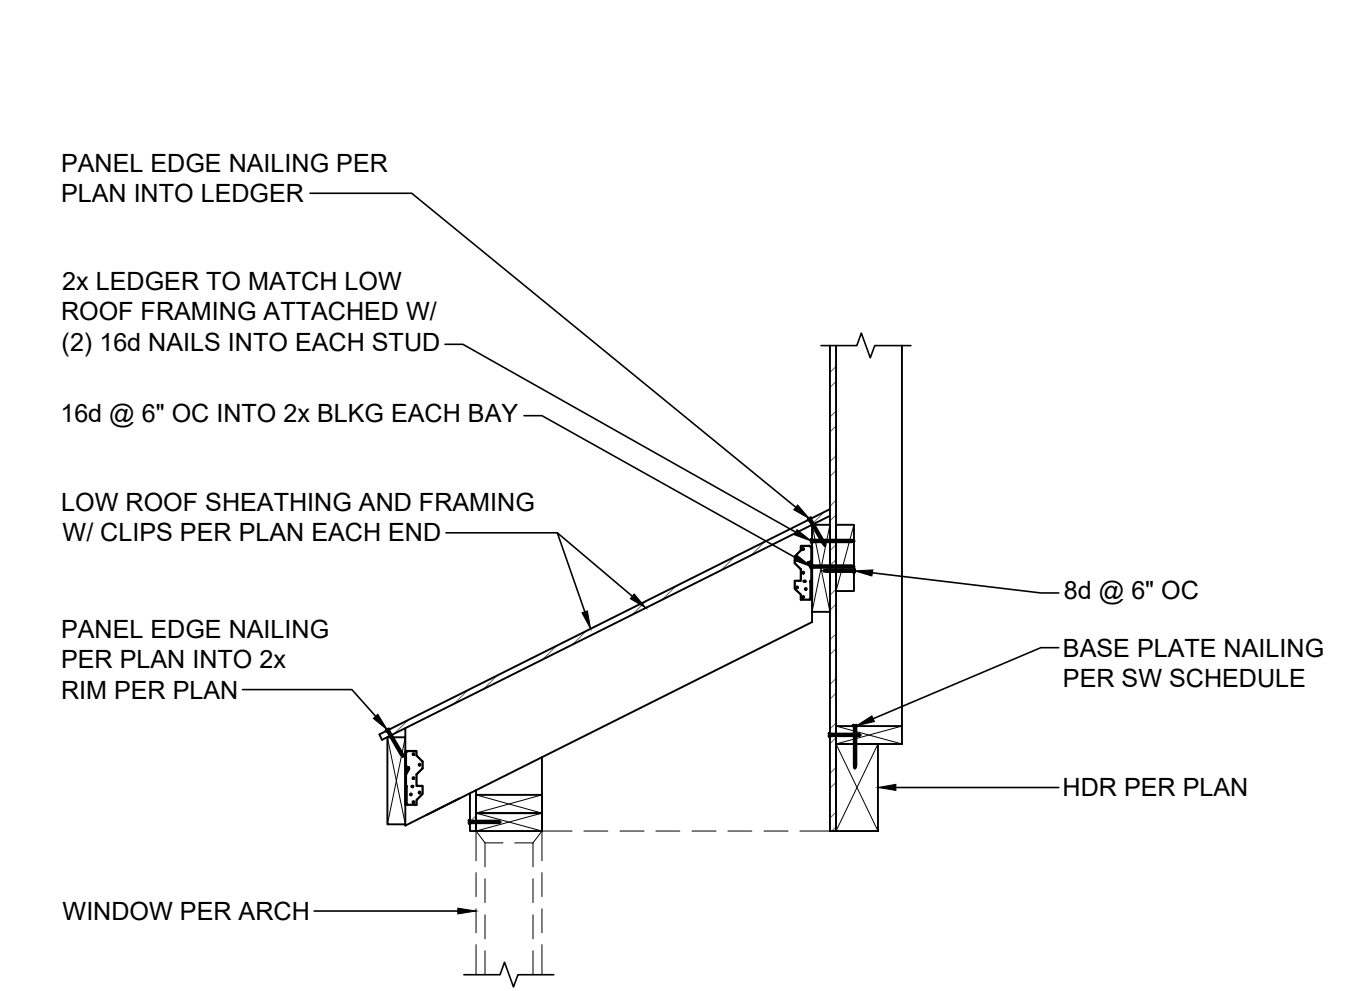

LOW ROOF FRAMING @ WINDOW BUMP OUT 5
SCALE: 3/4" = 1'-0"
S4.1

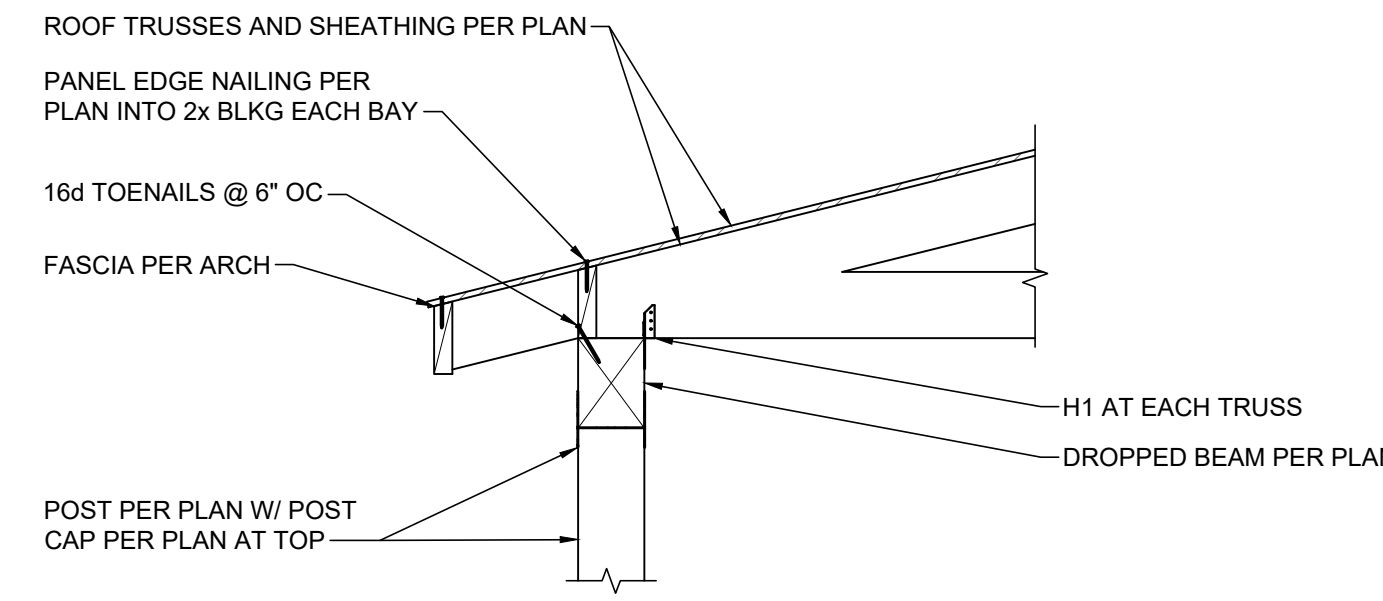

PORCH TRUSSES AT DROPPED BEAMS 9
SCALE: 3/4" = 1'-0"
S4.1

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