CTANDADD ADDDEVIATIONS AND SYMBOLS

STANDARD ABBR	EVIATIONS AND	SYME	BOLS	
ANGLE Z CENTERLINE	FIBERGLASS FIRE HOSE CABINET	FGL FHC	PAIR PRE-CAST	FRC:
CHANNEL	FINISH	FIN	PRESSURE TREATED PAPER TOWEL DISPENSER	FT PT
NUMBER OR POUND	# FLASHING	FL FLG	PAPER TOWEL DISPENSER	PTD.
PENNY (PERPENDICULAR	_ FACE OF CONCRETE	FLUOR FOC	AND RECEPTACLE PARTITION	PT
ANCHOR BOLT A		FOF FOIC	PAPER TOWEL RECEPTACLE POLYVINYL CHLORIDE	P ⁻ P\
ACOUSTICAL A AIR CONDITIONING A/		OR FOIO	PAVEMENT QUARRY TILE	PVN
ACOUSTICAL TILE AC	T INSTALL BY OWNER		RISER	
ADDITIVE AD ADHESIVE AD	FIREPLACE	FOS FP	RETURN AIR RADIUS	F RA
ADJACENT AE ADJUSTABLE ADJ	FEET FEET	FS FT	RUBBER BASE	F
ACCESS FLOOR ABOVE FINISH FLOOR AF	F FOOTING	FPRF FTG	ROD & SHELF ROOF DRAIN	R8
AGGREGATE AG	FURKING FUTURF	FURR FUT		RD/ REB/
ALUMINUM ALTERNATE AL	T FIXED	FUT-RIO FX	REFERENCE REFRIGERATOR	RI REI
ACCESS PANEL APPROXIMATE APPRO	X GALIGE OR GAGE	GA	REINFORCED REQUIRED	REIN RE
ARCHITECTURAL ARC ASPHALT ASP	H GALVANIZED	GALV GB	RESILIENT REGISTER	RES RG
ATTENUATION AT ACOUSTICAL WALL FABRIC AW	^T general ge	EN CONTR	RIGHT HAND OR ROBE HOOK ROOM	(F R
ACOUSTICAL WALL PANEL AW	P GLASS OR GLAZING	GL	ROUGH OPENING OR REVERS OSMOSIS WATER	
BOARD B BETWEEN BETV	U GLASS MEST MORTAR ON		ROUGH SAWN	וח
BITUMINOUS BITUI	GROOND	GND GR	RUBBER REVERSE	RU RV
BUILDING BLD BLOCK BL	K GYPSUM	GWB GYP	SOUTH	
BLOCKING BLK BEAM BI	G M HOSE BIB	НВ	SOLID CORE SEAT COVER DISPENSER	SC
BEARING BR BOTTOM BC	G HARD BOARD	HBD HC	SCHEDULE SOAP DISPENSER	SCH
BEDROCK BRICK BR	R HAND DRYER	HD	SECTION	SEC
BASEMENT BSM BUILT-UP ROOF BU	T HARDWOOD	HDR HDWD	SQUARE FEET SAFETY GLAZING	5
CABINET CA	HOLLOW METAL	HDWE HM	SHOWER SHEET	SH SH
CATCH BASIN C	B HOUR	HORIZ HR	SHEATHING SOLAR INSULATED GLAZING	SHT S
CEMENT CEI CERAMIC CE	R HEATING	HT HTG	SIMILAR SINK	SI
CUBIC FEET PER MINUTE CFI CONDUCTIVE FLOOR TILE CF	T AIR CONDITIONING	HVAC	SEALER SANITARY NAPKIN	SI SN
CORNER GUARD CHALK BOARD CHB	G HOT WATER HEATER	HWH	DISPENSER SANITARY NAPKIN	SN
CAST IRON CONTROL JOINT CAST IRON	CI INSIDE DIAMETER T (DIMENSION)	ID	RECEPTACLE	SN
CEILING CL CONSTRUCTION JOINT C	INSULATED GLAZING	IG	SEALANT STAND PIPE	
CUP SINK CAULKING CL	S METAL	IHM	SPECIFICATION SQUARE	SPE S
CLOSET CL CLEAR CL	INSULATION	INCL INSUL	STAINLESS STEEL SERVICE SINK	S:
CERAMIC MOSAIC TILE CM	T	INT	SOUND TRANSMISSION CLASS	ST
CONCRETE MASONRY UNIT CM COUNTER CNT	R JOIST	JAN JST	STANDARD STEEL	ST S
CLEANOUT C COLUMN CC	D JOINT L	JT	STORAGE STRUCTURAL	STC STI
CONCRETE CON CONNECTION CON	NHC.FIEN	KIT KS	SUSPENDED	SU:
CONSTRUCTION CONST CONTINUOUS CON	R T		SHEET VINYL OR SEAMLESS VINYL	C) 10
CORRIDOR COR CARPET CF	r Laminate t Laminate	LAB LAM	SERVICE SYMMETRICAL	SV(
CASEMENT CSM CERAMIC TILE	T LACROLT	LAV LB	SWITCHBOARD SPECIAL WALL COVERING	SWE
CENTER CT COUNTER SINK CTS	R LENGTH	LG LH	TREAD	
	Y LOCKER LIQUID MARKING SURFACI	LKR E LMS	TOWEL BAR TERRAZZO	TE
DOUBLE DE		LT E LWC	TELEPHONE TOP AND BOTTOM	TI & T
DEPARTMENT DEF DETAIL DE	T MACHINE	MACH	TONGUE AND GROOVE TEMPERED GLAZING	T &
DRINKING FOUNTAIN DEIONIZED WATER	F MASONRY DI MATERIAL	MAS MATL	THRESHOLD TEMPERED INSULATED	T⊦ T
DIAMETER DI DIAGONAL DIA	A MAXIMUM	MAX	GLAZING	
DIMENSION DII DISPENSER DIS	d Medium Density Overla		TACKBOARD TOP OF	TKE T
DAMPPROOFING DMF	F MEMBRANE	MECH MEMB	TOP OF CURB TOP OF FOOTING	TC TC
DAMPER DP DOWNSPOUT D	R METAL ME R MEZZANINE	T OR MTL MEZZ	TOP OF PAVEMENT TOP OF STEEL	TC TC
DISHWASHER DI	V MANUFACTURER	MFR MH	TOP OF SLAB TOP OF WALL	TO:
DRAWING DW	MIRROR	MIN MIR	TOILET PAPER DISPENSER TOILET PARTITION	TF TPT
EACH	E MISCELLANEOUS A MOLDING	MISC MLD	TELEVISION TYPICAL	T\
EXPANSION BOLT EXPANSION JOINT E	MASONRY OPENING MOUNTED	MO MTD	UNDERWRITERS	Į
EXTERIOR INSULATED EIF FINISH SYSTEM	S MULLION	MULL	LABORATORY UNFINISHED	1U
ELEVATION E ELECTRIC ELE	NORTH	N	UNLESS OTHERWISE NOTED	UC
ELEVATOR ELE ENTRY MAT EI	NOT IN CONTRACT	NIC	URINAL	
EMERGENCY EME ENCLOSURE OR ENCLOSED ENC	R NOMINAL	NO NOM	VARIES VINYL BASE	VA \
ELECTRIC PANEL BOARD EPOXY EP	P NOISE REDUCTION COFFFICIENT	NRC	VINYL COMPOSITION TILE VAPOR RETARDER	V(
EQUAL	NOT TO SCALE	NTS	VENTILATOR VERTICAL	VEN VEN
EQUIPMENT EQF EMERGENCY SHOWER/ ESEV	()(/ L) / l	OA OBS	VESTIBULE VINYL	VE:
EYE WASH ESTIMATE ES	ON CENTER	OC OD	VENEER VINYL TILE	/V
EXHAUST EX EXPANSION E	X (DIMENSION)		VINYL WALL COVERING	VW
EXISTING () EMERGENCY EYE WASH EV	OFFICE OVERHEAD	OFF OH	WEST	
EXTERIOR EX	T OPPOSITE HAND OPENING	OPH OPNG	WITH WITHOUT	V W/
FIRE ALARM F		OPP	WATER CLOSET WOOD OR WIDTH	V
FLAT BAR F FIBER BOARD FB	PREFABRICATED	PBD PFB	WINDOW WIRE GLASS	WD'
FURNISHED BY OTHERS FB FURNISHED BY CONTRACTOR FCI) PREFINISHED	PFHB	WIRE MESH WATER PROOF	W
INSTALL BY CONTRACTOR FACTORY FCT	PLASTIC LAMINATE	P LAM PLYWD	WORKING POINT WATER RESISTANT	WI
FLOOR DRAIN F FOUNDATION FD	PANEL	PNL	WAINSCOT WEIGHT	WS0
FIRE EXTINGUISHER FIRE EXTINGUISHER CABINET FE	E POLISH	PNT POL	WEIGHT WELDED WIRE FABRIC TRANSFORMER	WW
= 5.6 6 1 - 1 -			IIVANJI URIVIEK	XFN

SHEET INDEX							
SHEET NUMBER	SHEET NAME	CONTENTS					
GENERAL							
G 1.0	COVER SHEET	SYM KEY, BLDG CODE NOTES, PROP INFO, GEN NOTES					
G 1.1	WINDOW & DOOR SCH, ENERGY & MECH CODE NOTES, ASSEMBLIES	ENERGY CODE NOTES, MECH NOTES, SCHEDULES					
ARCHITECTURAL							
A 1.0	SITE PLAN	SITE PLAN, ZONING NOTES					
A 2.0	PENTHOUSE DEMOLITION PLAN	SCOP E OF DEMOLITION					
A 2.1	PENTHOUSE FLOOR PLAN	ROOM LAYOUT					
A 2.2	CLERESTORY PLAN	WINDOW LOCATIONS					
A 2.3	ROOF PLAN	MECHANICAL ROOF TOP UNITS AND VISUAL SCREEN					
A 3.0	EXTERIOR ELEVATIONS	ELEVATION AT NEW DOORS AND EXISTING ROOF PHOTOS					
A 4.0	SECTIONS	BUILDING SECTION					
A 6.0	INTERIOR ELEVATIONS	WINDOW ELEVATIONS					
E 1.0	LIGHTING PLANS	LIGHTING, SMOKE/CO DETECTOR AND VENTILATION LOCATIONS					
MECHANICAL							
M001	MANUAL J LOADS	FOR REFERENCE ONLY					
M101	DUCT PLAN	FOR REFERENCE ONLY					
M201	VENTILATION PLAN	FOR REFERENCE ONLY					
M301	HEAT PUMP SYSTEM DETAILS	FOR REFERENCE ONLY					

GENERAL NOTES READ BEFORE BEGINNING ANY WORK

1. THESE DRAWINGS AND THE INFORMATION THEY DEPICT ARE INSTRUMENTS OF SERVICE FOR THE ARCHITECT AND ARE PROTECTED FULLY BY COPYRIGHT LAW. UNDER NO CIRCUMSTANCES SHALL THESE DRAWINGS BE REPRODUCED AND USED IN ANY CAPACITY WHATSOEVER TO CONSTRUCT ANY BUILDINGS OR PORTIONS OF BUILDINGS AT LOCATIONS OTHER THAN THOSE WHICH ARE DEPICTED EXPLICITLY HEREIN. IT IS THE FULL INTENTION OF THE ARCHITECT TO DEPICT A BUILDING WHICH IS COMPLIANT TO EVERY ASPECT OF CURRENT LOCAL BUILDING CODES.

2. ENERGY, MECHANICAL AND LAND USE CODE. UNDER NO CIRCUMSTANCES HAVE ANY VIOLATIONS OF SAID CODES BEEN REPRESENTED INTENTIONALLY, AND UNDER NO CIRCUMSTANCES SHOULD THESE DRAWINGS BE INTERPRETED AS SUCH. IF VIOLATIONS OF CODE ARISE THROUGH THE REVIEW AND CONSTRUCTION OF THE BUILDING(S) CONTAINED IN THIS DRAWING SET, CONTACT THE ARCHITECT IMMEDIATELY BEFORE BEGINNING OR CONTINUING WORK.

3. DO NOT SCALE DRAWINGS. CONTACT ARCHITECT IMMEDIATELY BEFORE SUBMITTING PROPOSALS, BIDS, OR PROCEEDING WITH ANY WORK IF AMBIGUITIES, DISCREPANCIES, OR A LACK OF INFORMATION EXIST IN DRAWINGS.

4. ALL DIMENSIONS REFER TO FACE OF ROUGH FRAMING MEMBER OR FACE OF CONCRETE UON.


5. THIS PLAN SET DOES NOT CONSTITUTE A FINAL CONSTRUCTION SET UNLESS STAMPED AND FINALED BY A CITY MUNICIPALITY.

6. RESPONSIBILITY FOR THE SAFETY OF ALL INDIVIDUALS PERFORMING FIELD WORK TO CONSTRUCT THE BUILDING DELINEATED IN THIS DRAWING SET RESTS SOLELY ON THE CONTRACTOR. BY INTENT, THESE DRAWINGS CONTAIN NO INFORMATION REGARDING THE SAFETY OF THE INDIVIDUALS PERFORMING SAID WORK AS THE CONSIDERATION OF SUCH LIES FULLY WITHIN THE DUTIES AND EXPERTISE OF THE CONTRACTOR.

INSTALLATION

7. ALL PRODUCTS, MATERIALS, AND APPLIANCES SHALL BE INSTALLED DIRECTLY ACCORDING TO THE MANUFACTURERS WRITTEN INSTRUCTIONS. IF SAID INSTRUCTIONS CALL FOR A LICENSED PERSON OF A SPECIFIC TRADE TO PERFORM INSTALLATION, WORK SHALL BE DONE AS SUCH.

8. ALL FASTENERS USED TO SECURE PRESSURE TREATED WOOD MATERIALS SHALL BE GALVANIZED OR TREATED WITH A SIMILAR CORROSION-RESISTANT COATING.

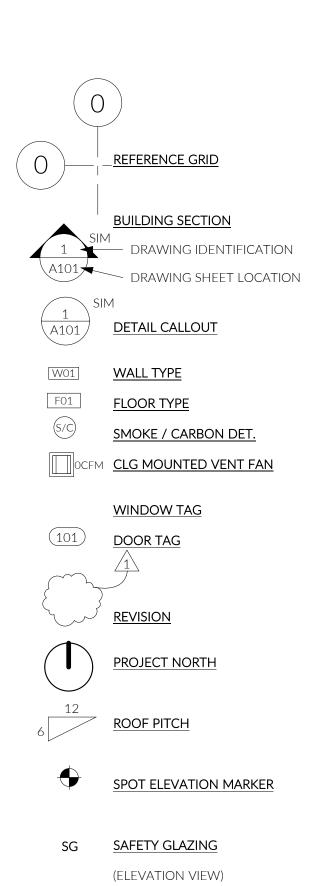

PROJECT TEAM

THOMAS AND JANET SOEPRONO 2800 75TH AVE SE, STE 300 MERCER ISLAND, WA 98040 TOM SOEPRONO (909) 709-0447

tsoeprono@gmail.com

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mandy@mandycallaway.com MECHANICAL DESIGN BUILD WITH BALANCE AARON BARNETT 206.409.4948 aaron@buildwithbalance.com

MANDY CALLAWAY

206.992.5949

ARCHITECT

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STRUCTURAL ENGINEER DCI ENGINEERS 818 STEWART ST, STE 1000 SEATTLE, WA 98101

taylor@firstlamp.net

GREG GILDA 206.332.1900 ggilda@dci-engineers.com

BUILDING ENVELOPE CONSULTANT CROSS 2 DESIGN GROUP

2476 WESTLAKE AVE N. STE 102 SEATTLE, WA 98109 AARON LEMCHEN 206.283.0066 alemchen@cross2dg.com

PROPERTY INFORMATION

PARCEL#

0869000090 **ADDRESS**

2800 75TH AVE SE, STE 300 MERCER ISLAND, WA 98040

LEGAL DESCRIPTION: QTR: NW SEC: 12 TWP: 24 RGE: 4 LOT: BLK: PBK: SUB: BLUE SKY VISTA

PENTHOUSE OF BLUE SKY VISTA, A CONDOMINIUM, AND USE OF LIMITED COMMON ELEMENTS, IF ANY, RECORDED IN VOLUME 1 OF CONDOMINIUMS, PAGES 25 THROUGH 29, INCLUSIVE, AND ANY AMENDMENTS THERETO, ACCORDING TO THE DECLARATION THEREOF RECORDED UNDER KING COUNTY RECORDING NO. 5837077, AND ANY AMENDMENTS THERETO.

SITUATE IN THE COUNTY OF KING, STATE OF WASHINGTON

PROJECT DESCRIPTION

PARTIAL INTERIOR REMODEL (2,517 SF) OF A SINGLE TENANT PENTHOUSE LEVEL (5,068 SF TOTAL GFA) IN AN EXISTING CONDOMINUM BUILDING. PROJECT INCLUDES RECONFIGURATION OF SPACES WITH NEW KITCHEN, MUDROOM, AND HVAC SYSTEMS. WINDOWS AND DOORS TO BE REPLACED WITH MINOR NON-STRUCTURAL ALTERATIONS TO EXISTING OPENINGS. NEW INTERIOR FURRING AND INSULATION TO BE ADDED AT EXTERIOR WALLS AND ROOF.

BUILDING AREAS

CONDITIONED INTERIOR PENTHOUSE UNIT AREA INTERIOR AREA ELEVATOR SHAFT (NOT IN SCOPE) TOTAL INTERIOR AREA	•	(REMODEL AREA) (NOT IN SCOPE) (NOT IN SCOPE)
UNCONDITIONED EXTERIOR TERRACE EAST SUNROOM ENCLOSED EXTERIOR TERRACE EAST EXTERIOR TERRACE WEST TOTAL EXTEIOR AREA	259 SF 495 SF 412 SF 1,166 SF	(NOT IN SCOPE) (NOT IN SCOPE) (NOT IN SCOPE)

APPLICABLE CODES

GOVERNING CODE 2018 IEBC/IBC 2018 IMC 2018 UPC 2018 IFC 2018 WSEC-R ICC/ANSI A117.1-09

DEFERRED SUBMITTAL LIST

MECHANICAL REVIEWED BY INSPECTOR IN THE FIELD ELECTRICAL/LIGHTING REVIEWED BY INSPECTOR IN THE FIELD PLUMBING REVIEWED BY INSPECTOR IN THE FIELD FIRE ALARM AND SIGNALING UNDER SEPARATE TI PERMIT

FIRE CODE NOTES

MERCER ISLAND FIRE DEPARTMENT COMPLIANCE:

1. DEMOLITION AND CONSTRUCTION SHALL CONFORM TO THE REQUIREMENTS OF INTERNATIONAL FIRE CODE (IFC) CHAPTER 33

2. THE HOME SHALL BE EQUIPPED WITH INTERCONNECTED CARBON MONOXIDE DETECTORS AND SMOKE ALARMS. CARBON MONOXIDE DETECTORS MUST BE INSTALLED OUTSIDE OF EACH SEPARATE SLEEPING AREA AND IN THE IMMEDIATE VICINITY OF THE BEDROOM(S).

ZONING ANALYSIS

SCREENING OF SERVICE AND

MECHANICAL AREAS (MICC 19.12.060)

B.3. METERS AND MECHANICAL UNITS, WATER METERS, GAS METERS, ELECTRIC METERS, GROUND-MOUNTED MECANICAL UNITS AND ANY OTHER SIMILAR STRUCTURES SHOULD BE HIDDEN FROM PUBLIC VIEW OR SCREENED.

206.414.9884 4915 RAINIER AVE S, STE 202 SEATTLE, WA 98118 INFO@FIRSTLAMP.NET

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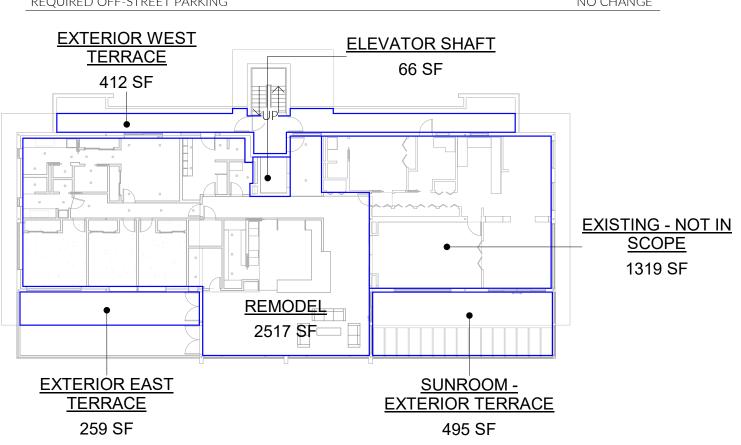
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ZONING SUMMARY

GENERAL

BASE ZONE	MF-2
BUILDING HEIGHT	
MAXIMUM HEIGHT ALLOWED (MICC 19.03.010)	36 FT OR 3 STORIES, + 5 FT APPURTENANCES
EXISTING BUILDING HEIGHT	NO CHANGE
VARDC	
YARDS	00.57
FRONT	20 FT
REAR	25 F7
SIDE	20 FT
LOT COVEDACE	NIO CLIANICE
LOT COVERAGE	NO CHANGE
FLOOR AREA RATIO	NO CHANGE
REQUIRED OFF-STREET PARKING	NO CHANG



2 PENTHOUSE UNIT GROSS FLOOR AREA 1" = 20'-0"



MUNICIPAL APPROVAL STAMPS

PERMIT SET | .04.18.2023

REVISIONS

NO. DESCRIPTION

DRAWN BY:

COVER SHEET

1) INTERIOR PERSPECTIVE 12" = 1'-0"

G 1.0

DOOR SCHEDULE

DOOK SCHEDOLL								
Description	Location	Width	Height	U-Factor	Finish	Comments		
HOUSE								
EXISTING FLUSH PANEL	HALLWAY	3' - 0"	6' - 8"		CLEAR SEALER	EXISTING EXTERIOR DOOR, REFINISH WITH NEW HARDWARE		
DOUBLE GLASS	DINING	6' - 0"	6' - 8"	.65	SPLIT FRAME COLOR, WHITE EXTERIOR/BLACK INTERIOR	EXTERIOR DOOR		
DOUBLE GLASS	EXTERIOR EAST TERRACE	6' - 0"	6' - 8"	.65	SPLIT FRAME COLOR, WHITE EXTERIOR/BLACK INTERIOR	EXTERIOR DOOR		
DOUBLE BARN DOOR	PLAYROOM	4' - 0"	8' - 0"			CUSTOM SALVAGED MIRRORED PANELS		
FLUSH POCKET	KITCHEN	2' - 8"	6' - 8"					
FLUSH PANEL	GUEST RESTROOM	2' - 6"	6' - 8"					
FLUSH PANEL	HALLWAY	2' - 6"	6' - 8"					
FLUSH PANEL	HALLWAY	2' - 6"	6' - 8"					
FULL LITE	MUD ROOM	3' - 0"	6' - 8"	.65	WHITE EXTERIOR & INTERIOR	EXTERIOR DOOR, FROSTED GLASS		
SLIGING GLASS	BEDROOM 1	8' - 0"	6' - 8"	.65	WHITE EXTERIOR & INTERIOR	EXTERIOR DOOR		
FLUSH PANEL	STORAGE	2' - 4"	6' - 8"					
FLUSH POCKET	PRIMARY BATH	2' - 4"	6' - 8"					
SLIGING GLASS	LIVING	6' - 0"	6' - 8"	.65	SPLIT FRAME COLOR, WHITE SUNROOM/BLACK INTERIOR	EXTERIOR DOOR		
BI-PASS FLUSH	CL	5' - 0"	6' - 8"					
FLUSH PANEL	BEDROOM 1	2' - 6"	6' - 8"					
FLUSH POCKET	KIDS BATH	2' - 4"	6' - 8"					
	EXISTING FLUSH PANEL DOUBLE GLASS DOUBLE GLASS DOUBLE BARN DOOR FLUSH POCKET FLUSH PANEL FLUSH PANEL FLUSH PANEL FULL LITE SLIGING GLASS FLUSH PANEL FLUSH POCKET SLIGING GLASS BI-PASS FLUSH FLUSH PANEL	EXISTING FLUSH PANEL HALLWAY DOUBLE GLASS DINING DOUBLE GLASS EXTERIOR EAST TERRACE DOUBLE BARN DOOR PLAYROOM FLUSH POCKET KITCHEN FLUSH PANEL GUEST RESTROOM FLUSH PANEL HALLWAY FLUSH PANEL HALLWAY FULL LITE MUD ROOM SLIGING GLASS BEDROOM 1 FLUSH PANEL STORAGE FLUSH POCKET PRIMARY BATH SLIGING GLASS LIVING BI-PASS FLUSH CL FLUSH PANEL BEDROOM 1	EXISTING FLUSH PANEL HALLWAY 3' - 0" DOUBLE GLASS DINING 6' - 0" DOUBLE GLASS EXTERIOR EAST TERRACE 6' - 0" DOUBLE BARN DOOR PLAYROOM 4' - 0" FLUSH POCKET KITCHEN 2' - 8" FLUSH PANEL GUEST RESTROOM 2' - 6" FLUSH PANEL HALLWAY 2' - 6" FLUSH PANEL HALLWAY 2' - 6" FLUSH PANEL STORAGE 2' - 4" FLUSH PANEL STORAGE 2' - 4" SLIGING GLASS LIVING 6' - 0" BI-PASS FLUSH CL 5' - 0" FLUSH PANEL BEDROOM 1 2' - 6"	OUSE EXISTING FLUSH PANEL HALLWAY 3' - 0" 6' - 8" DOUBLE GLASS DINING 6' - 0" 6' - 8" DOUBLE GLASS EXTERIOR EAST TERRACE 6' - 0" 6' - 8" DOUBLE BARN DOOR PLAYROOM 4' - 0" 8' - 0" FLUSH POCKET KITCHEN 2' - 8" 6' - 8" FLUSH PANEL GUEST RESTROOM 2' - 6" 6' - 8" FLUSH PANEL HALLWAY 2' - 6" 6' - 8" FULL LITE MUD ROOM 3' - 0" 6' - 8" SLIGING GLASS BEDROOM 1 8' - 0" 6' - 8" FLUSH PANEL STORAGE 2' - 4" 6' - 8" FLUSH POCKET PRIMARY BATH 2' - 4" 6' - 8" SLIGING GLASS LIVING 6' - 0" 6' - 8" BI-PASS FLUSH CL 5' - 0" 6' - 8" FLUSH PANEL BEDROOM 1 2' - 6" 6' - 8"	Description Location Width Height U-Factor IOUSE EXISTING FLUSH PANEL HALLWAY 3' - 0" 6' - 8" 65 DOUBLE GLASS DINING 6' - 0" 6' - 8" .65 DOUBLE GLASS EXTERIOR EAST TERRACE 6' - 0" 6' - 8" .65 DOUBLE BARN DOOR PLAYROOM 4' - 0" 8' - 0" 6' - 8" FLUSH POCKET KITCHEN 2' - 8" 6' - 8" FLUSH PANEL HALLWAY 2' - 6" 6' - 8" FLUSH PANEL HALLWAY 2' - 6" 6' - 8" .65 SLIGING GLASS BEDROOM 1 8' - 0" 6' - 8" .65 FLUSH PANEL STORAGE 2' - 4" 6' - 8" .65 FLUSH POCKET PRIMARY BATH 2' - 4" 6' - 8" .65 SLIGING GLASS LIVING 6' - 0" 6' - 8" .65 BI-PASS FLUSH CL 5' - 0" 6' - 8" .65 FLUSH PANEL BEDROOM 1 2' - 6" 6' - 8" .65	Description Location Width Height U-Factor Finish OUSE EXISTING FLUSH PANEL HALLWAY 3' - 0" 6' - 8" CLEAR SEALER DOUBLE GLASS DINING 6' - 0" 6' - 8" .65 SPLIT FRAME COLOR, WHITE EXTERIOR/BLACK INTERIOR DOUBLE GLASS EXTERIOR EAST TERRACE 6' - 0" 6' - 8" .65 SPLIT FRAME COLOR, WHITE EXTERIOR/BLACK INTERIOR DOUBLE BARN DOOR PLAYROOM 4' - 0" 8' - 0" FLUSH POCKET KITCHEN 2' - 8" 6' - 8" FLUSH PANEL GUEST RESTROOM 2' - 6" 6' - 8" FLUSH PANEL HALLWAY 2' - 6" 6' - 8" FUSH PANEL HALLWAY 2' - 6" 6' - 8" FULL LITE MUD ROOM 3' - 0" 6' - 8" .65 WHITE EXTERIOR & INTERIOR SLIGING GLASS BEDROOM 1 8' - 0" 6' - 8" .65 WHITE EXTERIOR & INTERIOR SLIGING GLASS BEDROOM 1 8' - 0" 6' - 8" .65 WHITE EXTERIOR & INTERIOR SLIGING GLASS LIVING 6' - 0" 6' - 8" .65 SPLIT FRAME COLOR, WHITE SUNROOM/BLACK INTERIOR BI-PASS FLUSH CL 5' - 0" 6' - 8" .65 SPLIT FRAME COLOR, WHITE SUNROOM/BLACK INTERIOR BI-PASS FLUSH CL 5' - 0" 6' - 8" .65 SPLIT FRAME COLOR, WHITE SUNROOM/BLACK INTERIOR BI-PASS FLUSH CL 5' - 0" 6' - 8" .65 SPLIT FRAME COLOR, WHITE SUNROOM/BLACK INTERIOR BI-PASS FLUSH CL 5' - 0" 6' - 8" .65 SPLIT FRAME COLOR, WHITE SUNROOM/BLACK INTERIOR BI-PASS FLUSH CL 5' - 0" 6' - 8" .65 SPLIT FRAME COLOR, WHITE SUNROOM/BLACK INTERIOR BI-PASS FLUSH CL 5' - 0" 6' - 8" .65 SPLIT FRAME COLOR, WHITE SUNROOM/BLACK INTERIOR BI-PASS FLUSH CL 5' - 0" 6' - 8" .65 SPLIT FRAME COLOR, WHITE SUNROOM/BLACK INTERIOR BI-PASS FLUSH CL 5' - 0" 6' - 8" .65 SPLIT FRAME COLOR, WHITE SUNROOM/BLACK INTERIOR BI-PASS FLUSH CL 5' - 0" 6' - 8" .65 SPLIT FRAME COLOR, WHITE SUNROOM/BLACK INTERIOR BI-PASS FLUSH CL 5' - 0" 6' - 8" .65 SPLIT FRAME COLOR, WHITE SUNROOM/BLACK INTERIOR BI-PASS FLUSH CL 5' - 0" 6' - 8" .65 SPLIT FRAME COLOR, WHITE SUNROOM/BLACK INTERIOR		

DOOR NOTES:

FLUSH PANEL

FLUSH PANEL

BI-PASS FLUSH

BI-PASS FLUSH

FLUSH PANEL

FLUSH PANEL

BI-PASS FLUSH

FLUSH PANEL

FLUSH PANEL

FLUSH POCKET

FLUSH POCKET

FLUSH POCKE

BI-PASS FLUSH

R-49

R-21

R-10

1. PLEASE REFER TO PLANS AND ELEVATIONS FOR OPERATION AND GLAZING TYPE 2. ALL DOORS IN PLANE WITH ADJACENT DOORS OR WINDOWS ARE INTENDED TO HAVE THE HEADERS

KIDS BATH

EXERCISE ROOM

EXERCISE ROOM

BEDROOM 2

BEDROOM 2

HALLWAY

HALLWAY

KITCHEN

MECH ROOM

BEDROOM 1

ALIGNED; UON. PLEASE NOTIFY ARCHITECT IF THERE IS A DISCREPENCY IN HEADER HEIGHTS OR ALIGNMENTS.

	WINDOW SCHEDULE									
Plan Tag	Count	Level	Operation	NFRC U-VAL	Comments	Width	Height	Sill Height	Head Height	
А	4	LEVEL 3 - PENTHOUSE	Fixed	.30	VINYL FRAME	6' - 0"	2' - 6"	9' - 10"	12' - 4"	
В	6	LEVEL 3 - PENTHOUSE	Fixed	.30	VINYL FRAME	2' - 9"	2' - 6"	9' - 10"	12' - 4"	
С	2	LEVEL 3 - PENTHOUSE	Fixed	.30	VINYL FRAME	3' - 3"	2' - 6"	9' - 10"	12' - 4"	
D	3	LEVEL 3 - PENTHOUSE	Fixed	.30	VINYL FRAME	4' - 9"	2' - 6"	9' - 10"	12' - 4"	
Е	2	LEVEL 3 - PENTHOUSE	Fixed	.30	VINYL FRAME	5' - 10"	4' - 6"	2' - 0"	6' - 6"	
F	1	LEVEL 3 - PENTHOUSE	Fixed	.30	VINYL FRAME	2' - 0"	4' - 6"	2' - 0"	6' - 6"	
\.\.\.\.\.\.\.\.\.\.\.\.\.\.\.\.\.\.\.				•		<u> </u>	<u>'</u>			

2' - 4" 6' - 8"

5' - 0" 6' - 8"

2' - 6" 6' - 8"

2' - 6" 6' - 8"

3' - 4" 6' - 8"

2' - 4" 6' - 8"

6' - 0" 6' - 8"

2' - 6"

2' - 6"

6' - 8"

6' - 8"

6' - 8"

WINDOW NOTES:

1. PLEASE REFER TO ELEVATIONS ON SHEET A3.0 & A6.0 FOR OPERATION, MULLING, AND SAFETY GLAZING. 2. ALL WINDOWS IN PLANE WITH ADJACENT DOORS OR WINDOWS ARE INTENDED TO HAVE THE HEADERS ALIGNED; UON. PLEASE NOTIFY

ARCHITECT IF THERE IS A DISCREPENCY IN HEADER HEIGHTS OR ALIGNMENTS.

3. EGRESS WINDOWS BELOW 36" A.F.F. ARE REQUIRED TO BE PROVIDED WITH OPENING CONTROL DEVICES COMPLYING WITH SBC 1013.8.1. (EXCEPTOIN 4)

GLAZING SCHEDULE

<u> </u>						
TYPE	MANUFACTURER	PRODUCT	DESCRIPTION	U-FACTOR	SHGC	VT
1	TBD	TBD	THERMALLY BROKEN ALUMINUM STOREFRONT SYSTEM AND DOORS WITH DOUBLE PANE LOW-E ARGON FILLED INSULTAED GLAZING UNIT, TYPICAL	.65	.70	.60

NOTES:

1. THERMALLY BROKEN ALUMINUM STOREFRONT SYSTEM, IGUS, AND GLASS DOOR PERFOAMANCE VALUES PER R303.1.3. FENESTRATION PRODUCT RATING. FINAL STOREFRONT AND DOOR SYSTEM SPECIFICATION TO SUBMIT NFRC CERTIFICATION COMPLIANT WITH MINIMUM PERFORMANCE REQUIREMENTS.

TYPE III (PERMITTED IN 1964) **REQUIREMENTS** TYPE IIIB (UNDER 2018 IBC) VERTICAL FENESTRATION U-FACTOR FIRE PROTECTION: 901.4.3 FOR ANY ALTERATION WITHIN A BUILDING OR STRUCTURE, SLAB WOOD DOOR (NO GLAZING) U-FACTOR THE FIRE PROTECTION AND LIFE SAFETY SYSTEMS SHALL BE CEILING EXTENDED ALTERED OR AUGMENTED TO MAINTAIN AND CONTINIUE WALL - ABOVE GRADE PROTECTION WITHIN THE BUILDING OR STRUCTURE. PERSONS SHALL STRUCTURAL HEADERS NOT REMOVE OR MODIEY ANY FIRE PROTECTION OR LIFE SAFETY SYSTEM INSTALLED OR MAINTAINED UNDER THE PROVISIONS OF THIS CODE WITHOUT APPROVAL BY THE FIRE CODE OFFICIAL. ADDITIONAL ENERGY NOTES FIRE ALARM SYSTEM: FIRE ALARM SYSTEM PER NFPA 72 AND IFC SECTION 907.9. TENANT IMPROVEMENT TO BE SUBMITTED UNDER SEPARATE PERMIT 1. A RESIDENTIAL ENERGY COMPLIANCE CERTIFICATE COMPLYING WITH HORIZONTAL BUILDING WSEC R401.3 IS REQUIRED TO BE COMPLETED BY THE DESIGN SEPARATEION: 420.3 HORIZONTAL SEPARATION. FLOOR ASSEMBLIES SEPARATING PROFESSIONAL OR BUILDER AND PERMANENTLY POSTED WITHIN 3' OF THE DWELLING UNITS IN THE SAME BUILDING, FLOOR ASSEMBLIES ELECTRICAL PANEL PRIOR TO FINAL INSPECTION. SEPARATING SLEEPING UNITS IN THE SAME BUILDING AND FLOOR ASSEMBLIES SEPARATING DWELLING OR SLEEPING UNITS FROM 2. EACH DWELLING UNIT IS REQUIRED TO BE PROVIDED WITH AT LEAST ONE OTHER OCCUPANCIES CONTIGUOUS TO THEM IN THE SAME PROGRAMMABLE THERMOSTAT FOR THE REGULATION OF TEMPERATURE. BUILDING SHALL BE CONSTRUCTED AS HORIZONTAL ASSEMBLIES IN ACCORDANCE WITH SECTION 711. 3. A MINIMUM OF 90 PERCENT OF PERMANENTLY INSTALLED LAMPS IN LIGHTING FIXTURES SHALL BE HIGH-EFFICACY LAMPS. ALLOWABLE BUILDING HEIGHT AND AREA 4. U-FACTORS OF WINDOWS, DOORS AND SKYLIGHTS SHALL BE CALCULATION: NO CHANGE TO EXISTING DETERMINED IN ACCORDANCE WITH NFRC 100 AND SHALL BE LABELED AS SUCH FROM THE MANUFACTURER. CONSTRUCTION TYPE IIIB & OCCUPANCY R2: NO CHANGE TO EXISTING 5. R503.1.2 HEATING AND COOLING SYSTEMS. NEW HEATING, COOLING AND DUCT SYSTEMS THAT ARE PART OF THE ALTERATION SHALL COMPLY WITH ALLOWABEL BUILDING SECTIONS R403.1, R403.2, R403.3 AND R403.6. HEIGHT: NO CHANGE TO EXISTING BUILDING AREA: NO CHANGE TO EXISTING **INSULATION INSTALLATION NOTES** AVERAGE GRADE PLANE: NO CHANGE TO EXISTING USE BY LEVEL: NO CHANGE TO EXISTING RECESSED LIGHTING PARKING GARAGE, STORAGE, SERVICE BASEMENT LEVEL 1 APARTMENT 1. RECESSED LIGHTING FIXTURES INSTALLED IN THE BUILDING'S THERMAL LEVEL 2 APARTMENT ENVELOPE SHALL BE TYPE IC RATED UNDER ASTM E283 AS HAVING AN AIR LEVEL 3 APARTMENT LEAKAGE RATE OF NOT MORE THAN 2.0CFM WHEN TESTED AT 75PA AND ROOF ROOF SHALL HAVE A LABEL DEMONSTRATING THIS STANDARD. FIRE RESISTANCE: FIRE RESISTANCE REQUIREMENTS 2. ALL RECESSED FIXTURES SHALL BE SEALED WITH A GASKET OR CAULK PER IBC TABLE 601 TYPE IIIB BETWEEN THE HOUSING AND THE INTERIOR WALL OR CEILING COVERING. PRIMARY STRUCTURAL FRAME BEARING WALLS WALLS EXTERIOR INTERIOR 1. WALL, DOOR, AND WINDOW HEADERS SHALL BE INSULATED TO A VALUE NON-BEARING WALLS AND PARTITIONS EXTERIOR (BASED ON FIRE SEPARATION) X<30' X>/=30' INTERIOR

NO CHANGE TO EXISTING PENTHOUSE OCCUPANCY

S-1 STORAGE - IBC 311.2 MODERATE-HAZARD STORAGE S-2 PARKING GARAGE - IBC 311.3 LOW-HAZARD STORAGE

ACCESSORY OR ANCILLARY USES IBC

NO CHANGE TO EXISTING

FLOOR CONSTRUCTION

ROOF CONSTRUCTION

0-X<3' 3'-X<5'

5'-X<10'

10'-X<15'

15'-X<20'

20'-X<25'

25'-X<30'

30'<X

ALLOWABLE UNPROTECTED OPENINGS

IBC TABLE 705.8 - UNPROTECTED, NONSPRINKLED BUILDINGS

NOT PERMITTED

NOT PERMITTED

10% MAX OPENING

15% MAX OPENING

25% MAX OPENING

45% MAX OPENING

70% MAX OPENING

NO LIMIT

BUILDING CODE COMPLIANCE


PER IBC 2018 WA STATE AND MERCER ISLAND AMENDMENTS


R-2 APARTMENT

OCCUPANCY GROUP:

CONSTRUCTION TYPE:

FIRE SEPARATION DISTANCES:

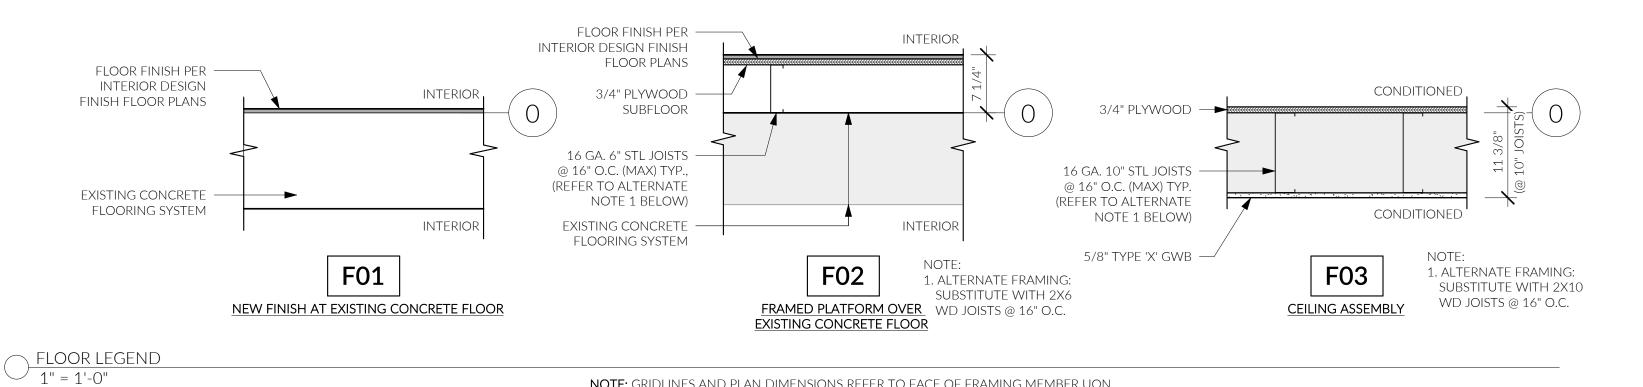

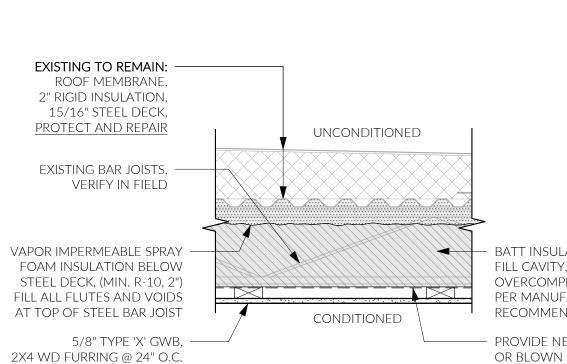

CONDITIONED 3-5/8" 25 GA. STL STUDS @ -■ EXISTING 2-HOUR RATED 24" O.C. (MAX) TYP., EXCEPT

18 GA. STL STUDS @ 24" O.C. (MAX) AT PARTIAL HEIGHT WALLS WITH OPENINGS 5/8" TYPE 'X' GWB — 2" RIGID INSULATION, R-10 MIN., TAPE SEAMS AND CONTINUOUS SEALANT AT PERIMETER, TYPICAL BATT INSULATION IN

*EXISTING ASSEMBLY INFORMATION FROM 6 1/4" 8 5/8" APPROVED PERMIT DRAWINGS DATED 1964 STUD CAVITY, R-15 EXISTING 2-HR

NOTED ON PLANS NOTE: NON-RATED INTERIOR PARTITION AT EXISTING 2-HOUR FIRE RATED EXTERIOR CMU WALL

6" 25 GA. STL STUDS @ 24" O.C. (MAX) TYP., EXCEPT 18 GA. STL STUDS @ 24" O.C. (MAX) AT PARTIAL HEIGHT WALLS WITH OPENINGS (REFER TO ALTERNATE NOTE 1 BELOW) 5/8" TYPE 'X' GWB , BOTH SIDES PLUMBING WHERE OCCURS; CENTER PIPE ON WALL; WRAP W/ 1" THICK INSUL. BTWN PIPE AND GWB SOUND INSULATION WHERE NOTED ON PLANS 1. ALTERNATE FRAMING: SUBSTITUTE WITH 2X4 WD STUDS @ 16" O.C.

CONDITIONED UNCONDITIONED 3-5/8" 25 GA. STL STUDS @ 24" O.C. (MAX) TYP., EXCEPT 18 GA. STL STUDS @ 24" O.C. (MAX) AT PARTIAL HEIGHT WALLS WITH OPENINGS 5/8" TYPE 'X' GWB -RIGID INSULATION, (R-10, 2"), TAPE SEAMS AND SEALANT AT PERIMETER, TYPICAL BATT INSULATION IN STUD CAVITY, (R-21, 5.5")

EXTERIOR INFLL WALL AT CMU

W/ STUCCO FINISH

NEW NON-BEARING INFILL 6" CMU WALL MATCH EXISTING CEMENTITIOUS STUCCO FINISH CUT BACK EXISTING STUCCO TO EXPOSE WRB. LAP EXISTING WRB OVER NEW WRB. PROVIDE STUCCO CONTROL JOINTS AT TRANSITION FROM NEW TO OLD STUCCO

5/8" GWB → VAPOR -BARRIER PER CONTRACTOR R-21 INSUL, MIN. — 6" 25 GA. STL STUDS @ 24" O.C. (MAX) TYP., EXCEPT 18 GA. STL STUDS @ 24" O.C. (MAX) AT PARTIAL HEIGHT WALLS

◆── STUCCO FINISH TO MATCH EXISTING, TYP. - METAL LATH PER STUCCO INSTALLER SHEATHING WITH OPENINGS (REFER TO ALTERNATE NOTE 1 BELOW)

EXTERIOR INFLL WALL AT METAL FRAMING

W/ STUCCO FINISH

UNCONDITIONED SIDE

DRAWN BY:

WINDOW & DOOR SCH, ENERGY & MECH CODE NOTES, **ASSEMBLIES**

MUNICIPAL APPROVAL STAMPS

NO. DESCRIPTION

PERMIT SET | 04.18.2023

REVISIONS

MD

NOTE: GRIDLINES AND PLAN DIMENSIONS REFER TO FACE OF FRAMING MEMBER UON.

UNCONDITIONED

<u>ASSEMBLY</u>

EXTERIOR FULLY

GROUTED AND

REINFORCED CMU BLOCK

WALL WITH EXTERIOR

CEMENTITIOUS STUCCO

ENERGY CODE COMPLIANCE


TO THE 2018 WASHINGTON STATE ENERGY CODE

COMPLIANCE PATH: PRESCRIPTIVE - R402.1.1

CLIMATE:

PER R503 - ALL NEW / ALTERED OR RENOVATED PORTIONS SHALL CONFORM

APPLICABLE CODE: 2018 WASHINGTON STATE RESIDENTIAL ENERGY CODE

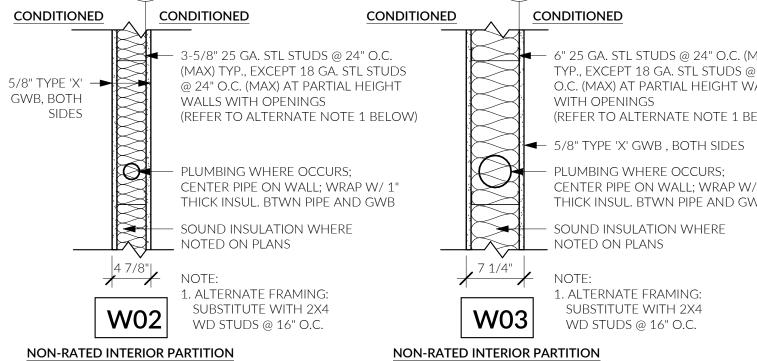

NOTE: GRIDLINES AND PLAN DIMENSIONS REFER TO FACE OF FRAMING MEMBER UON.

BATT INSULATION (R-20, 8"), FILL CAVITY, DO NOT OVERCOMPRESS, INSTALL PER MANUFACTURERS RECOMMENDATIONS PROVIDE NETTING AT LOOSE FILL


OR BLOWN IN INSULATION, TYP.


EXISTING ROOF ASSEMBLY (UNVENTED),


NEW INTERIOR FINISH AND INSULATION ROOF LEGEND


NOTE: GRIDLINES AND PLAN DIMENSIONS REFER TO FACE OF FRAMING MEMBER UON.

NON-RATED INTERIOR FURRING WALL

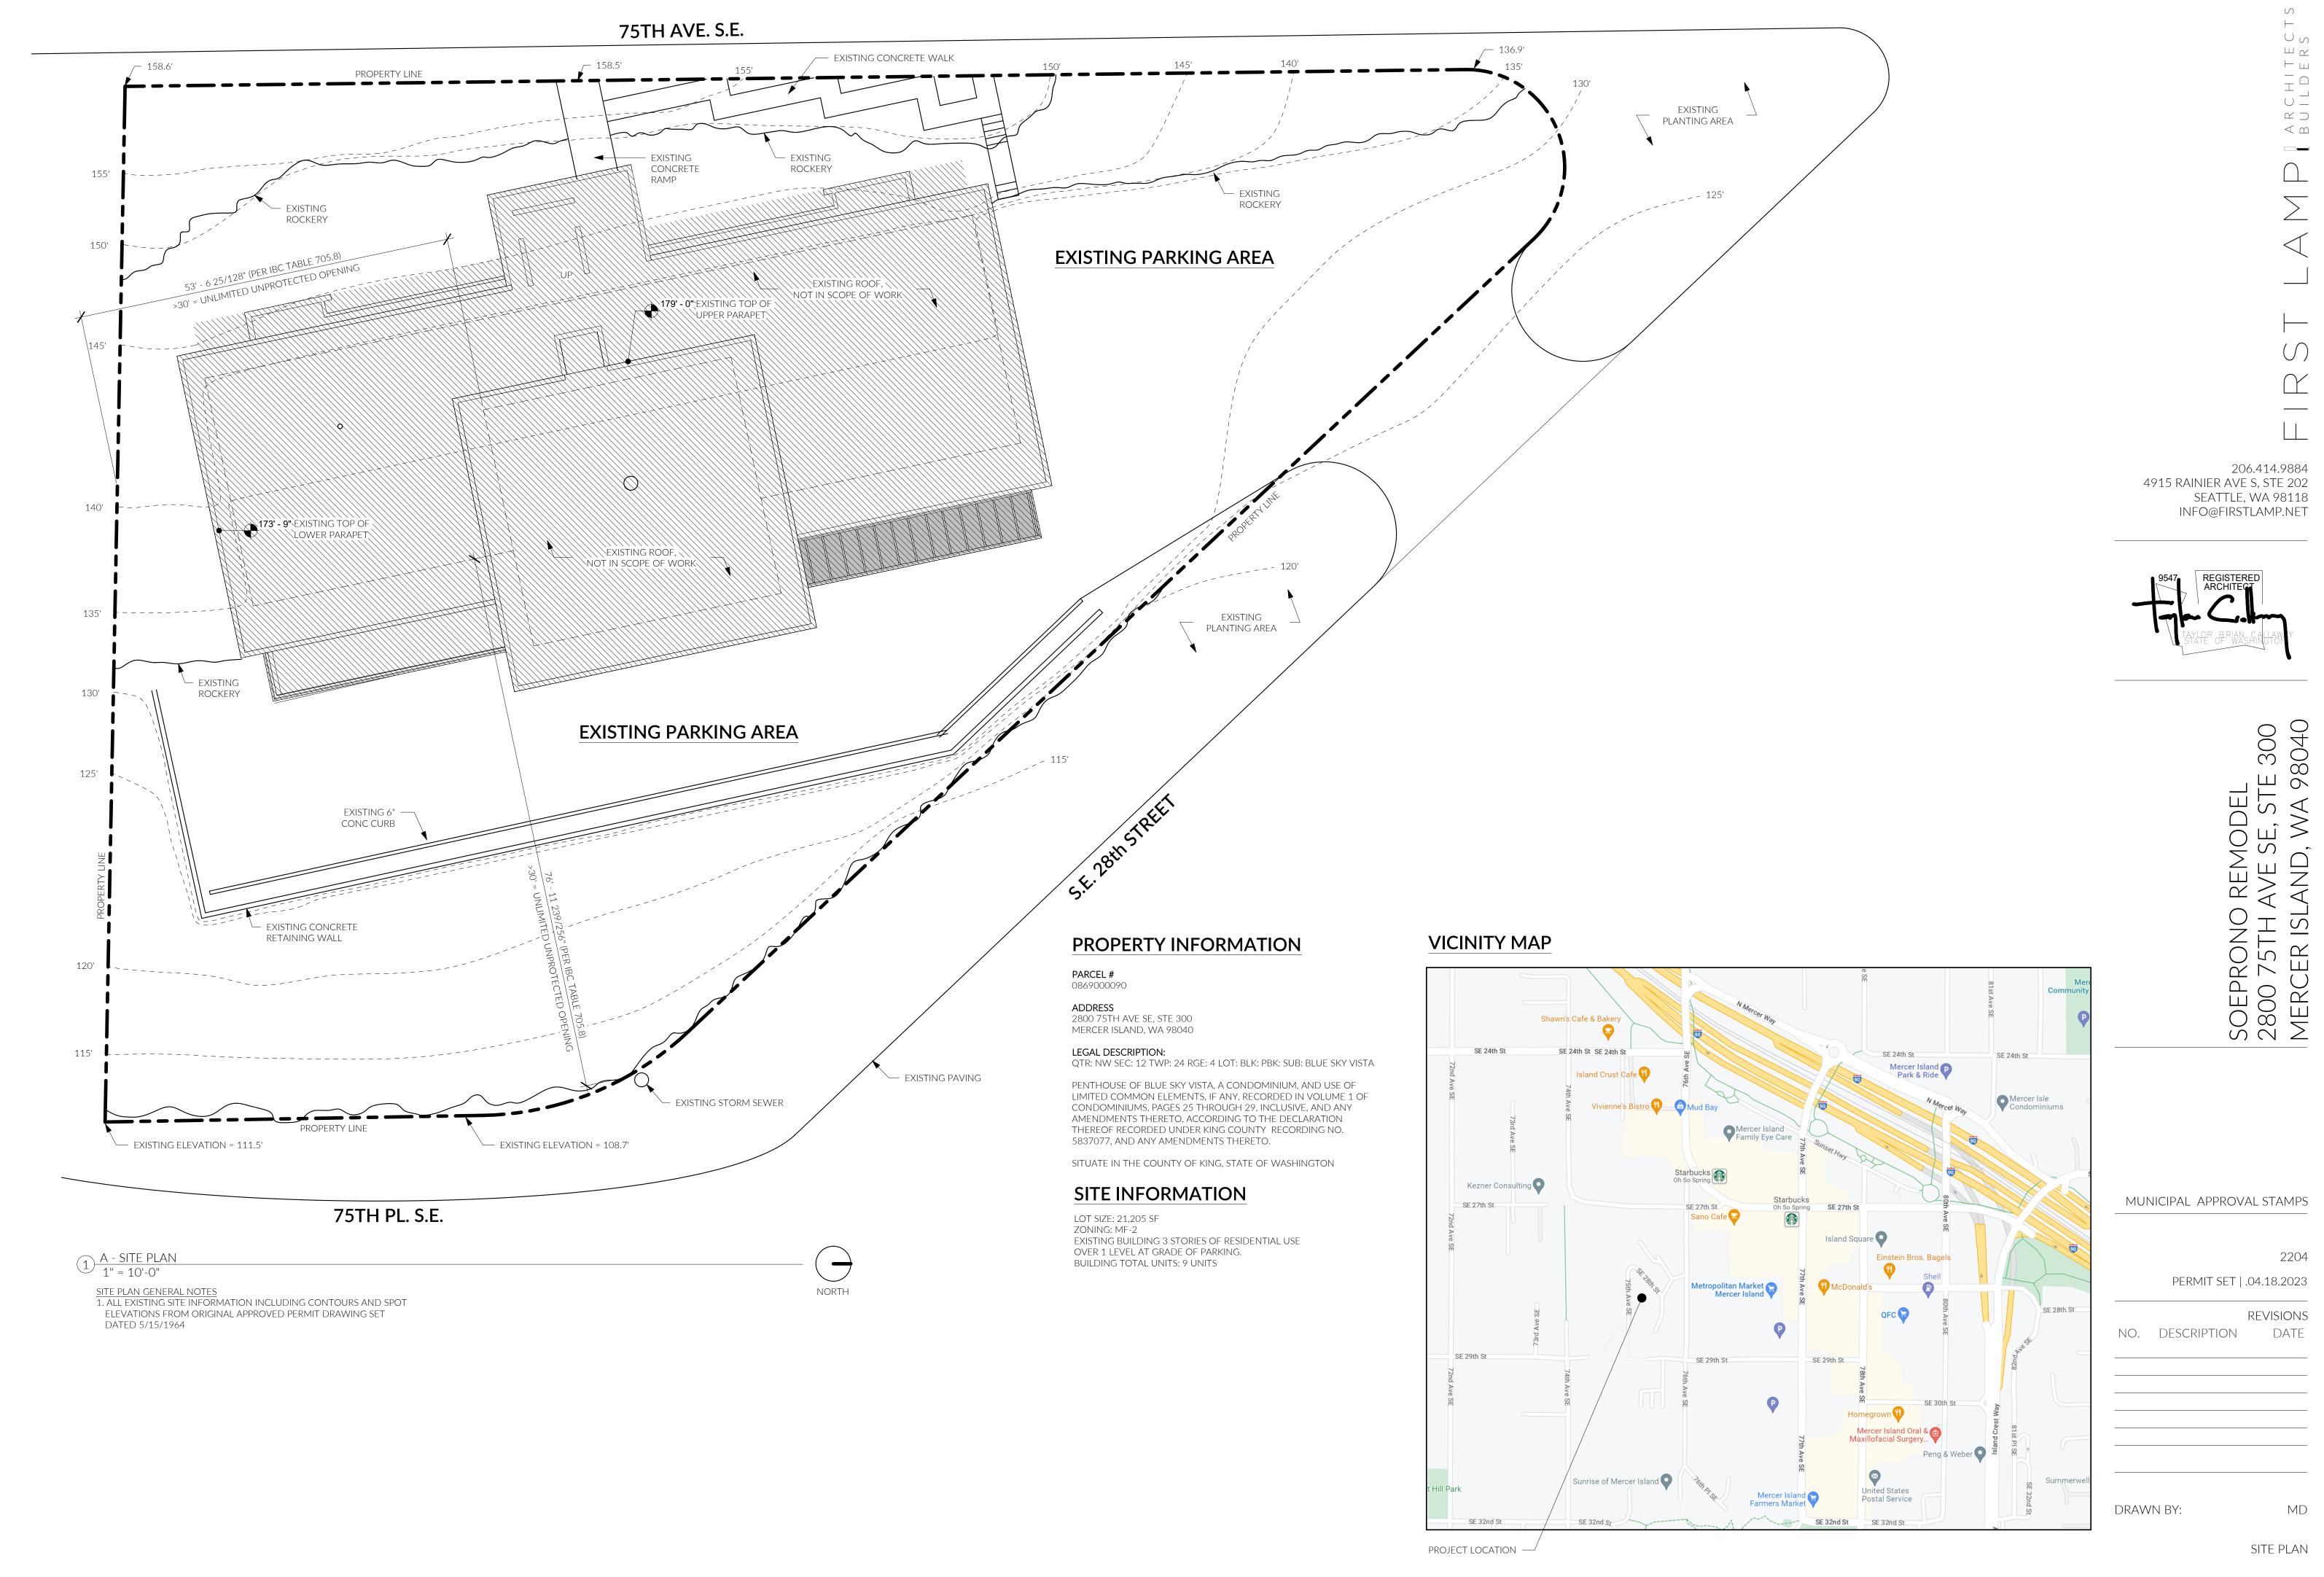

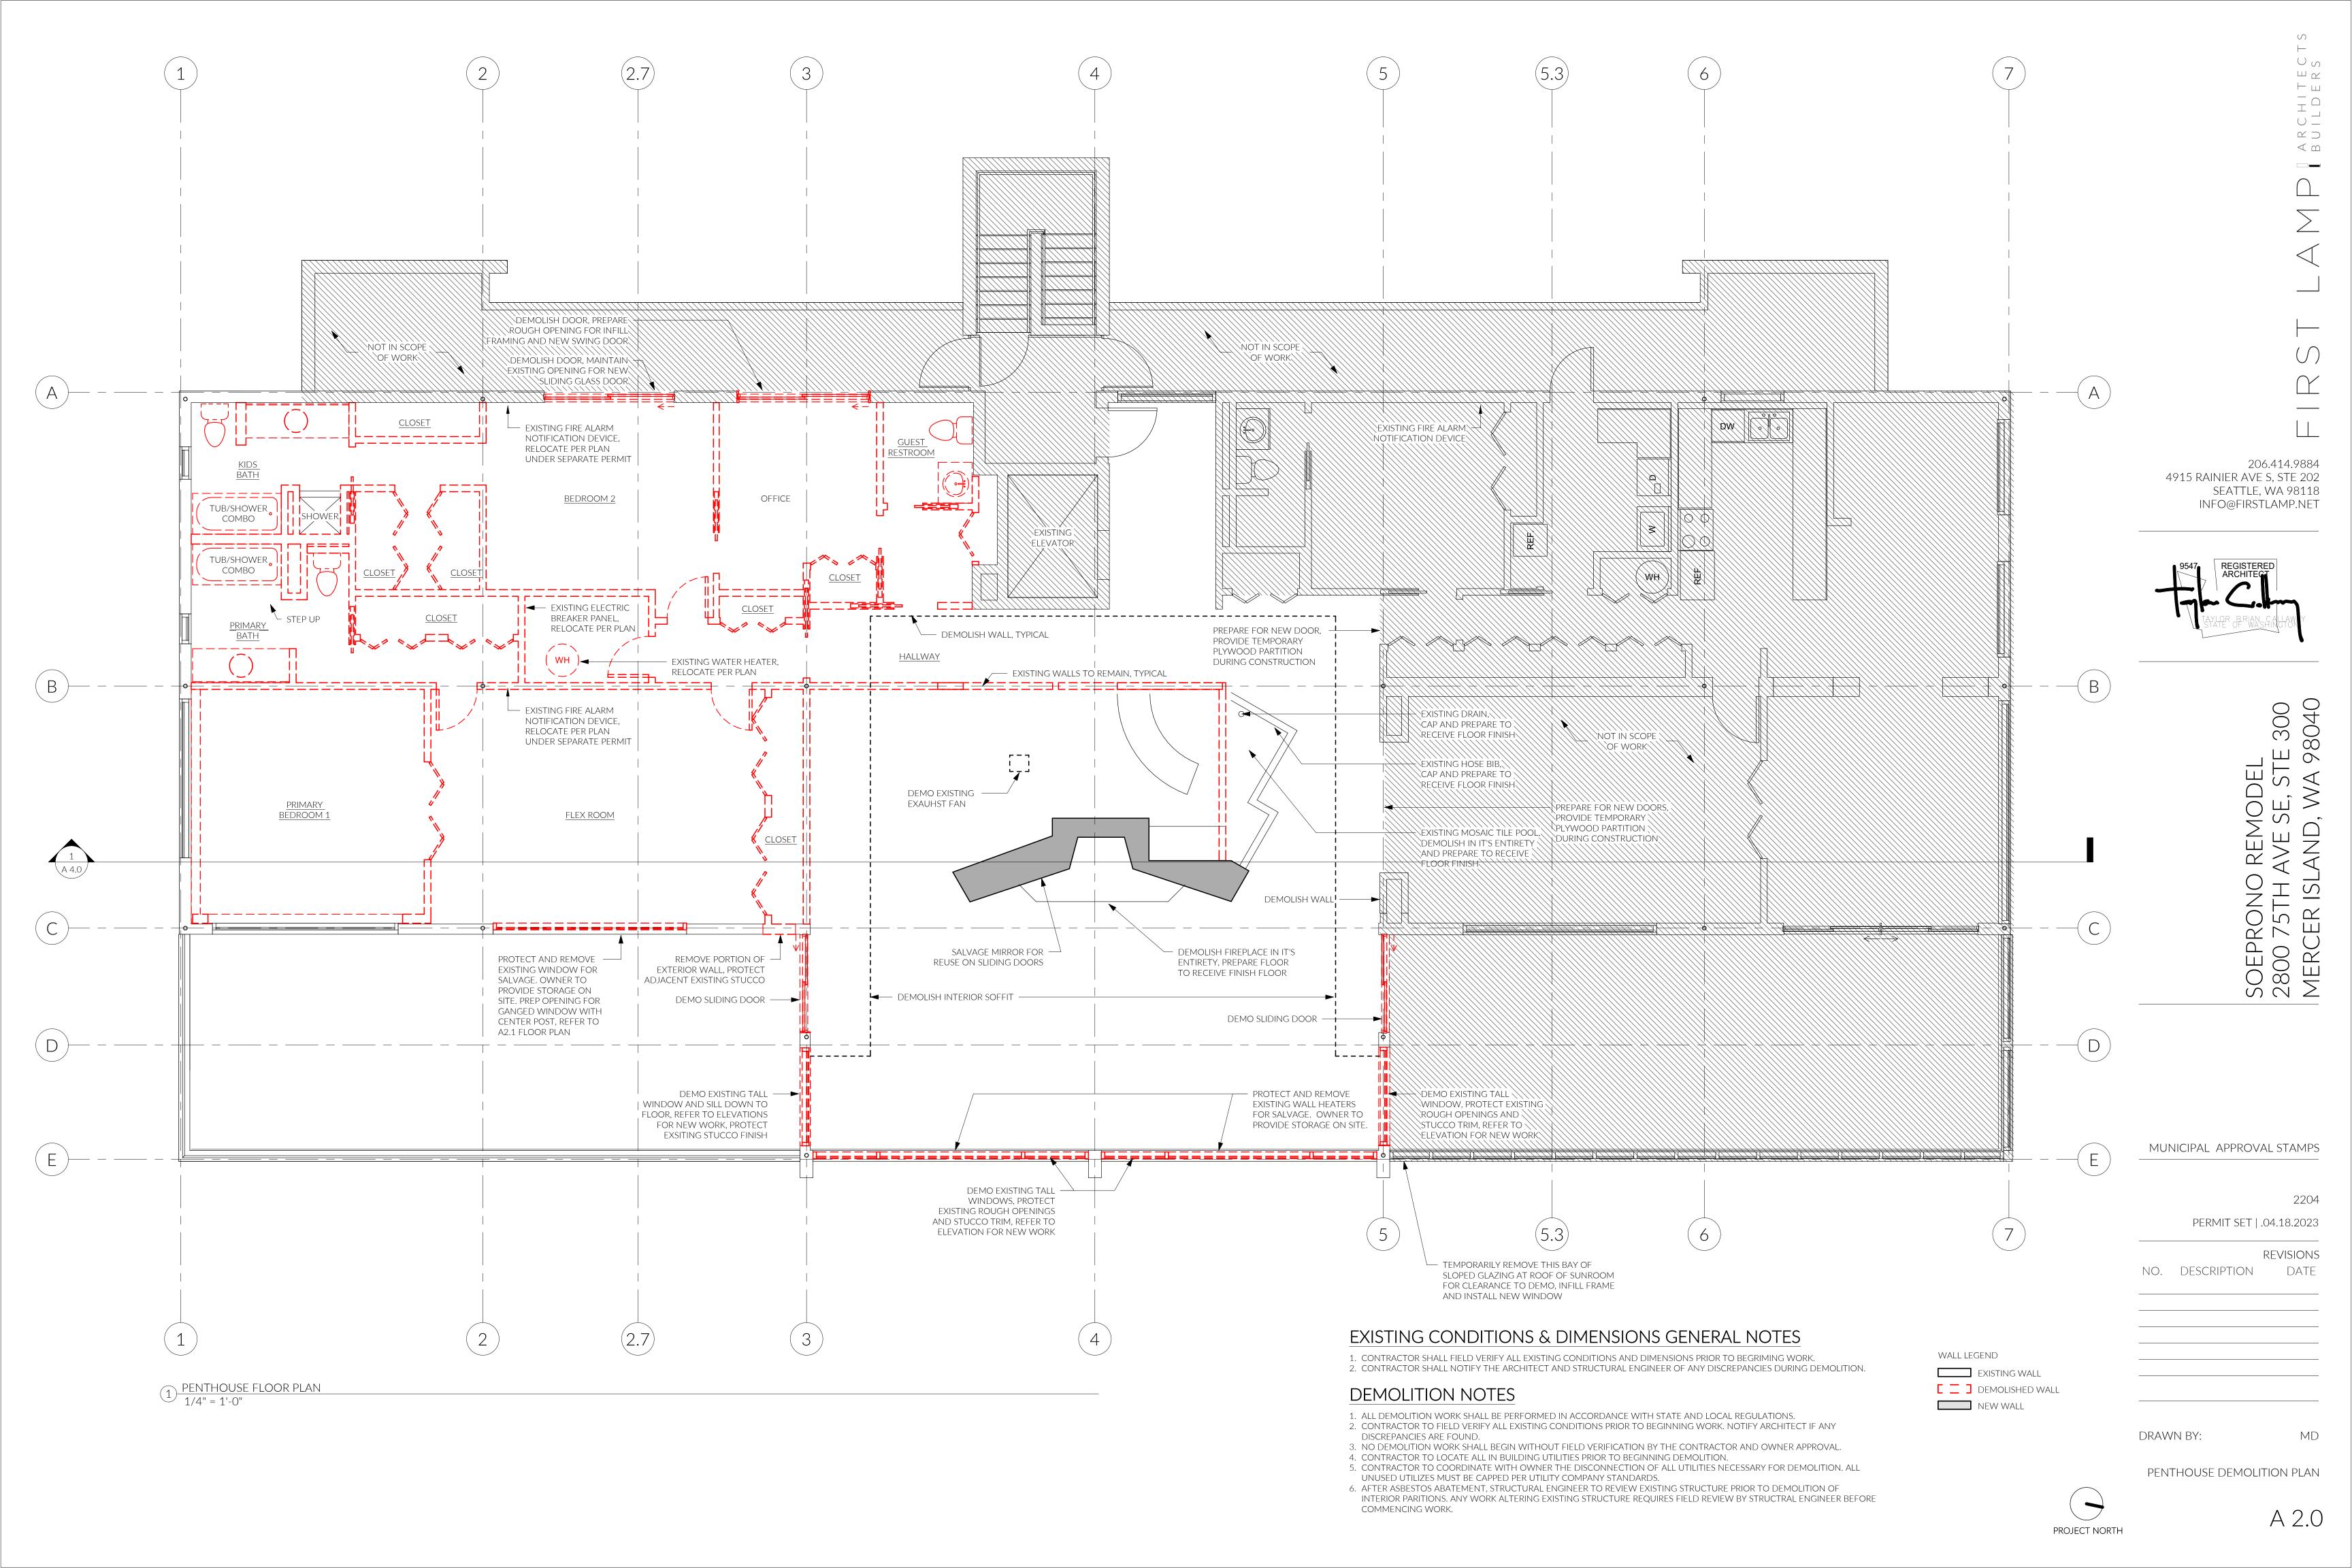


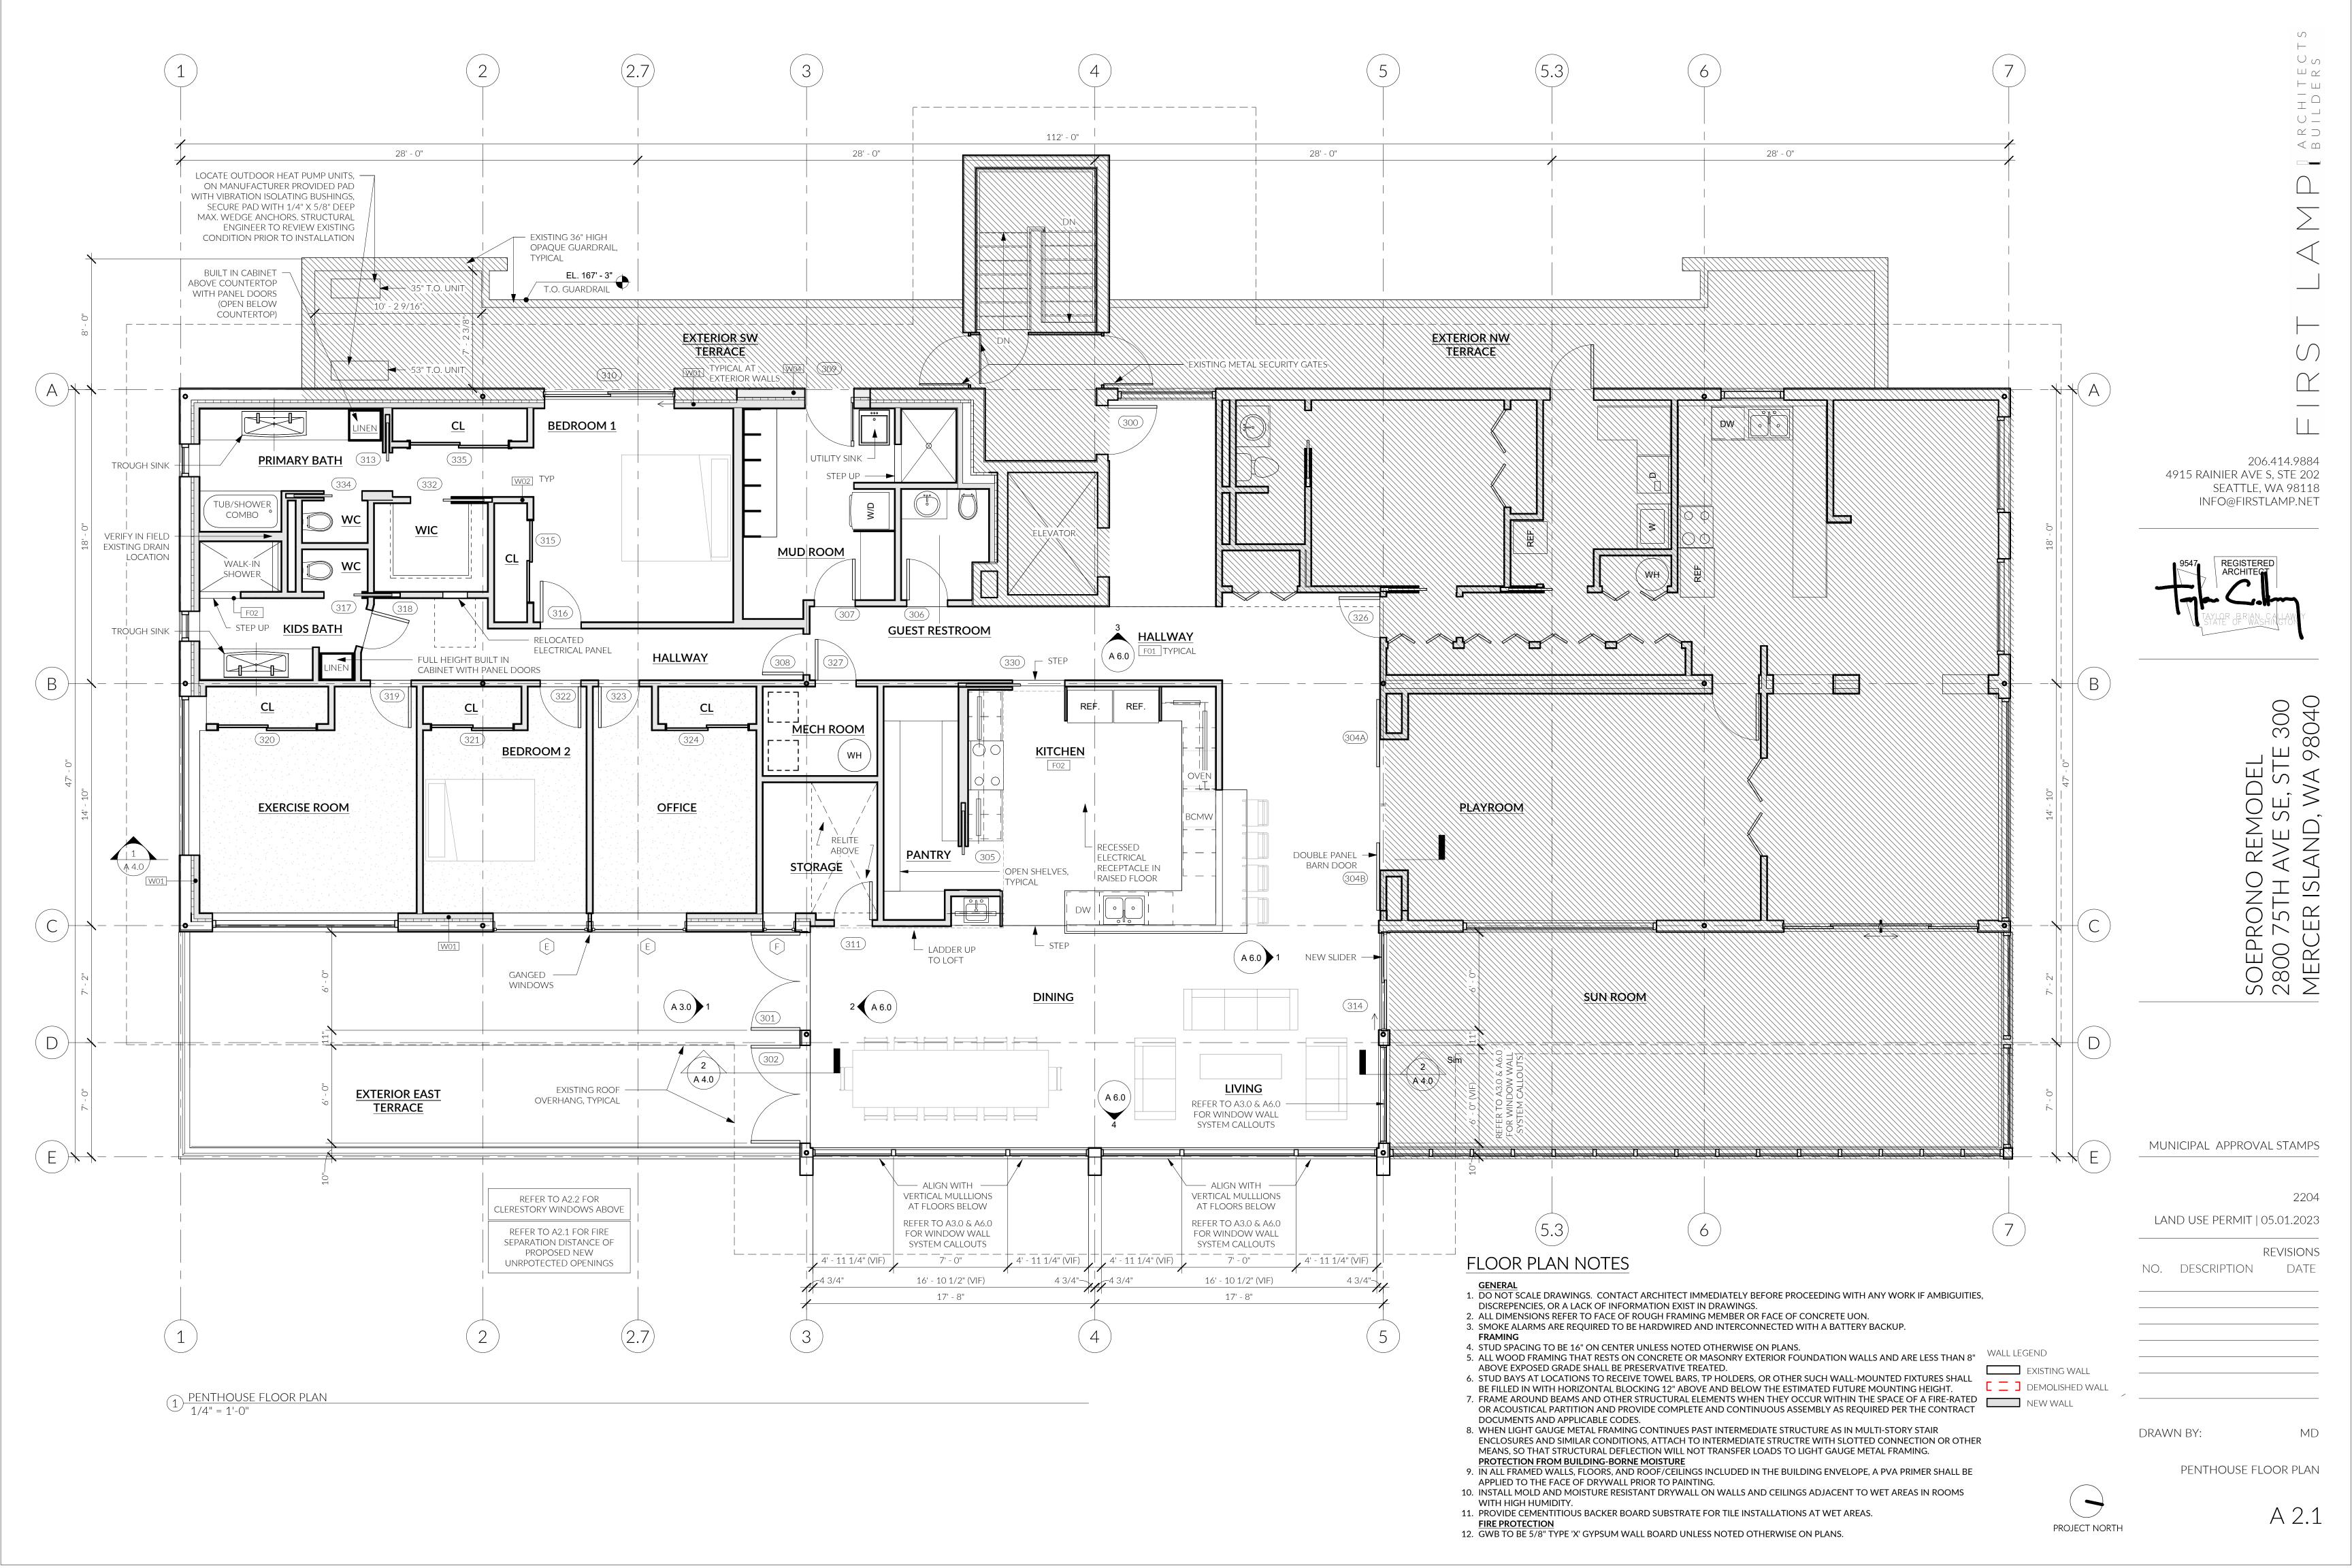

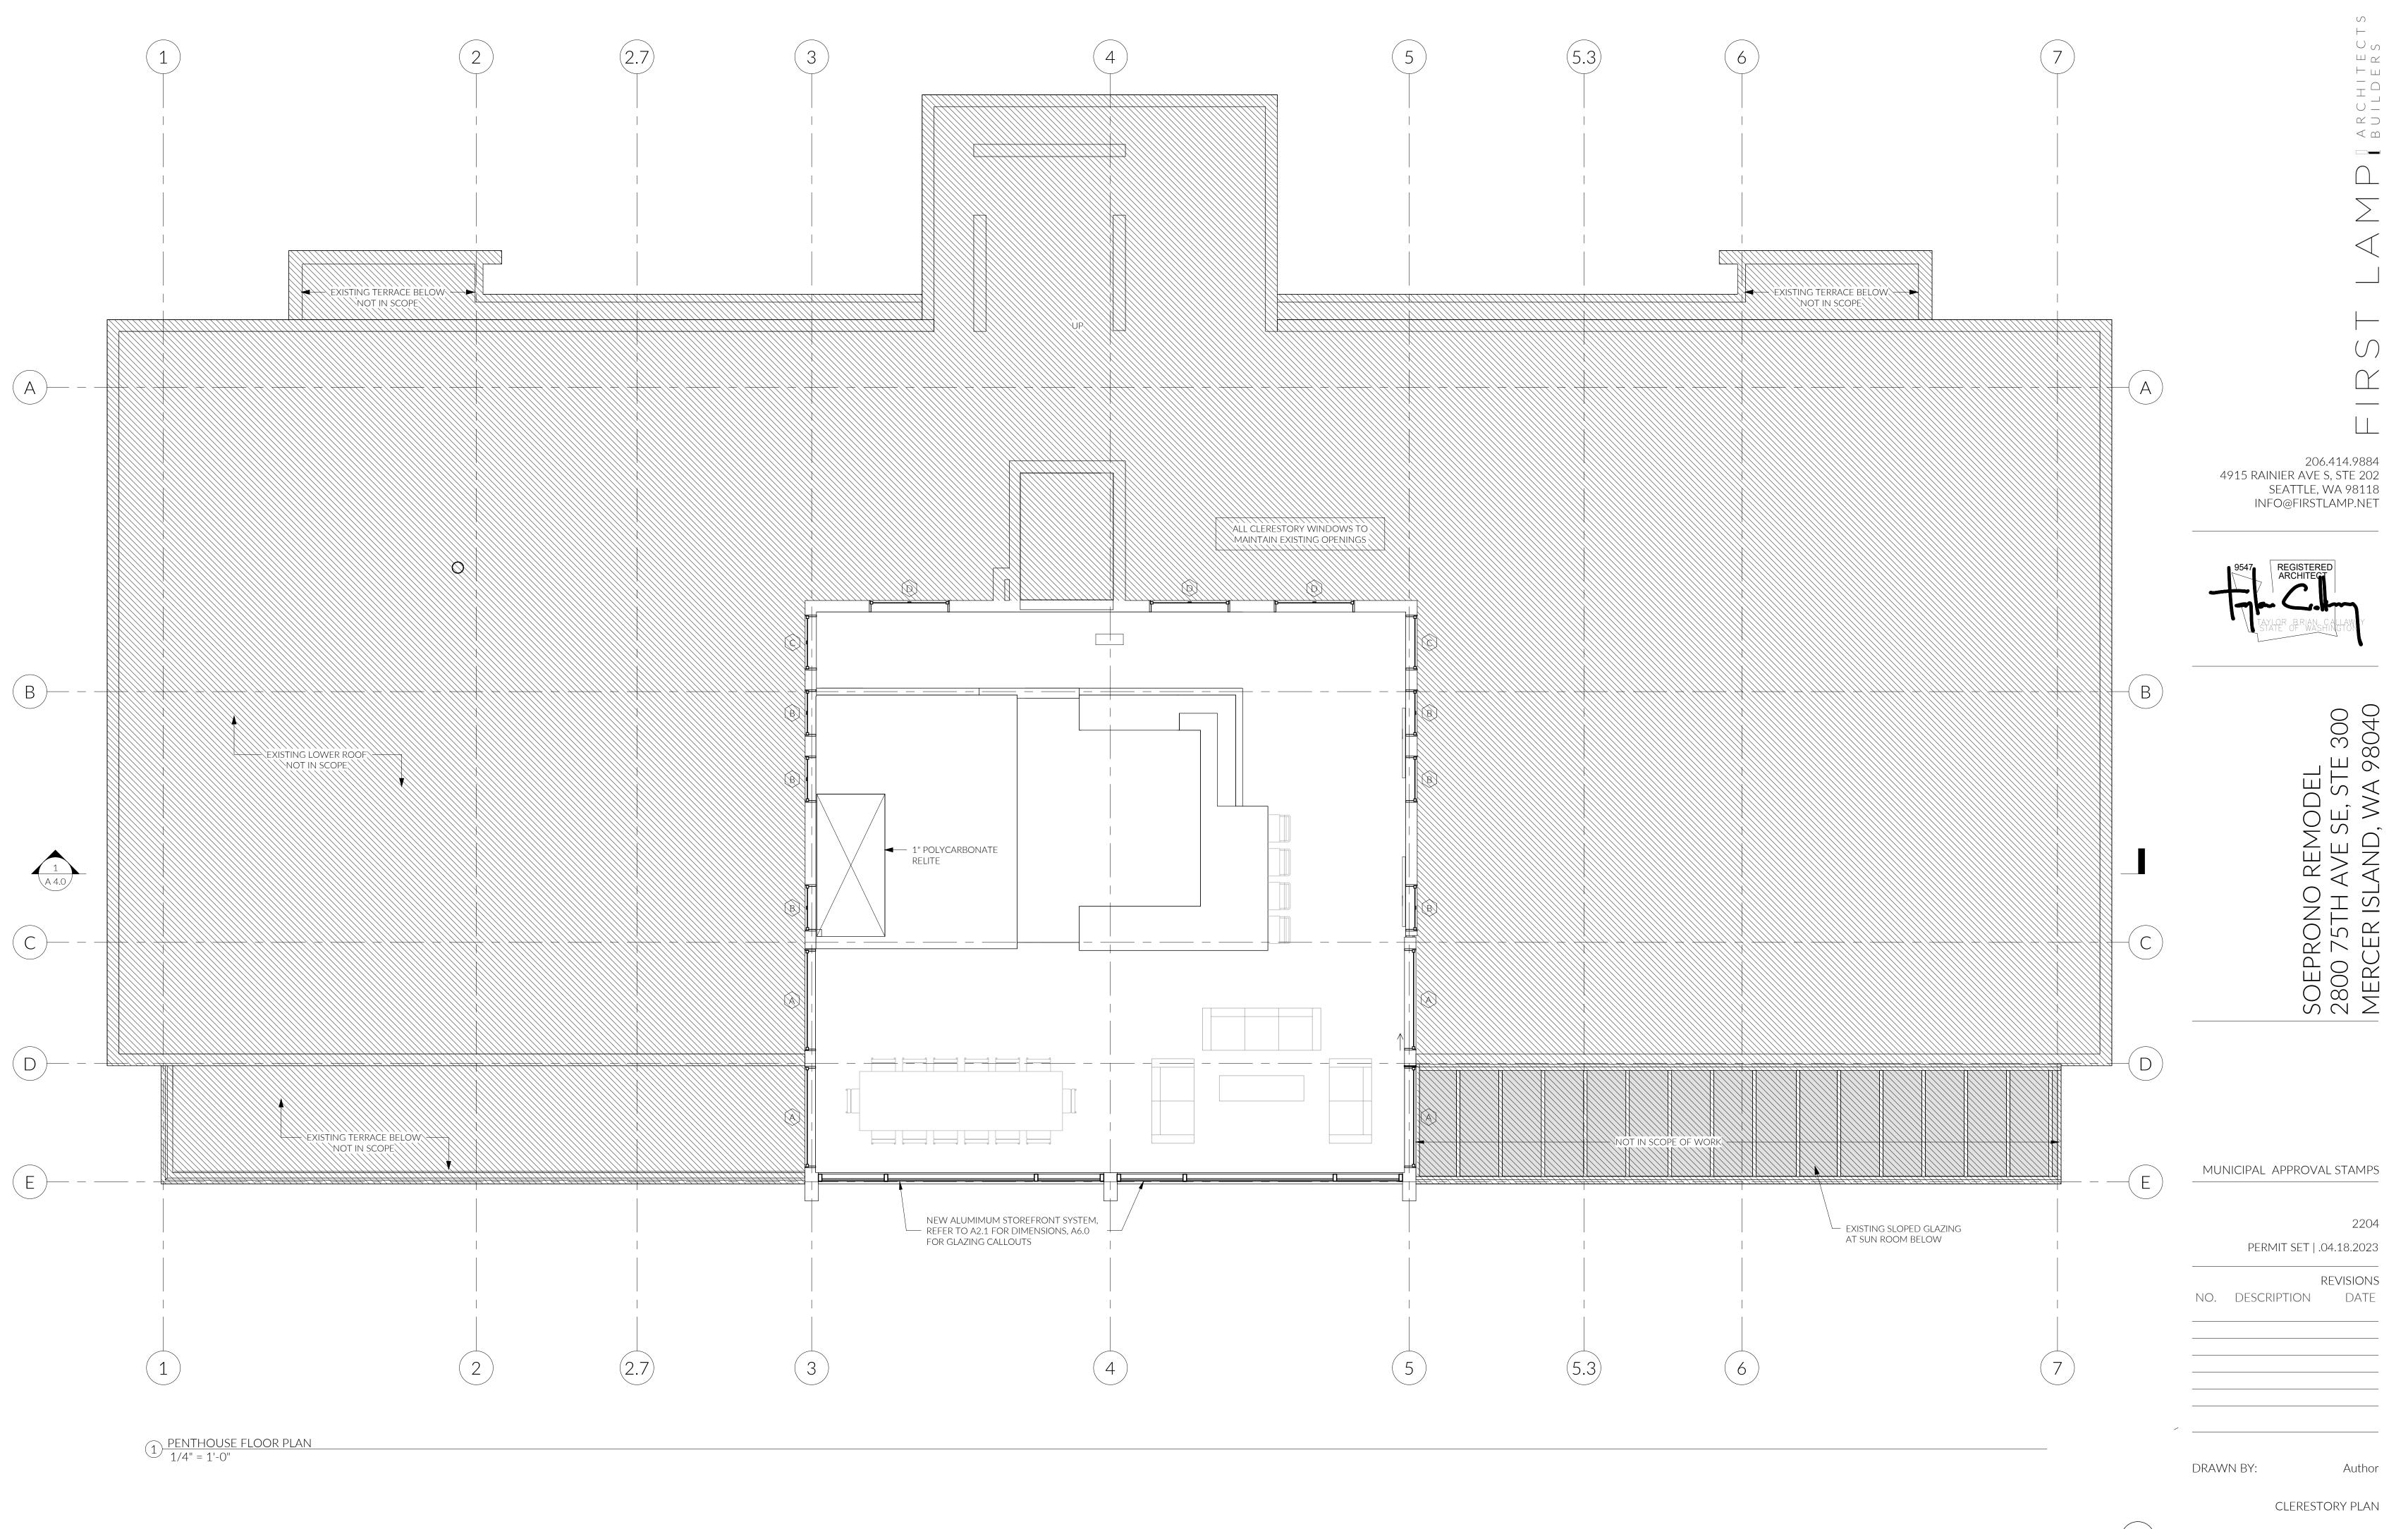

Δ2

PROJECT NORTH

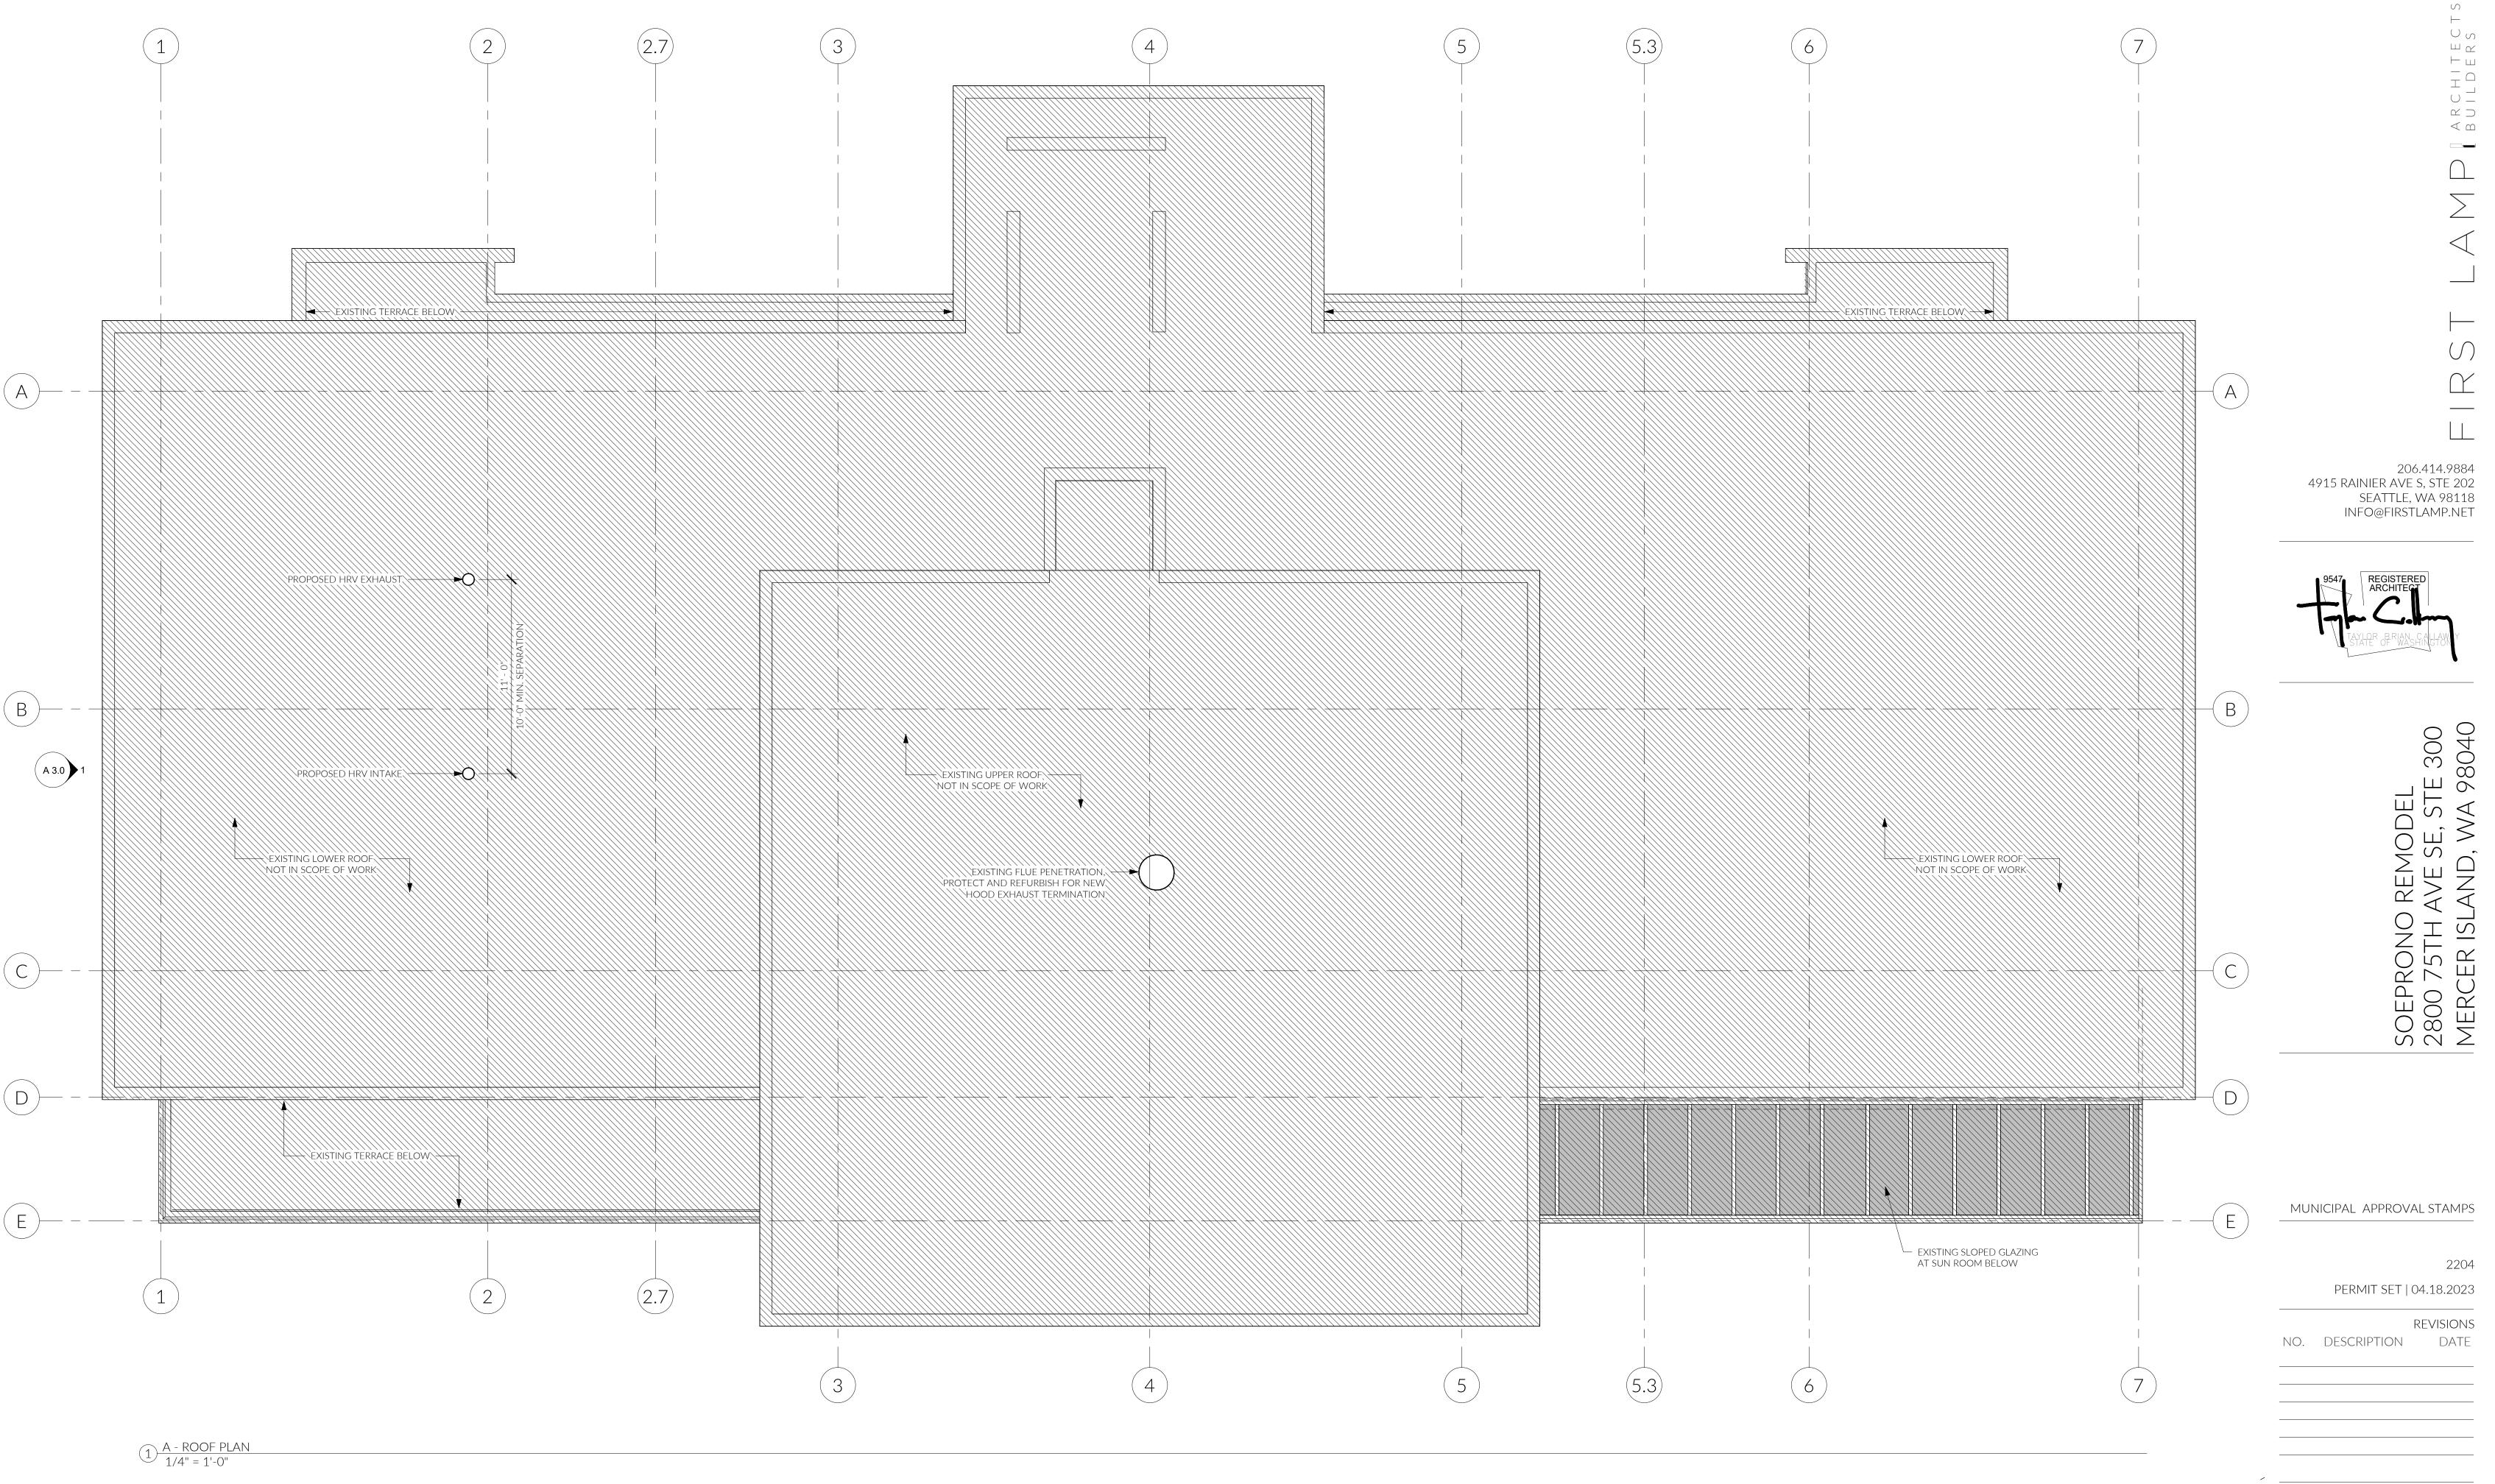

ROOF PLAN NOTES

INSTRUCTIONS.

- 1. DO NOT SCALE DRAWINGS. CONTACT ARCHITECT IMMEDIATELY BEFORE PROCEEDING WITH ANY WORK IF AMBIGUITIES OR DISCREPANCIE EXIST IN DRAWINGS.
- ALL DIMENSIONS REFER TO FACE OF ROUGH FRAMING MEMBER UON.
 REFER TO BUILDING ENVELOPE CONSULTANT FOR FLASH, COUNTER FLASH, CAULK AND SEAL AT ALL NEW PLUMBING AND MECHANICAL PENETRATIONS THROUGH ROOF MEMBRANES. WATERPROOFING SHALL
- 4. EXTEND FROM PENETRATION FLANGE 24" IN ALL DIRECTIONS BEYOND PENETRATION EDGE.
- 5. ALL MATERIALS SHALL BE APPLIED IN ACCORDANCE WITH THE MANUFACTURERS PRINTED INSTALLATION

PROJECT NORTH


DRAWN BY:

ROOF PLAN

A 3.0

EXTERIOR ELEVATIONS

DRAWN BY:

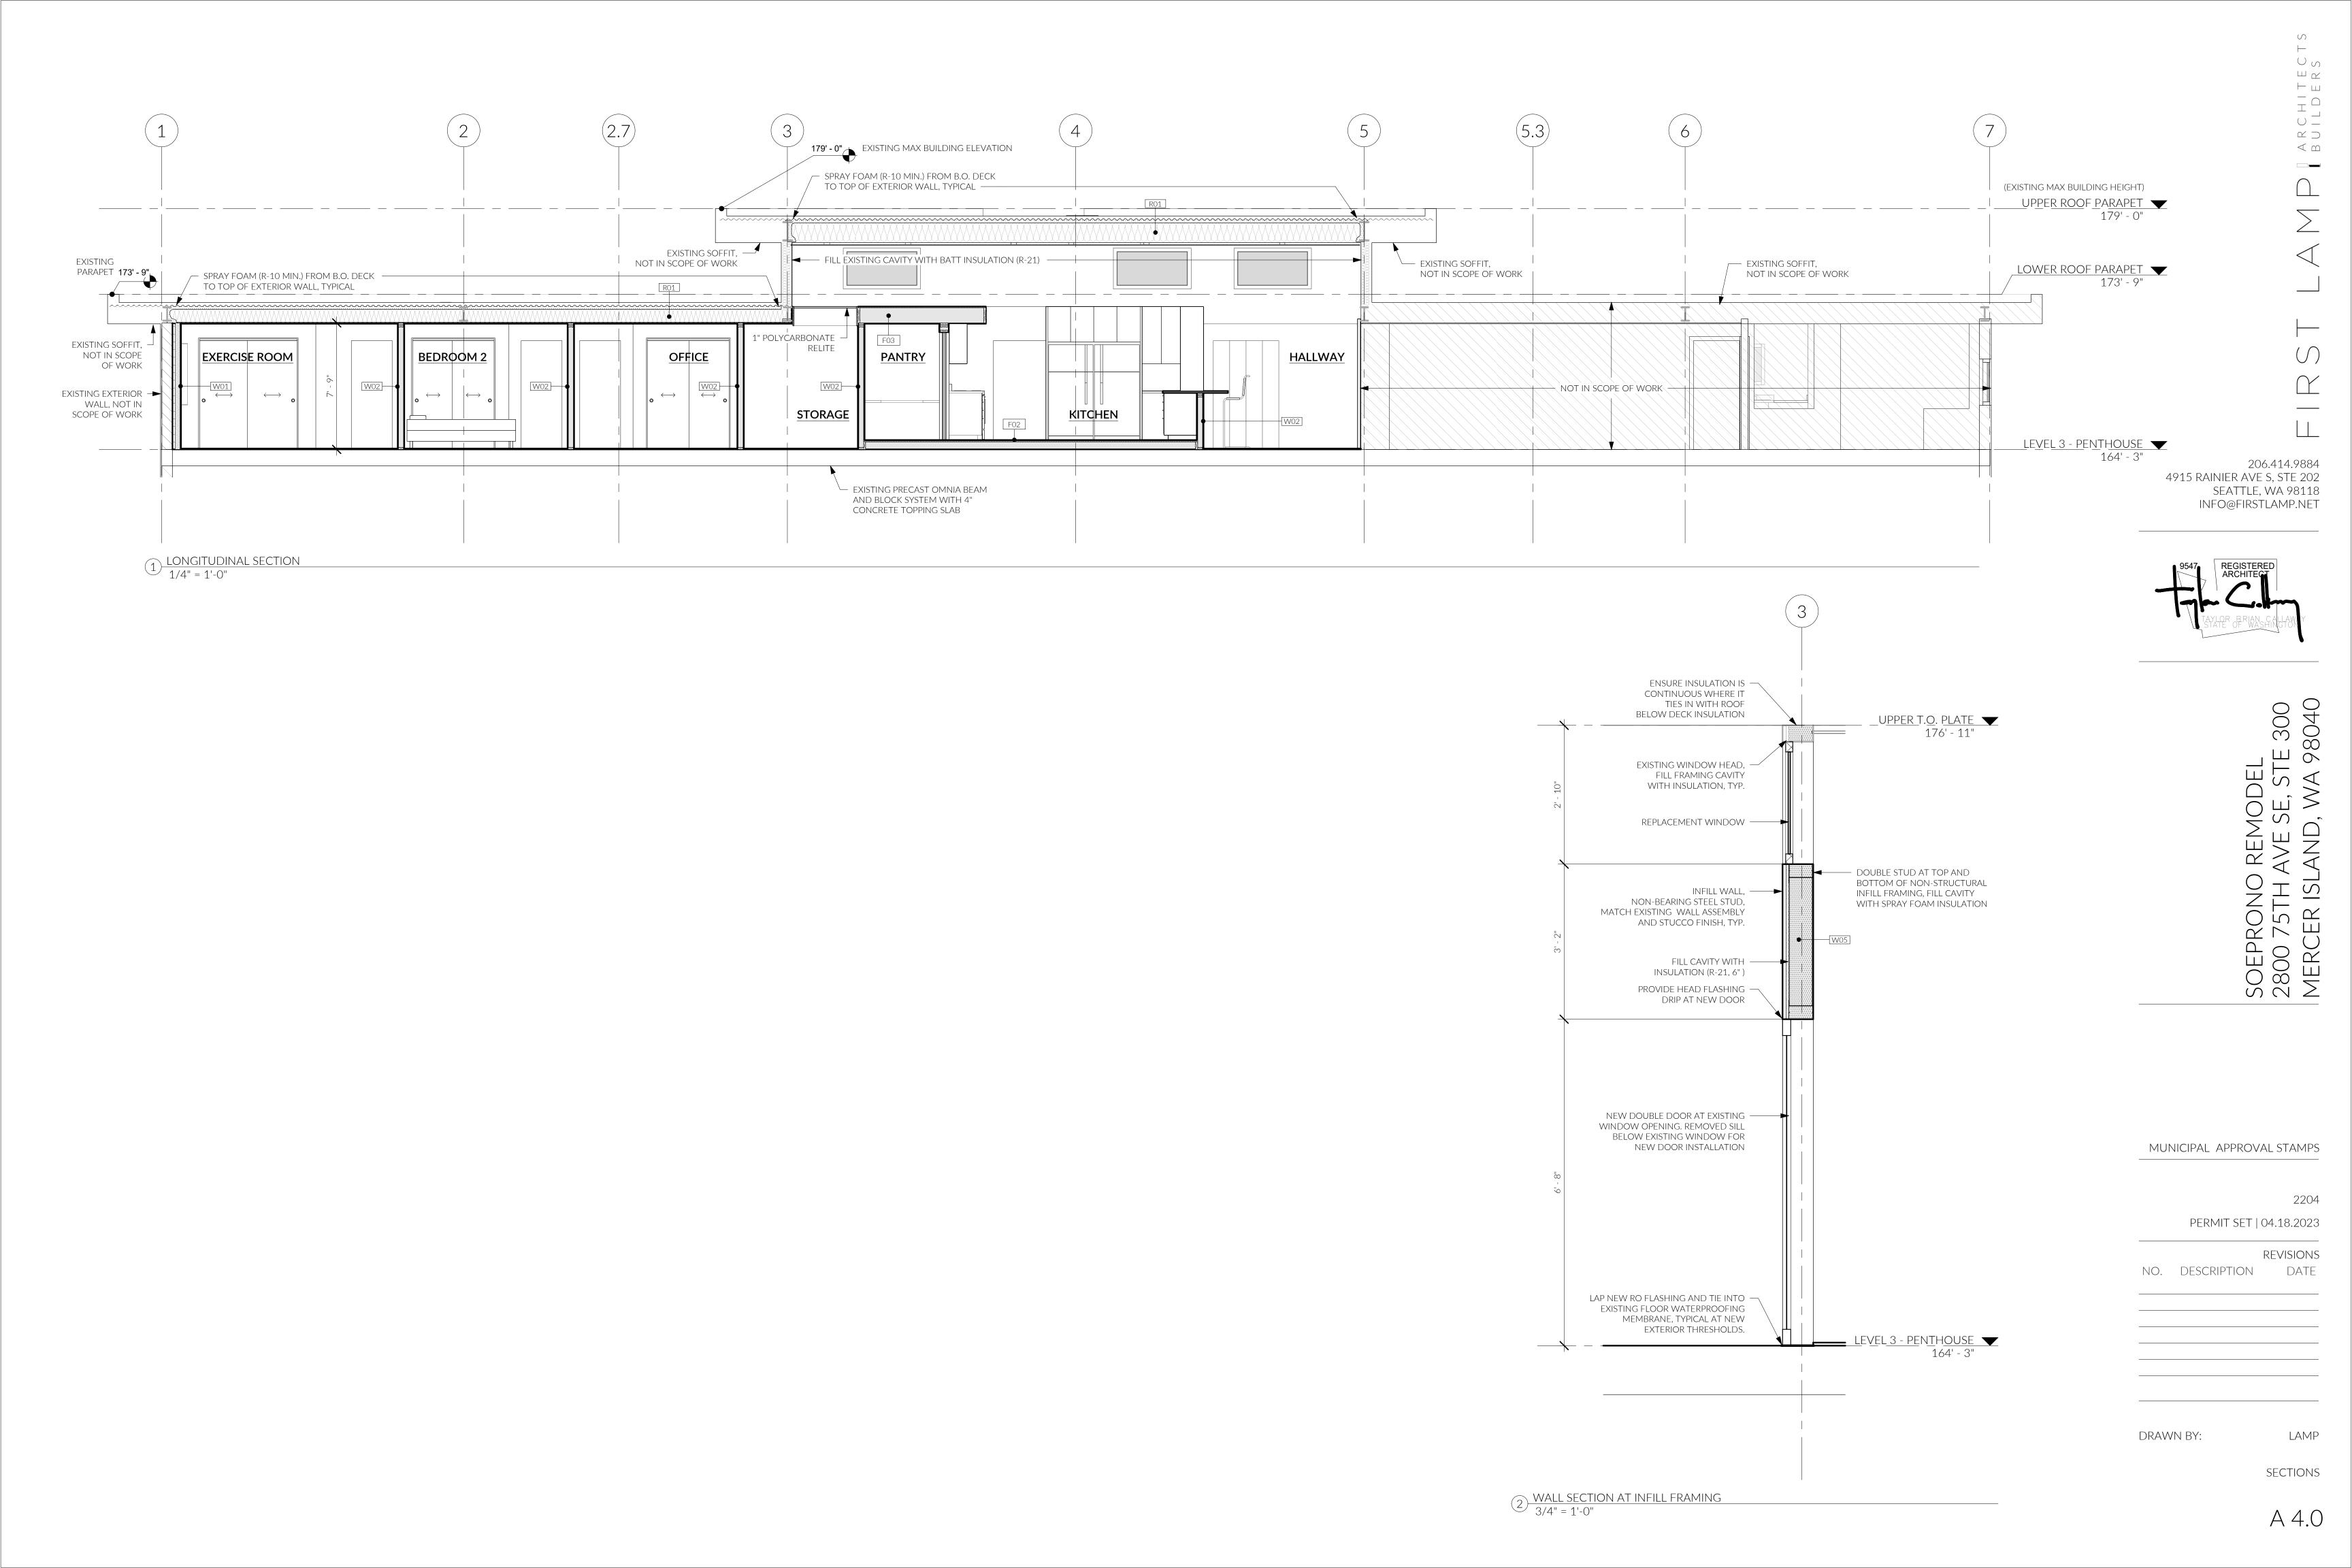

ARCHITEC-BUILDERS

<u>UPPE</u>R <u>SOFFIT</u> ▼ 176' - 11"

LOWER ROOF PARAPET

173' - 9"

LOWER SOFFIT

NEW INFILL WALL,
MATCH ADJACENT WALL
ASSEMBLY AND FNISH

LEVEL 3 - PENTHOUSE TIGHT

ALIGN WITH SILL AT ADJACENT WALL

MUNICIPAL APPROVAL STAMPS

2204 PERMIT SET | .04.18.2023

REVISIONS

NO. DESCRIPTION DATE

DRAWN BY:

INTERIOR ELEVATIONS

A 6.0

TBD

CLERESTORY REPLACEMENT WINDOWS, ROUGH OPENING TO BE VERIFIED IN FIELD <u>UPPER SOFFIT</u> ▼ 176' - 11" ALIGN BOTTOM OF CLERESTORY WINDOWS LOWER ROOF PARAPET 173' - 9"
LOWER SOFFIT 172' - 3" NEW INFILL WALL, MATCH ADJACENT WALL
ASSEMBLY AND FNISH — ALIGN —⟨ **PANTRY** HALLWAY LEVEL 3 - PENTHOUSE 164' - 3"

CLERESTORY REPLACEMENT WINDOWS, ROUGH OPENING TO BE VERIFIED IN FIELD

WINDOW -

IN SCOPE


1) INTERIOR ELEVATION
1/4" = 1'-0"


2 INTERIOR ELEVATION
1/4" = 1'-0"

BEYOND, NOT

ALIGN BOTTOM OF CLERESTORY WINDOWS


➤ ALIGN

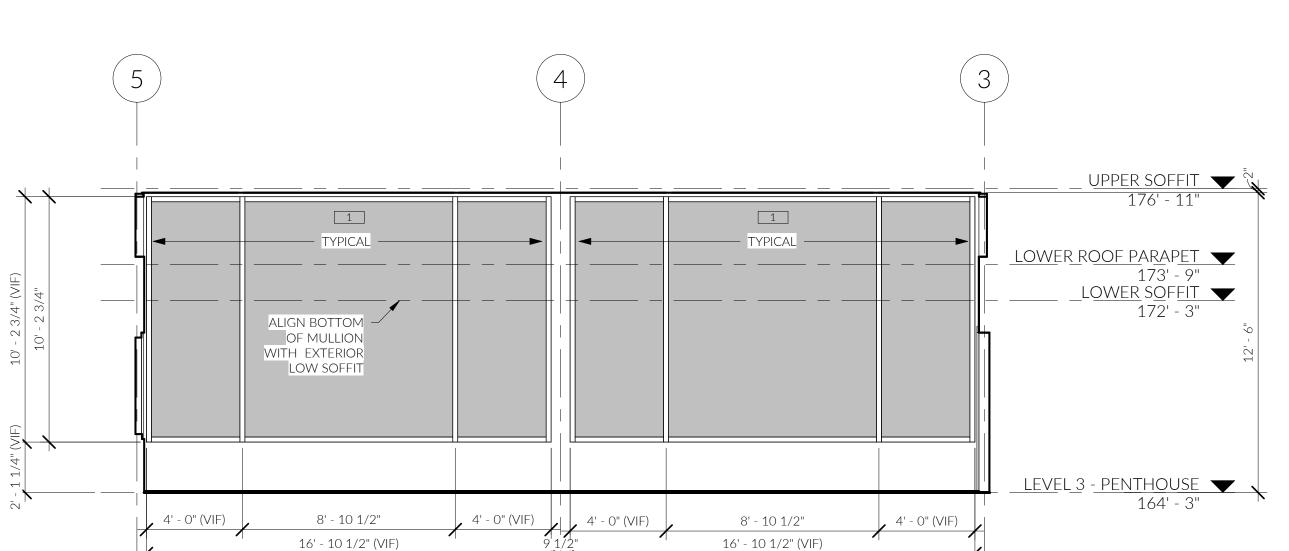


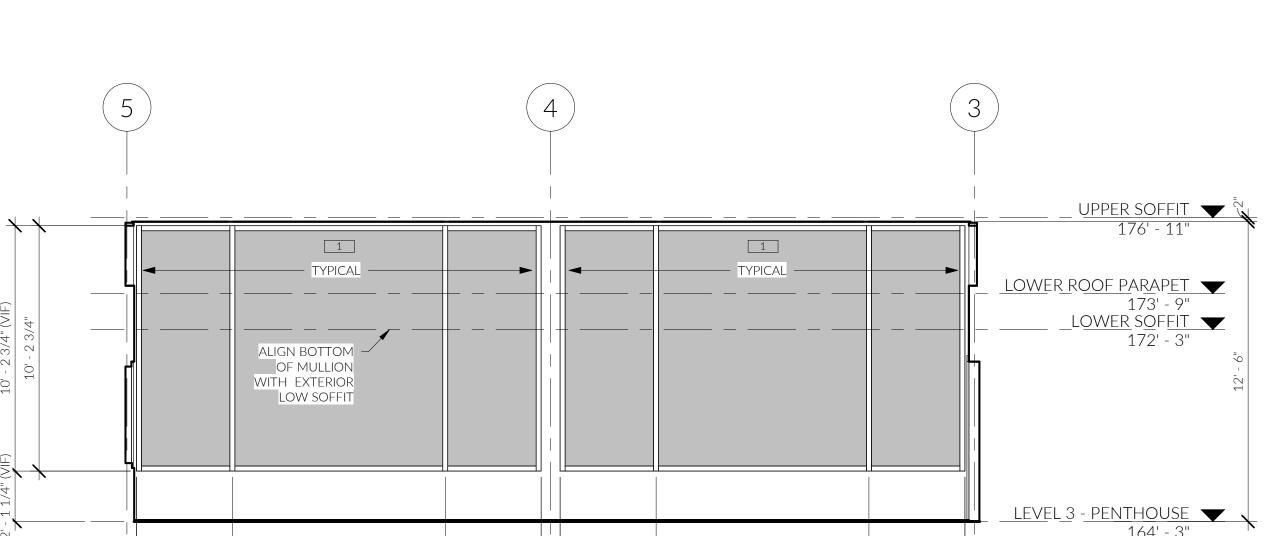

 $3 \frac{\text{INTERIOR ELEVATION}}{1/4" = 1'-0"}$

 $4 \frac{\text{INTERIOR ELEVATION}}{1/4" = 1'-0"}$

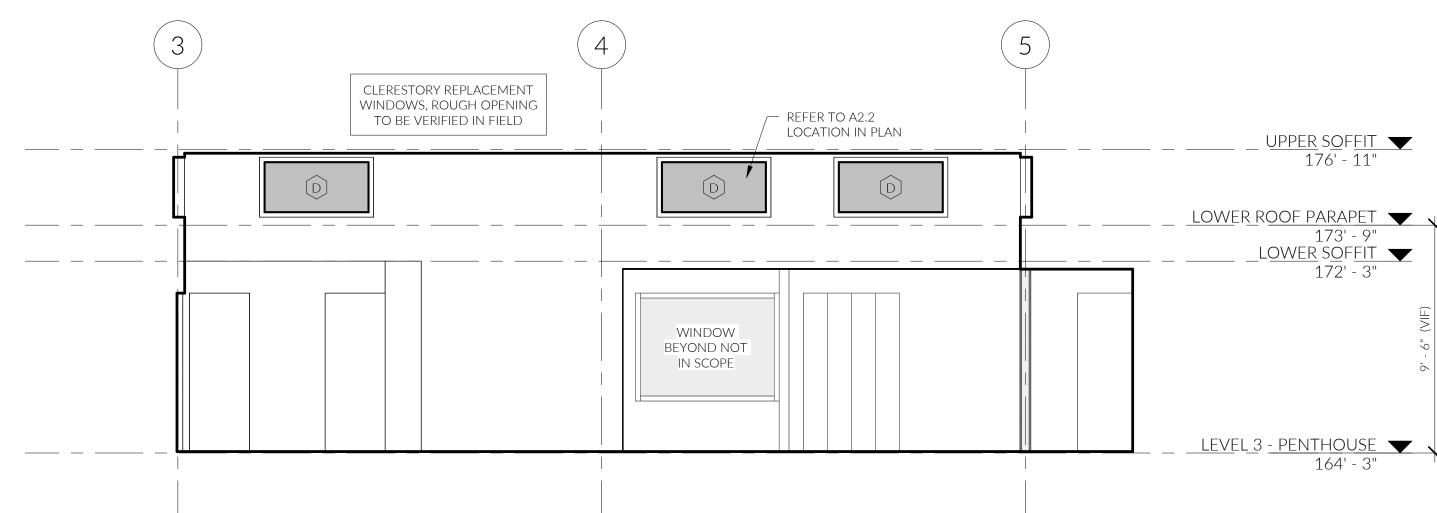

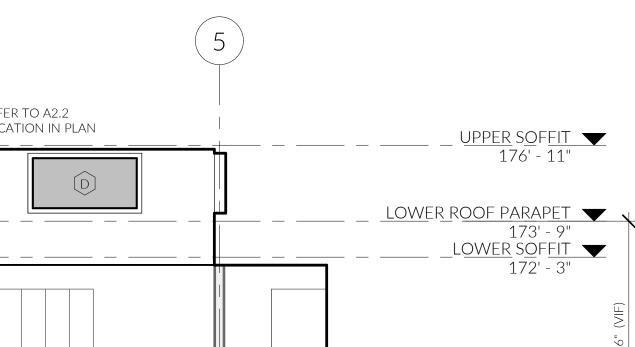


CFM (S/C)


VENTILATION SUPPLY


SMOKE DETECTOR + CARBON MONOXIDE DETECTOR


E 1.0


PROJECT NORTH

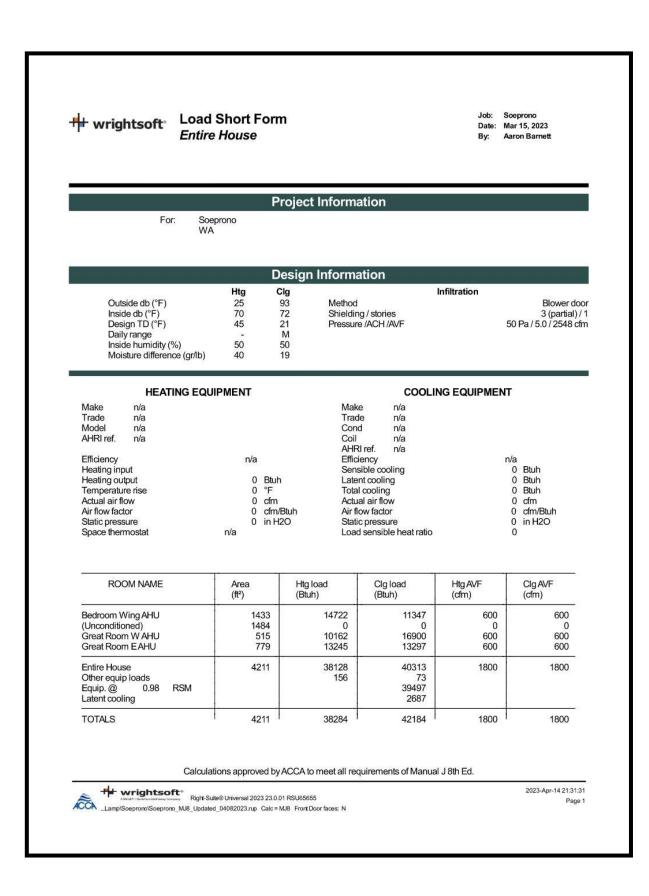

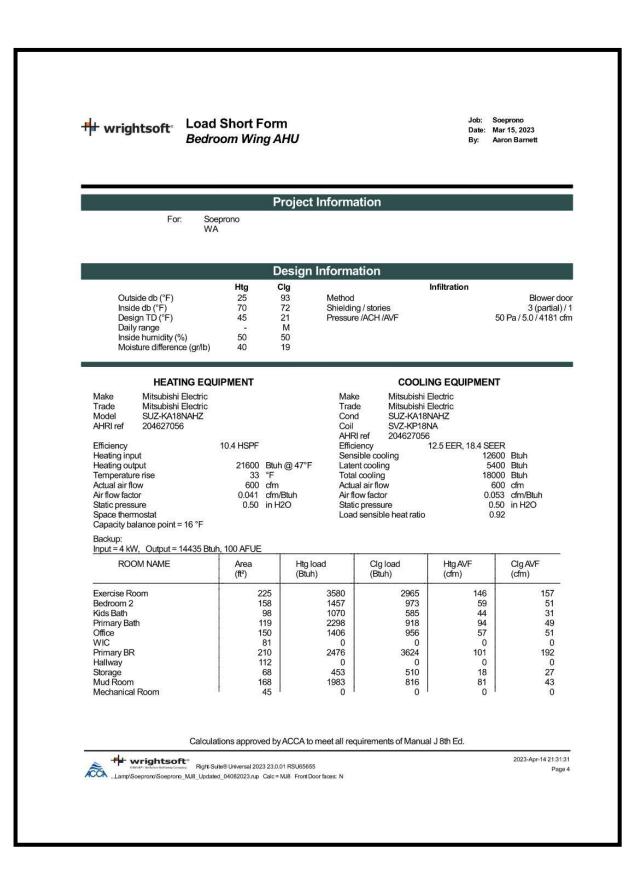


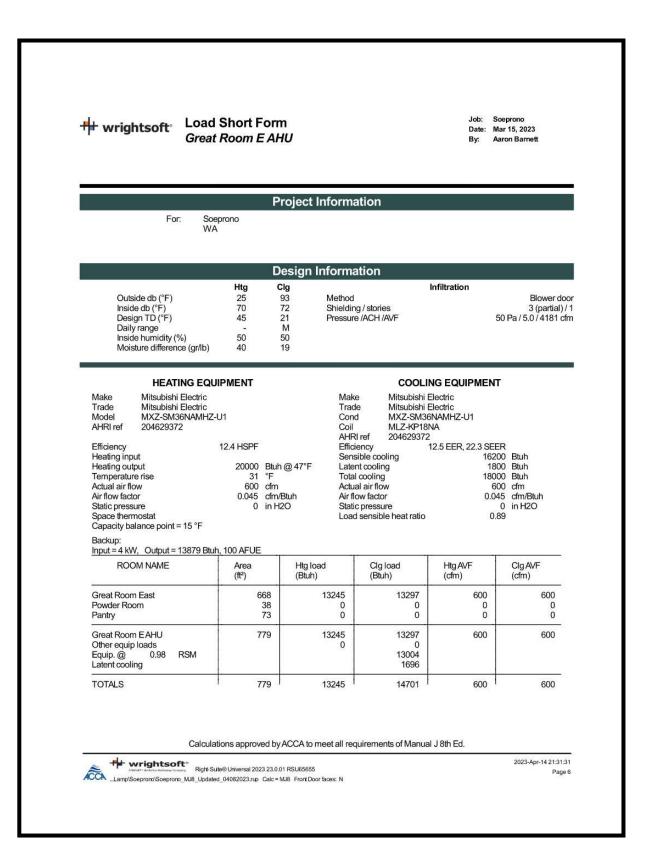


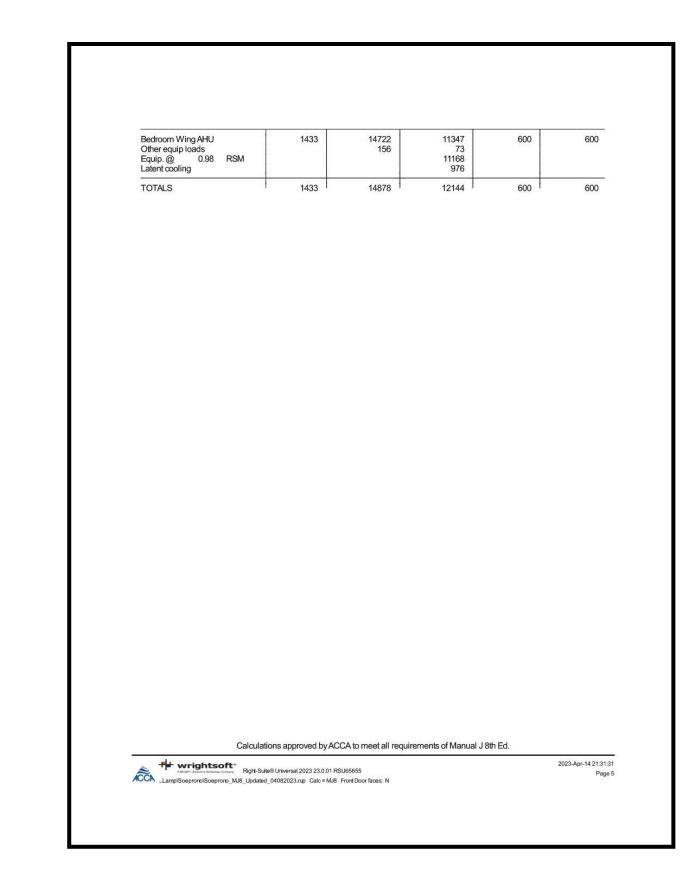

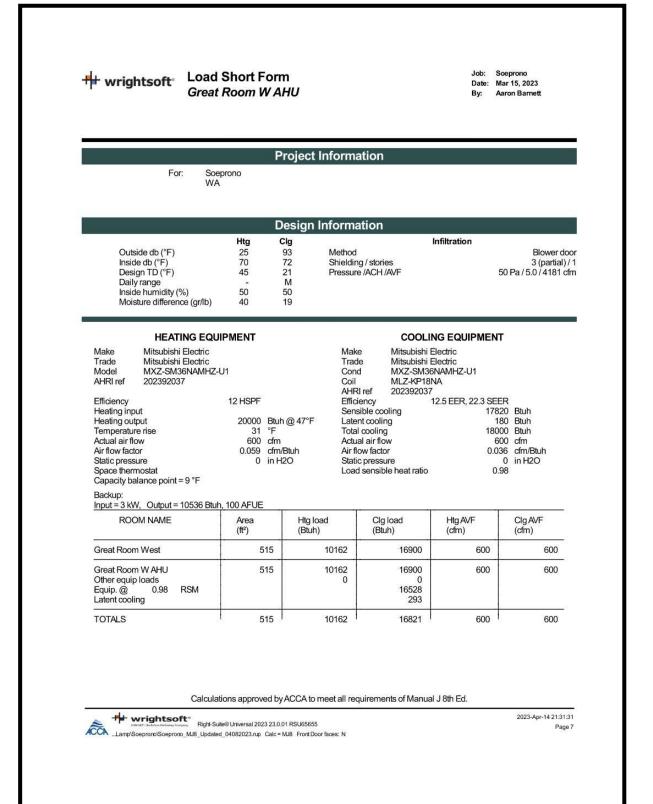

SON SULTING Soeprono 75th Ave SE, Ser Island, WA 2800 Mer Drawn By: Aaron Barnett 04/10/2023

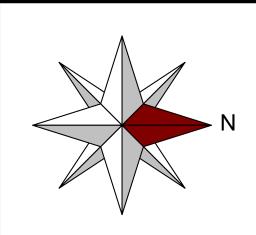

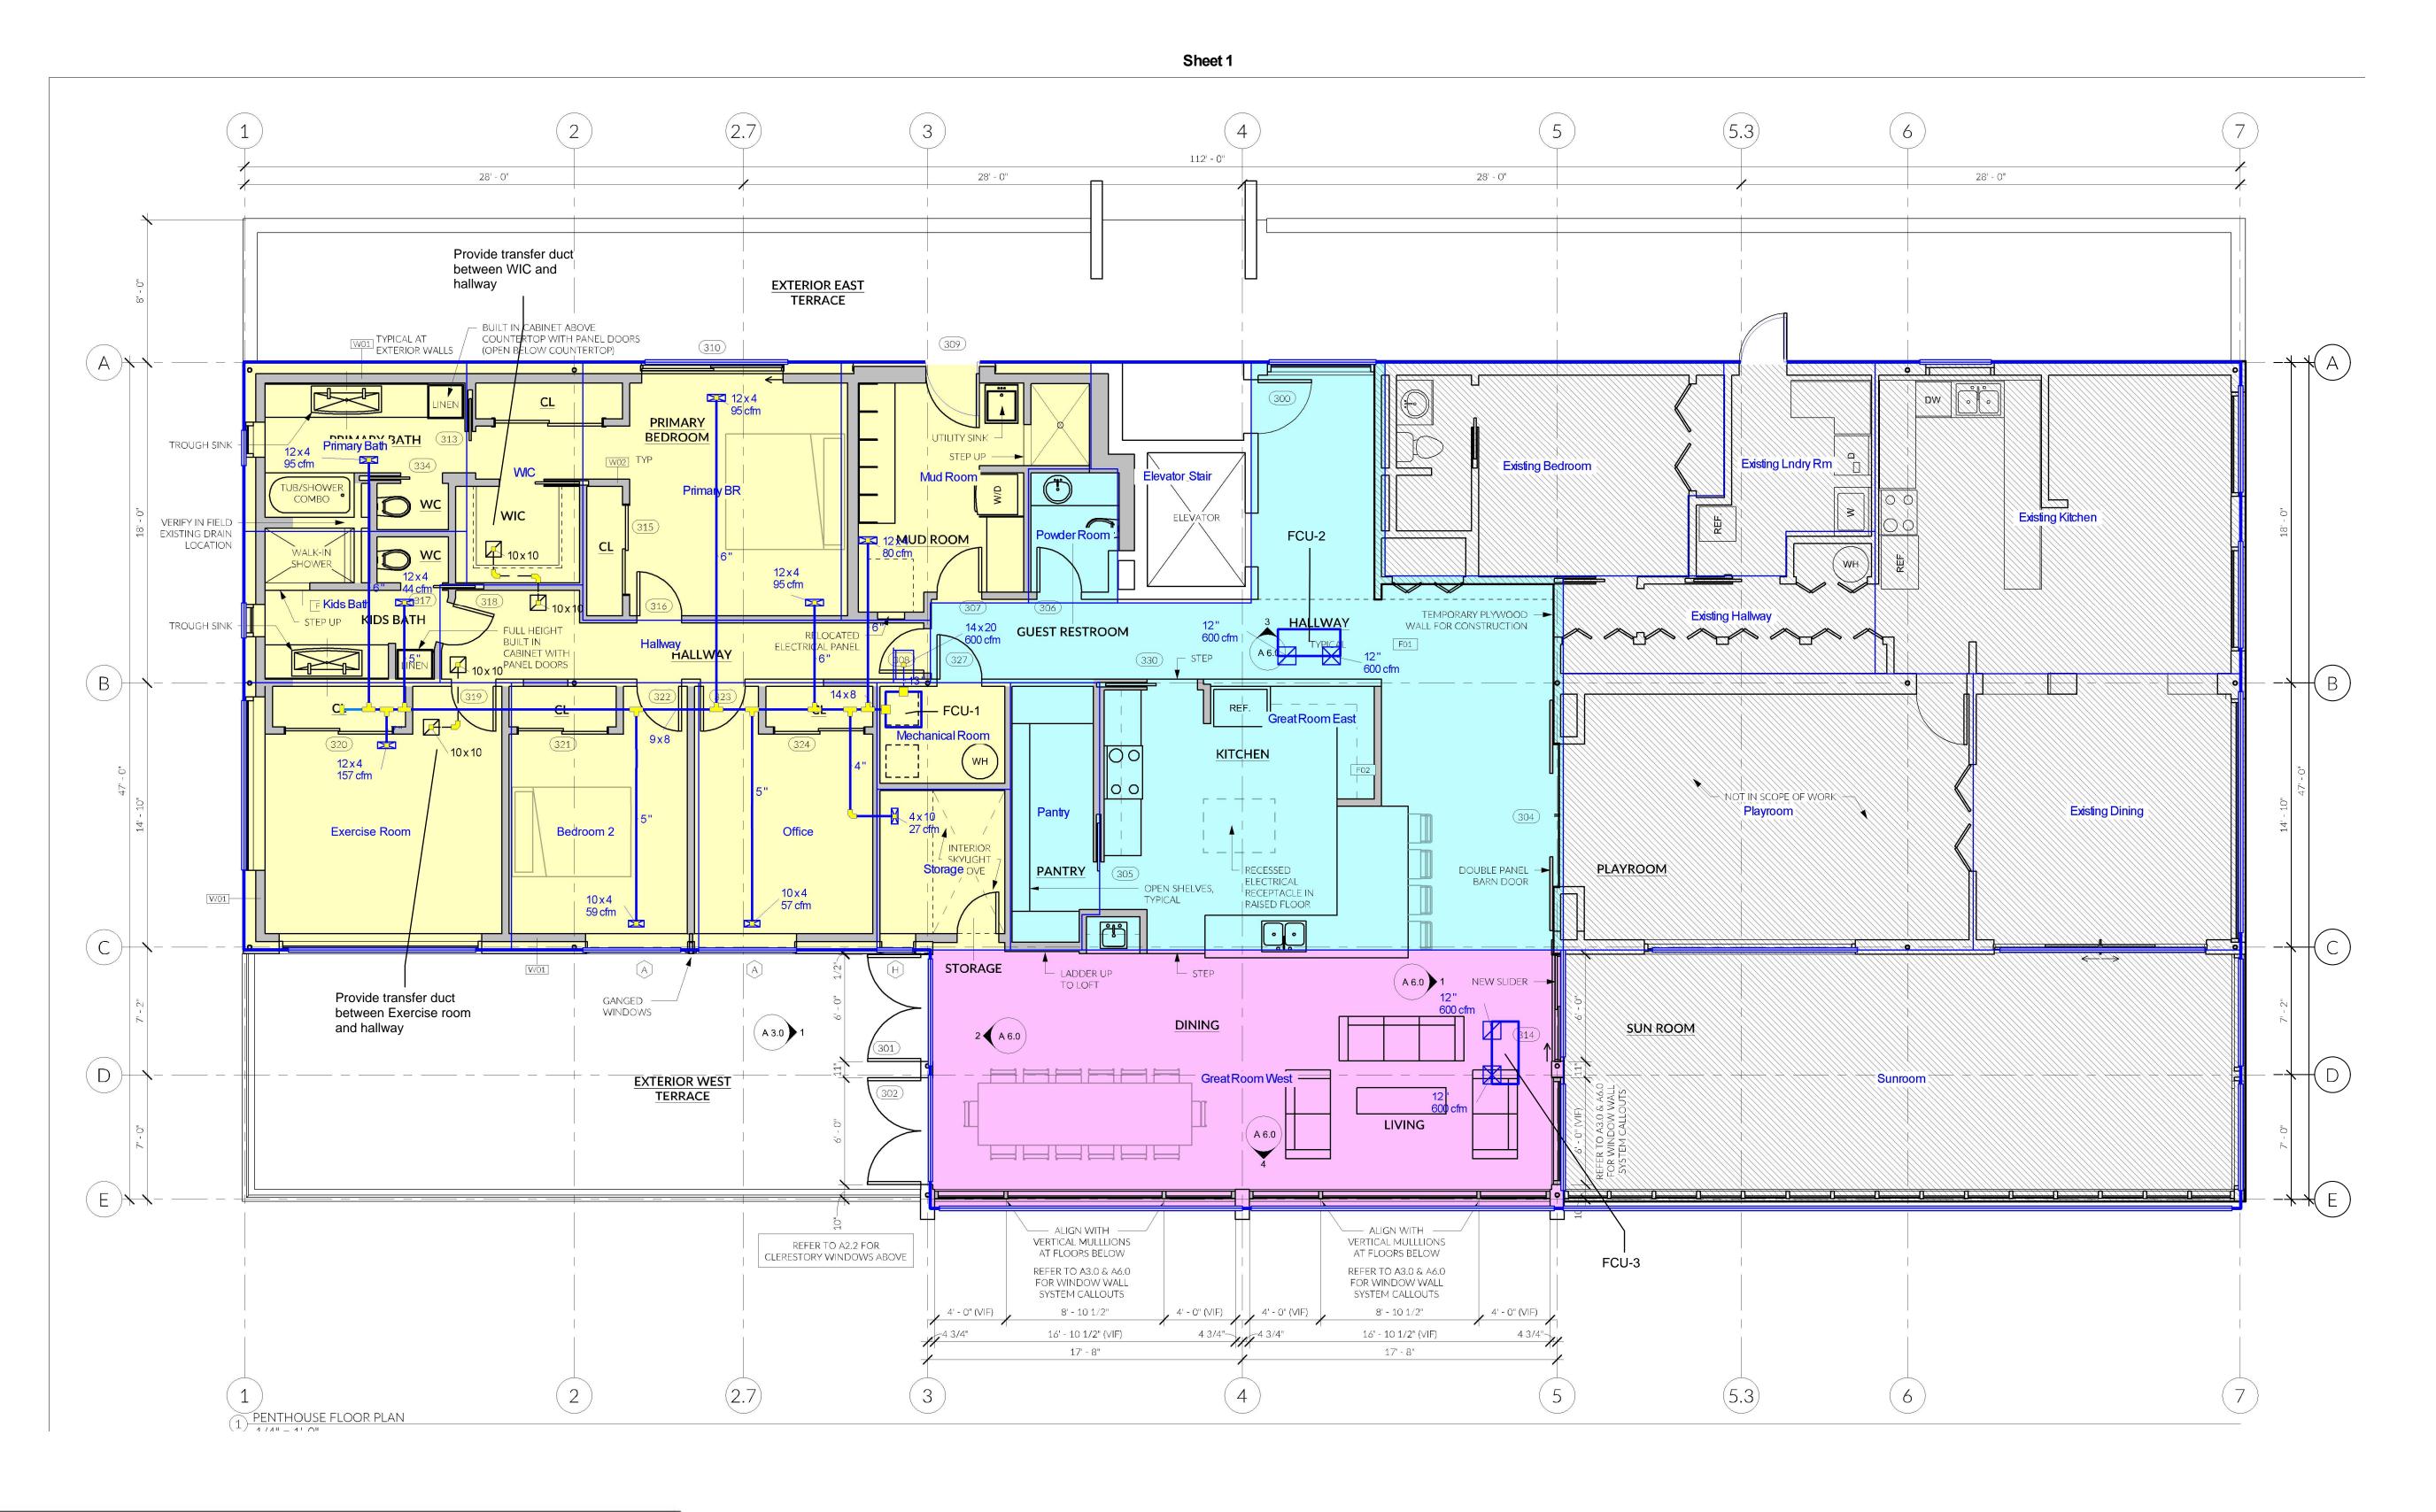


	Fan Coil Schedule								
Designation	Manufacturer	Model	Airflow (cfm)	Maximum SP (in. WG)	Outdoor Unit	Reference Page			
FCU-1	Mitsubishi	SVZ-KP18NA	600	0.5"	SUZ-KA18NAHZ.TH	M301			
FCU-2	Mitsubishi	MLZ-KP18NA2-U1	600	N/A	MXZ-SM36NAMHZ-U1	M301			
FCU-3	Mitsubishi	MLZ-KP18NA2-U1	600	N/A	MXZ-SM36NAMHZ-U1	M301			

Job #: Soeprono Performed by Aaron Barnett for: Soeprono

WA

Scale: 1: Page 1 Right-Suite® Unive 22.0.04 RSU6 2023-Apr-09 20 ...oeprono_MJ8_Updated

Drawn By: Aaron Barnett 04/10/2023

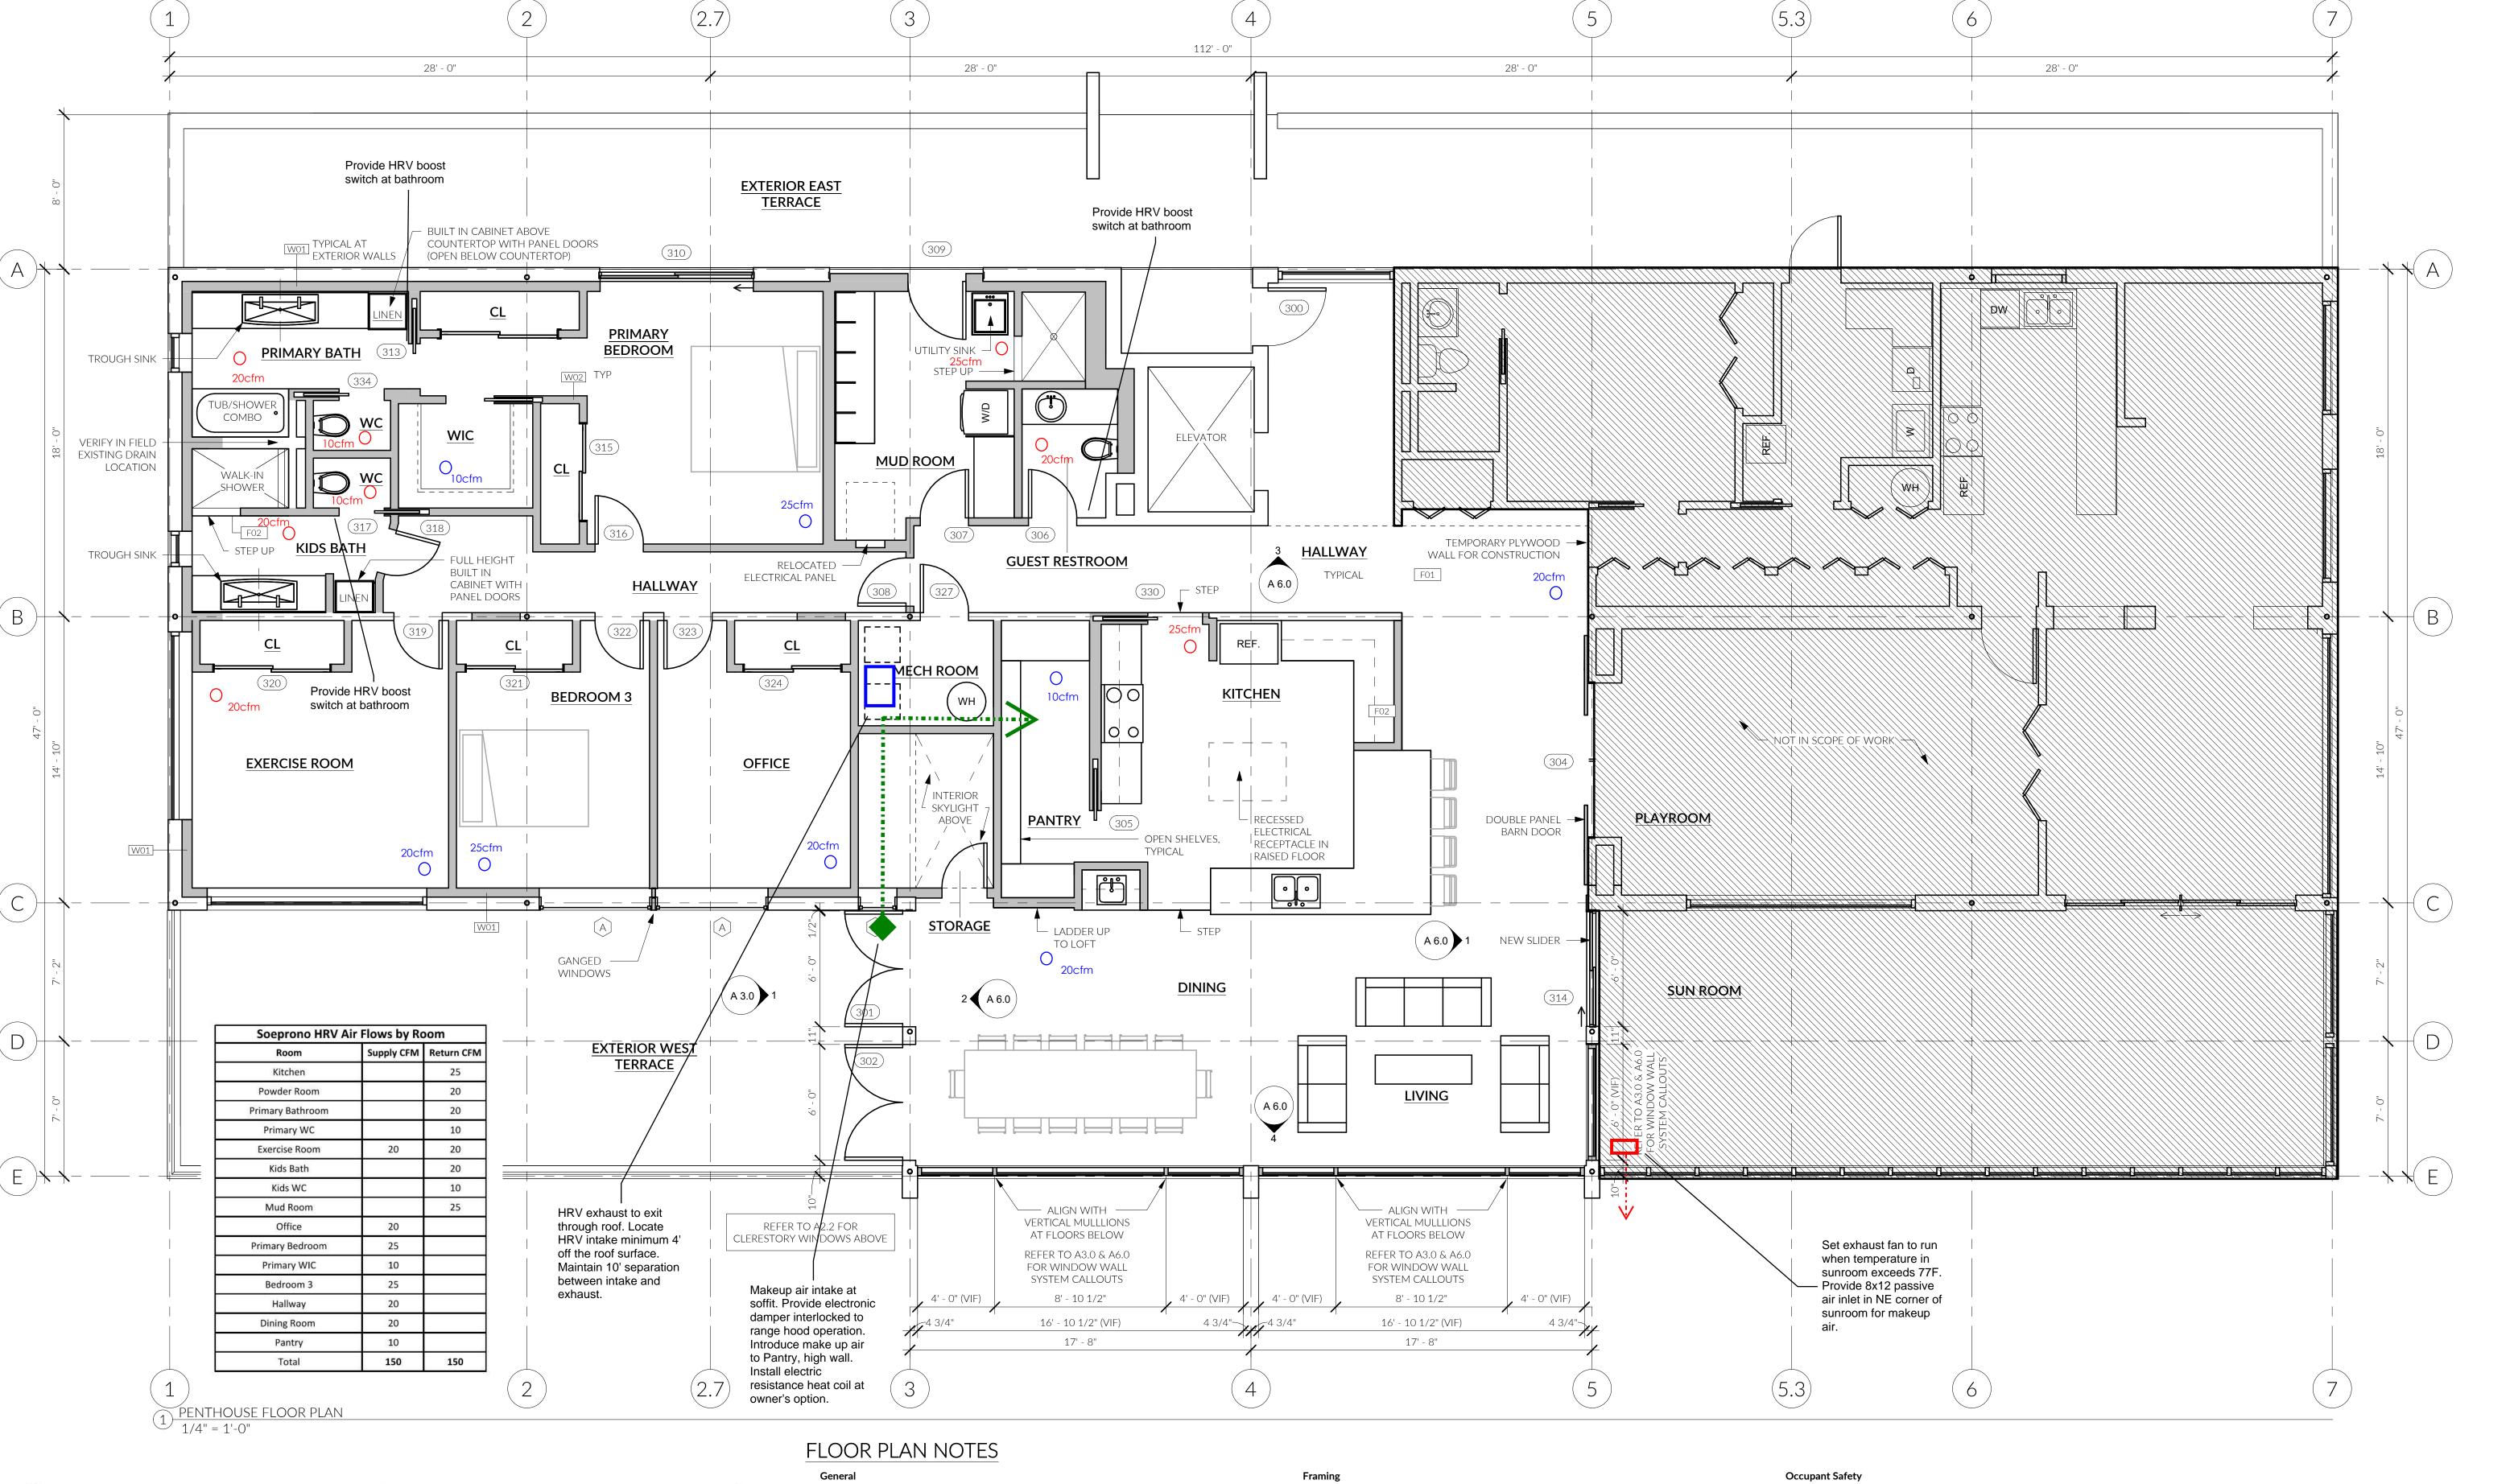

Ventilation Equipment Schedule								
Mark	Manufacturer	Model	Airflow (cfm)	Maximum Static Pressure (in. WG)	Operation			
	Zehnder	Comfoair Q450	0-265	0.8"	Continuous			
	Panasonic	FV-40NLF1	440	0.375"	Intermitten			

- 1. Do not scale drawings. Contact architect immediately before proceeding with any work if
- 3. Smoke alarms are required to be hardwired and interconnected with a battery backup.

2. All dimensions refer to face of rough framing member or face of concrete UON.

ambiguities, discrepencies, or a lack of information exist in drawings.

- 4. Foundation Concrete dampproofing shall be installed at below-grade concrete walls which
- enclose habitable space. 5. All foundation footings that enclose habitable space shall be drained with continuous 4" perforated pipe surrounded by crushed rock, sloped @ 1/4" per ft. min. to drain
- 6. If crawl spaces are vented, they shall be vented through openings in the perimeter walls. Openings shall be provided within 3' of each corner of the building and be covered with sheet metal plates, cast-iron grilling or grating, load-bearing brick, hardware cloth, or corrosionresistant wire mesh. See IRC (or SRC) R408.2 for more specifics on approved covering
- 7. If crawl spaces are unvented, exposed earth shall be covered with a continuous Class I vapor retarder with joints overlapping by 6" and sealed or taped. The edges of the vapor retarder shall extend at least 6" up the stem wall and shall be attached and sealed to the stem wall. A radon ssytem shall be installed that meets the requirements of SRC Appendix F.
- 8. Access shall be provided to all under-floor spaces. Openings through a perimter wall sahll be not less than 16" x 24". When any portion of the through-wall access is below grade, an areaway not less than 16" x 24" whall be provided. The bottom of the areaway shall be below the threshold of the access opening. Through wall access openings shall not be located under a door to the residence.

- 9. All interior walls shall be framed using 2x4 studs UON.
- 10. Attic spaces greater than 30 SF in area must be provided an access hatch with a minimum opening dimension of 22" x 30" and a minumum headroom of 30"
- 11. All ceilings are flat UON. 12. All wood siding, sheathing and wall framing on the exterior of a building having a clearance of
- less than 6" from the ground shall be preservative treated. 13. All wood framing that rests on concrete or masonry exterior foundation walls and are less than
- 8" above exposed grade shall be preservative treated. 14. Stud bays at locations to receive towel bars, TP holders, or other such wall-mounted fixtures shall be filled in with horizontal blocking 12" above and below the estimated future mounting
- **Protection from Building-Borne Moisture** 15. In all framed walls, floors, and roof/ceilings included in the building envelope, a PVA primer
- shall be applied to the face of drywall prior to painting. 16. GWB used to finish the walls and ceilings of all bathroom spaces shall be moisture resistant. Material thickness of 1/2" shall be installed in locations where ceiling framing does not exceed 12" oc., 5/8" shall be installed in locations where ceiling framing does not exceed 16" oc.
- Fire Safety 17. All enclosed and accessible understair spaces shall be finished with 1/2" minimum thickness
- 18. Garage spaces adjoined to the remaining portion of the building shall be finished with 5/8"

- 19. All handrails for stairs with a change in height greater than 30" shall be between 34" and 38" in height, measured vertically from the nosing of the tread. The bottom rail of the handrail shall
- 20. Balusters shall be placed so as not to allow the passage of a 4" sphere. All handrails shall be continuous for the run of the stairs and shall terminate into a newell or safety terminal.

21. All guards at all porches, balconies landings, and stairs shall have a minimum height of 36"

be positioned so as not to allow a 6" sphere from passing between it and the treads below.

- measured vertically above the adjacent walking surface. The opening between the bottom surface of the guard and the walking surface shall be smaller than that which allows the passage of a sphere with a diameter of 4".
- 22. An approved carbon monoxide alarm shall be installed outisde of each separate sleeping area in the immediate vicinity of the bedrooms.
- Applicances 23. All applicances shall be installed per manufacturers written instructions unless a conflict with
- local code exists, in which case local code shall govern appliance installation. 24. Gas Fireplaces shall be listed and labeled for its application and use.
- 25. Prior to beginning work, contractor shall verify chimney framing dimensions allow for required clearances to combustible materials established by appliance installation requirements. 26. Appliances having an ignition source located in garage spaces shall be elevated such that the

source of ignition is not less than 18" above the garage floor.

WALL LEGEND

EXISTING WALL

NEW WALL


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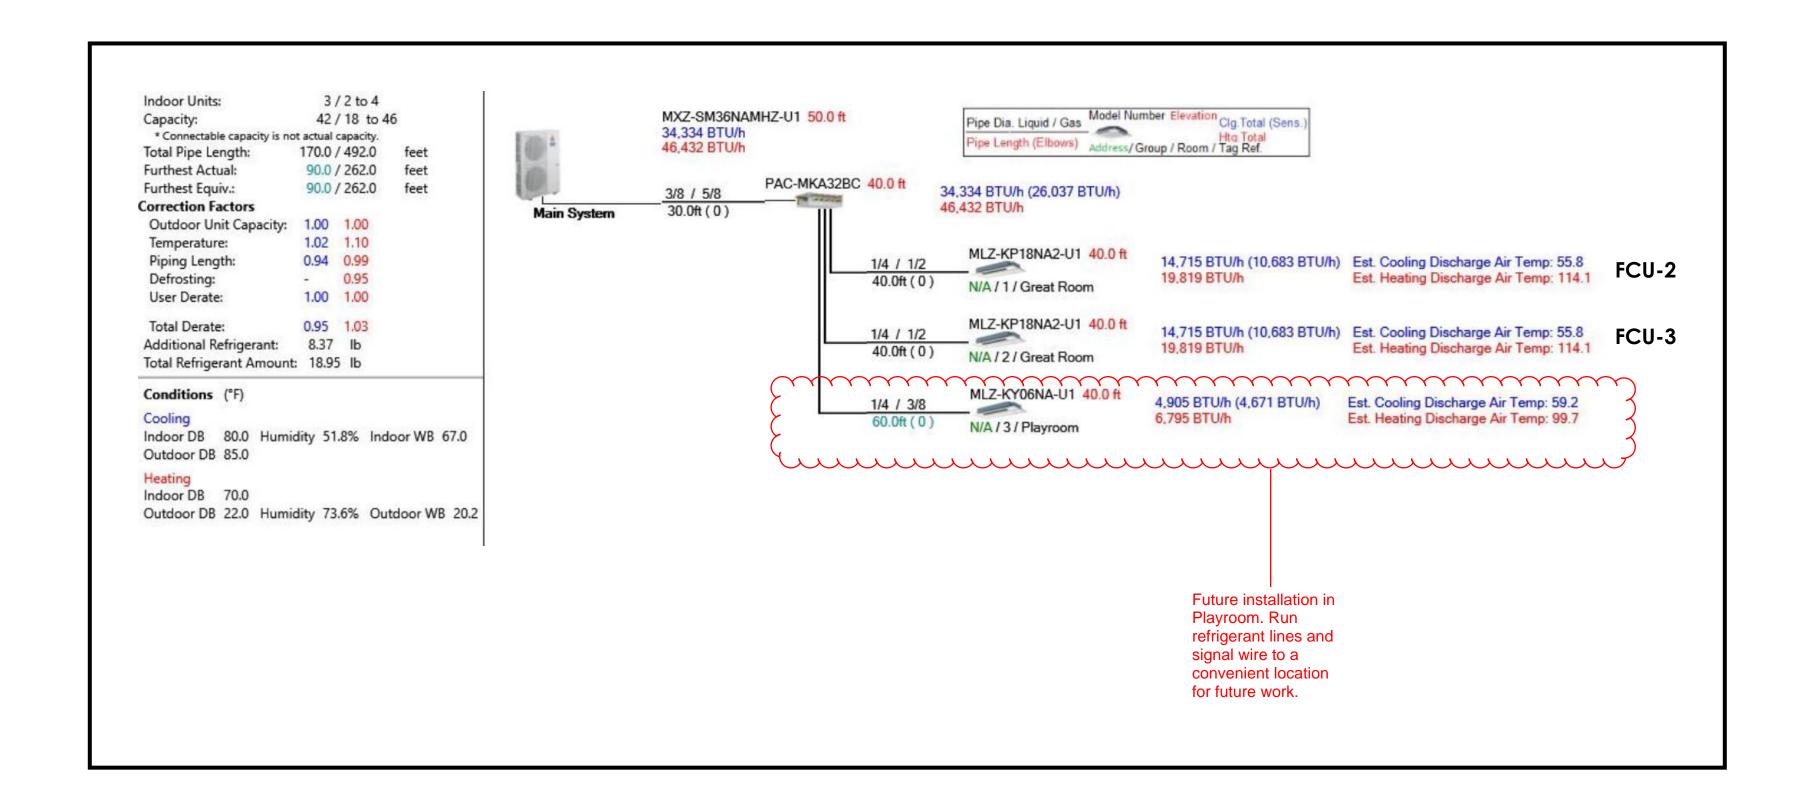
Aaron Barnett


04/10/2023

FOR REFERENCE ONLY

PROJECT NORTH



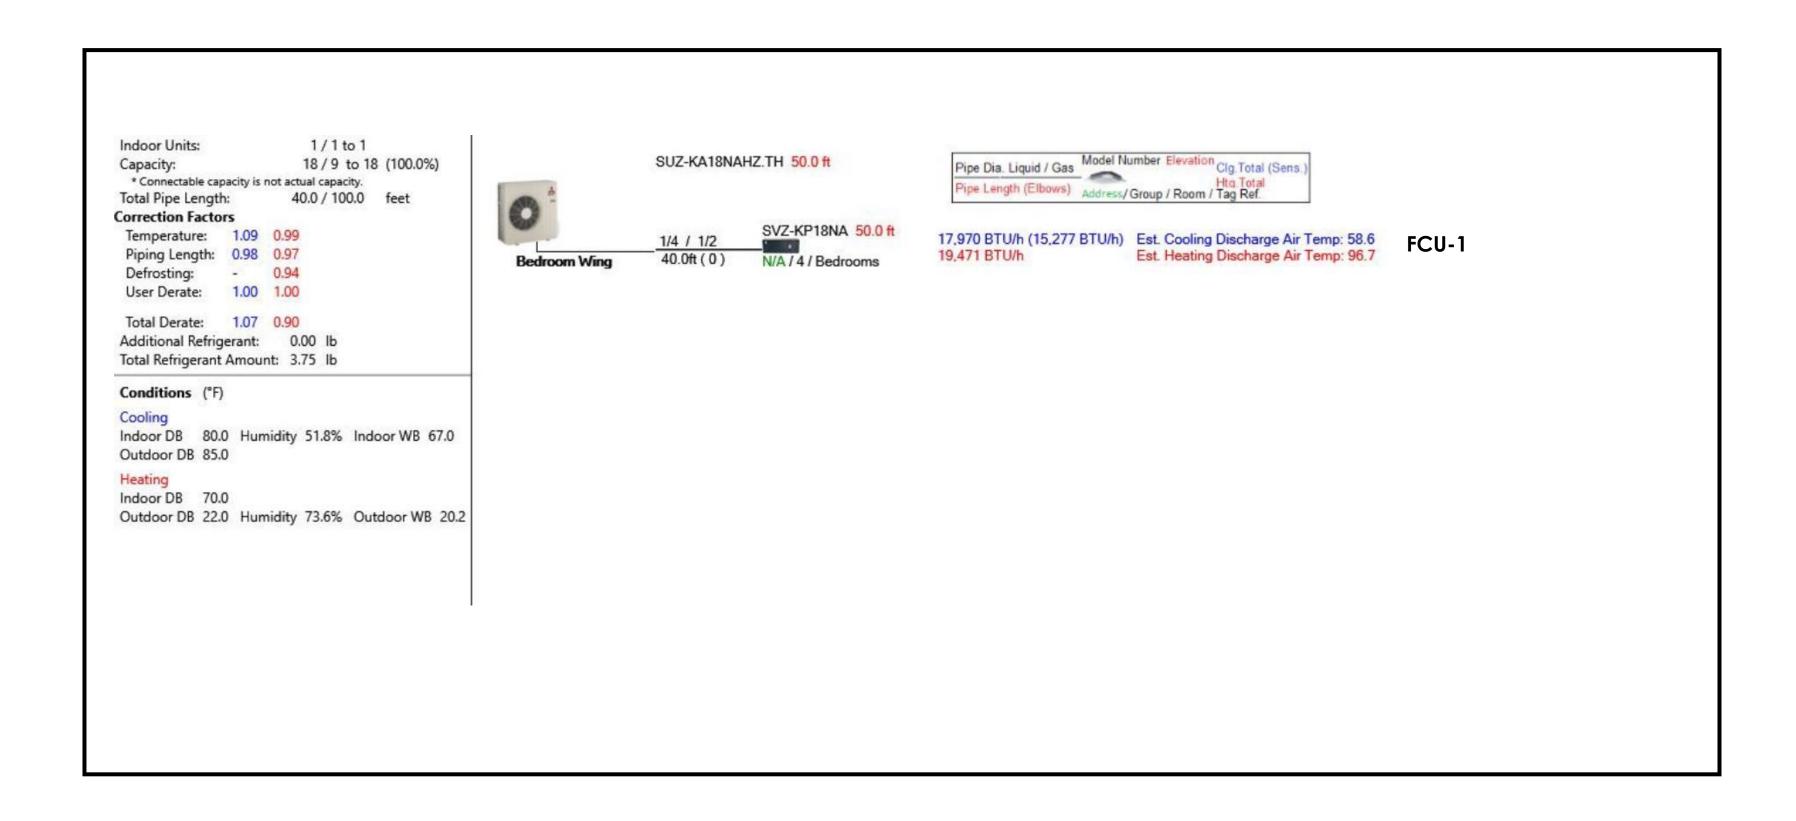

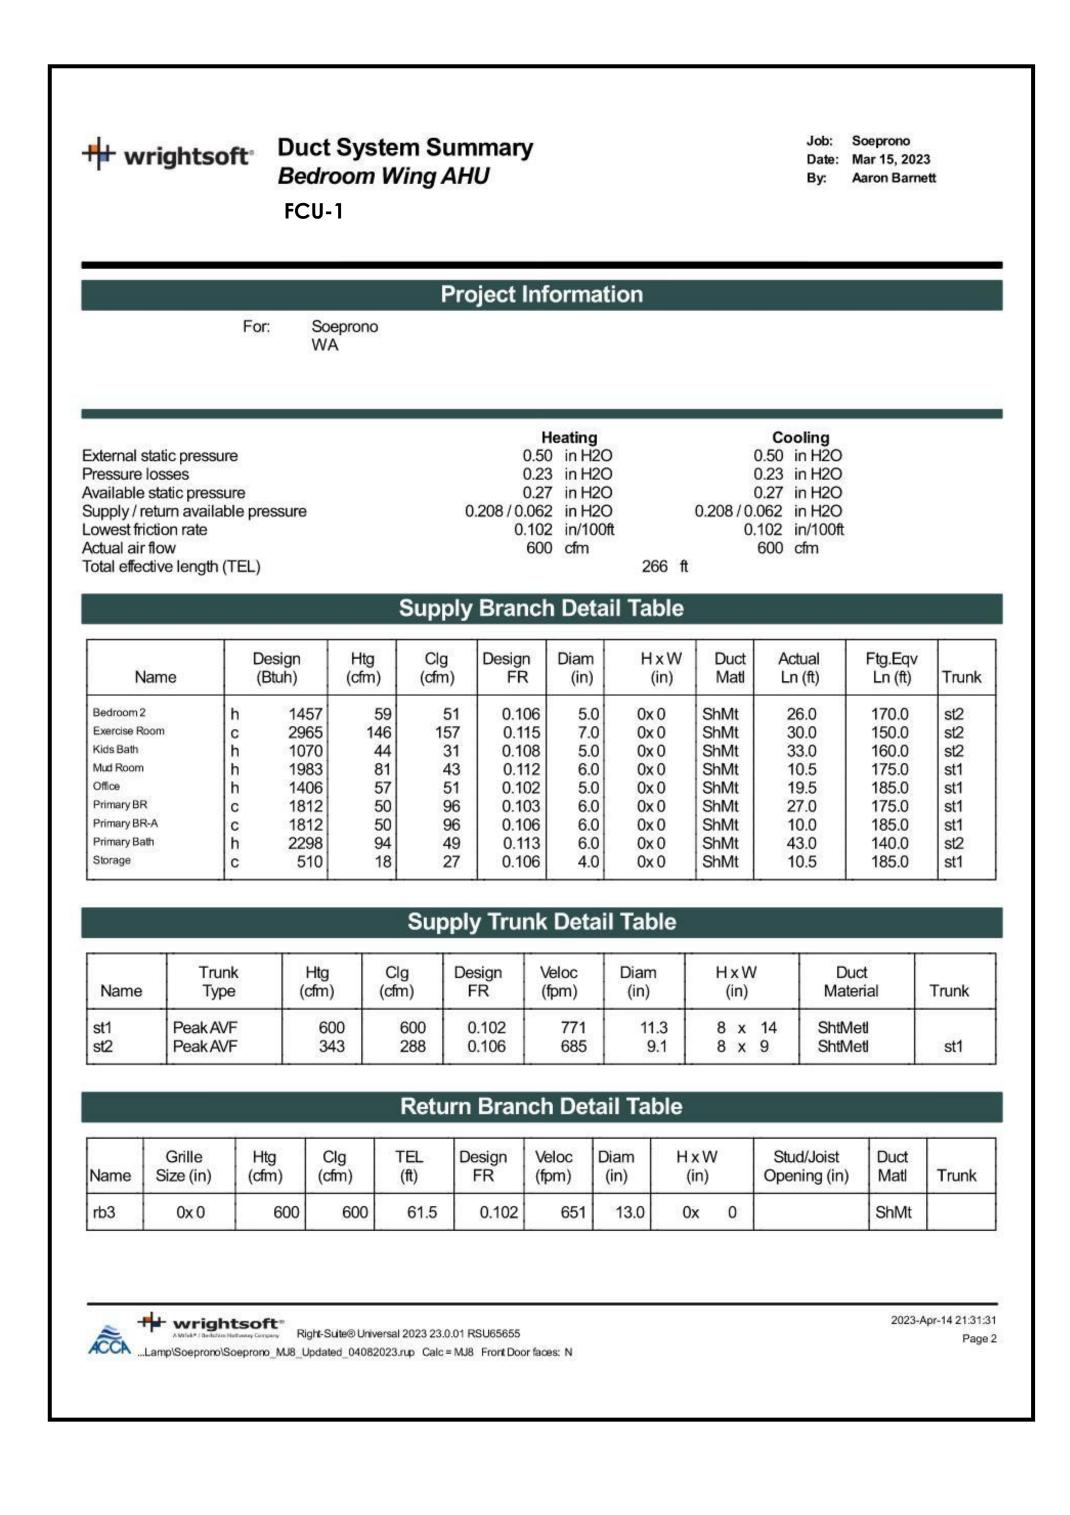

SALANCTION CONSULTING 9544 49th Ave NE Seattle, WA 98115 206-409-4948 Suite 300 /A 98040 Soeprono 75th Ave SE, S rcer Island, WA 2800 Mer

leat Pump System Details

Drawn By: Aaron Barnett 04/10/2023

M301