
SITE PLAN

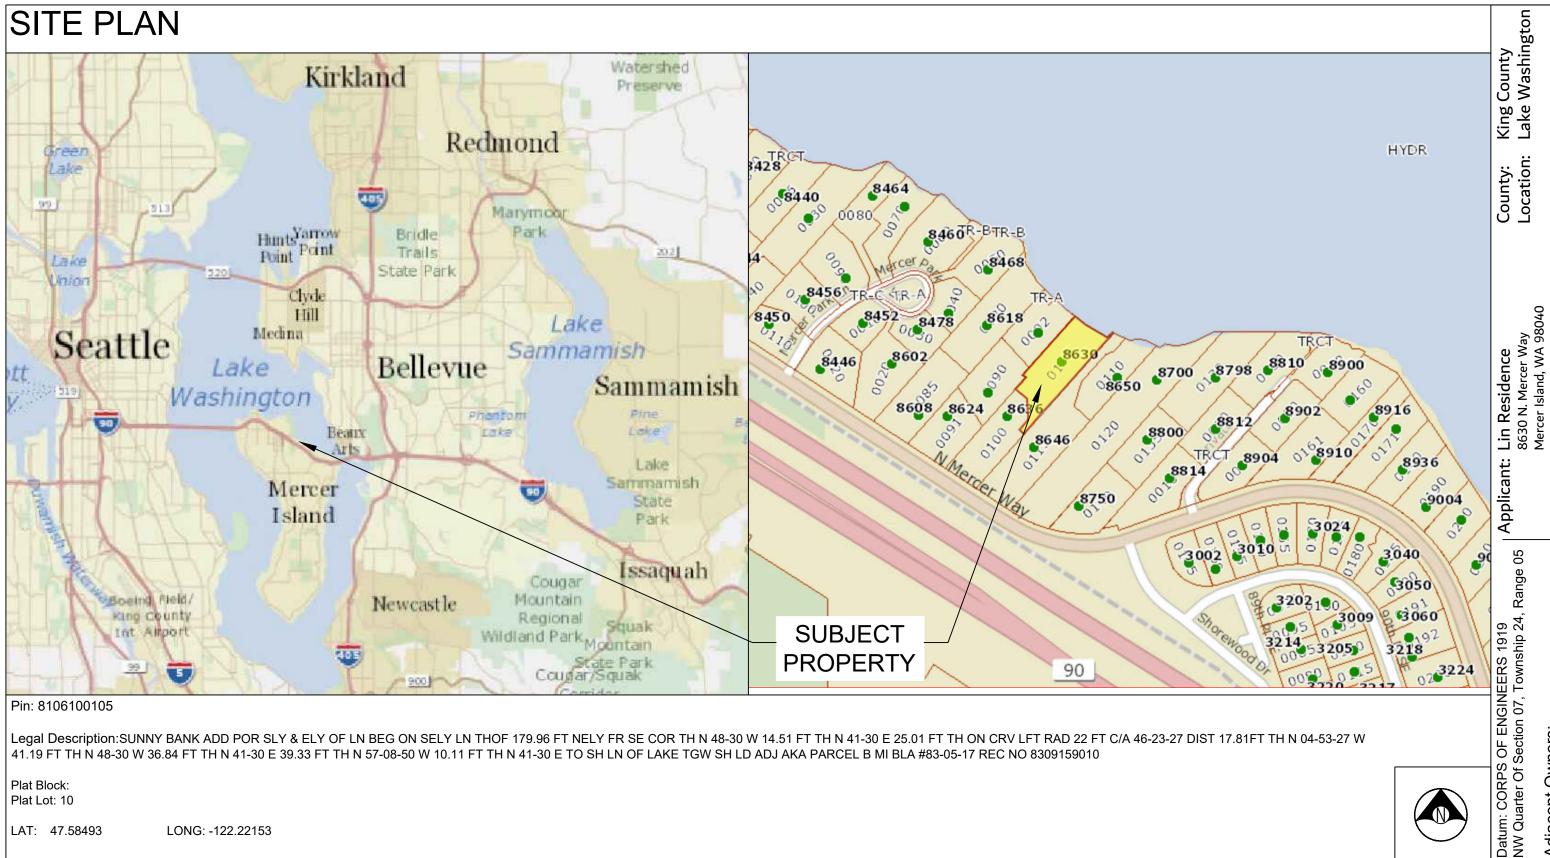

Pin: 8106100105

Legal Description:SUNNY BANK ADD POR SLY & ELY OF LN BEG ON SELY LN THOF 179.96 FT NELY FR SE COR TH N 48-30 W 14.51 FT TH N 41-30 E 25.01 FT TH ON CRV LFT RAD 22 FT C/A 46-23-27 DIST 17.81FT TH N 04-53-27 W 41.19 FT TH N 48-30 W 36.84 FT TH N 41-30 E 39.33 FT TH N 57-08-50 W 10.11 FT TH N 41-30 E TO SH LN OF LAKE TGW SH LD ADJ AKA PARCEL B MI BLA #83-05-17 REC NO 8309159010

Plat Block: Plat Lot: 10

LAT: 47.58493

LONG: -122.22153



ESTD 1947

Seaborn Pile Driving 1080 W Ewing St Seattle, WA 98119

Office: 206-236-1700 ext. 3 www.seabornpiledriving.com


Scope of Work: We propose to install (20) new 8" steel piles, permit (1) existing PWC lift, a walkway & extension with grated decking material. We will also install a platform lift, a boat lift and a dual jetskit lift.


SHEET A1.0


Adjacent (MORGAN MICHAEL


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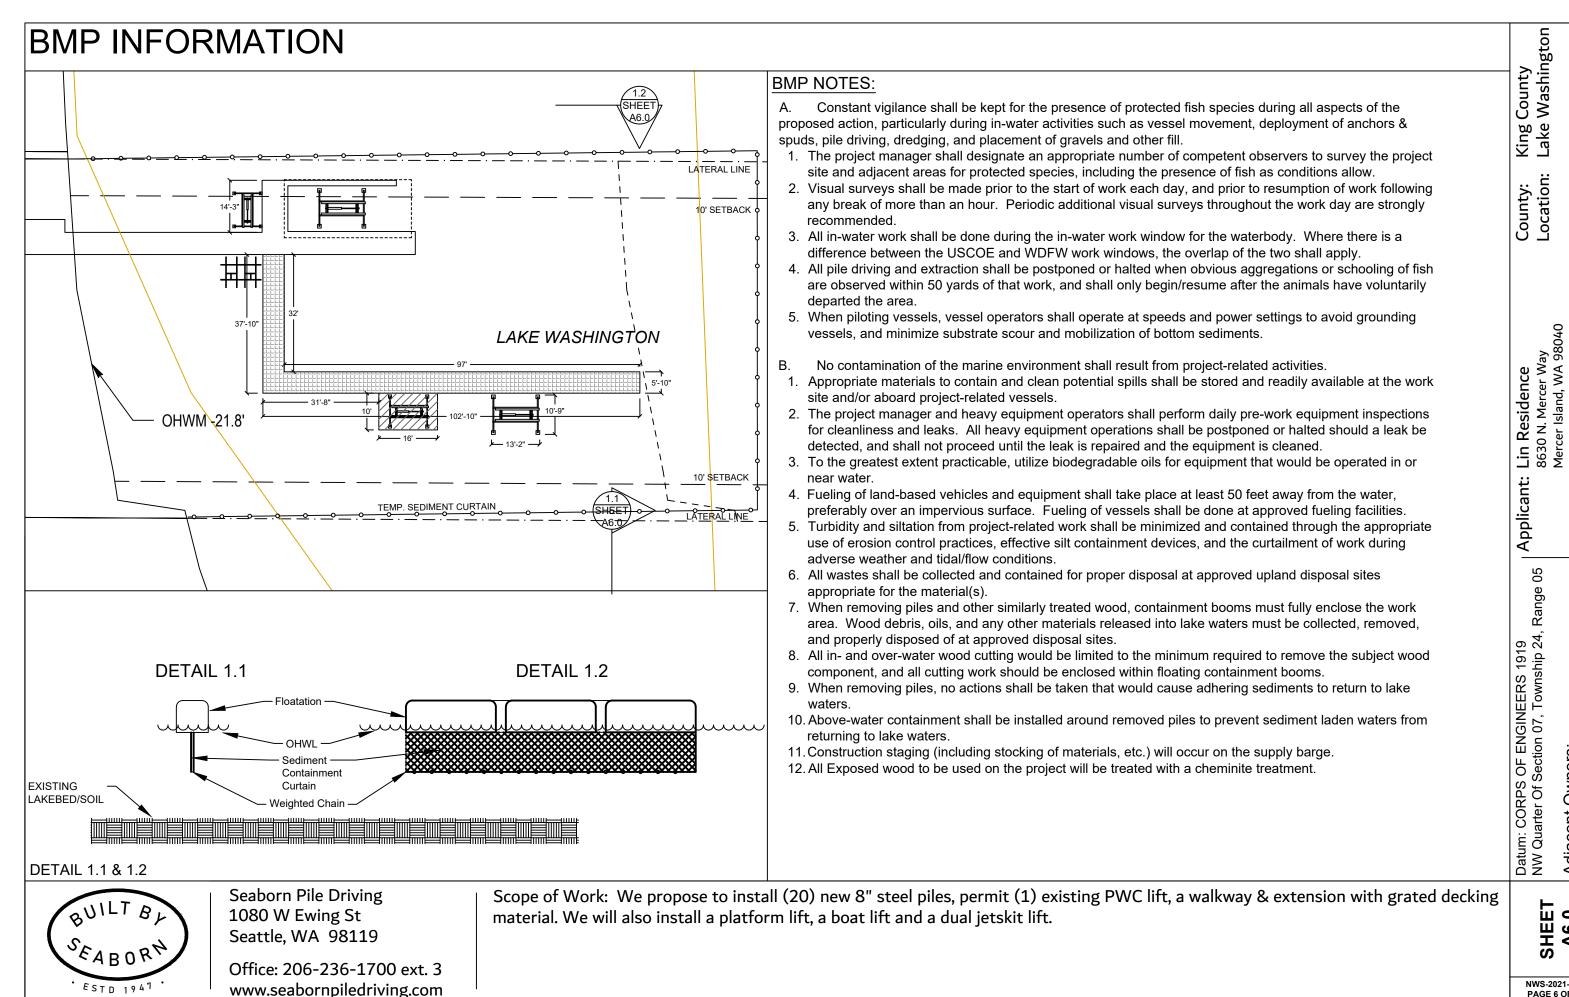
NWS-2021-XXX



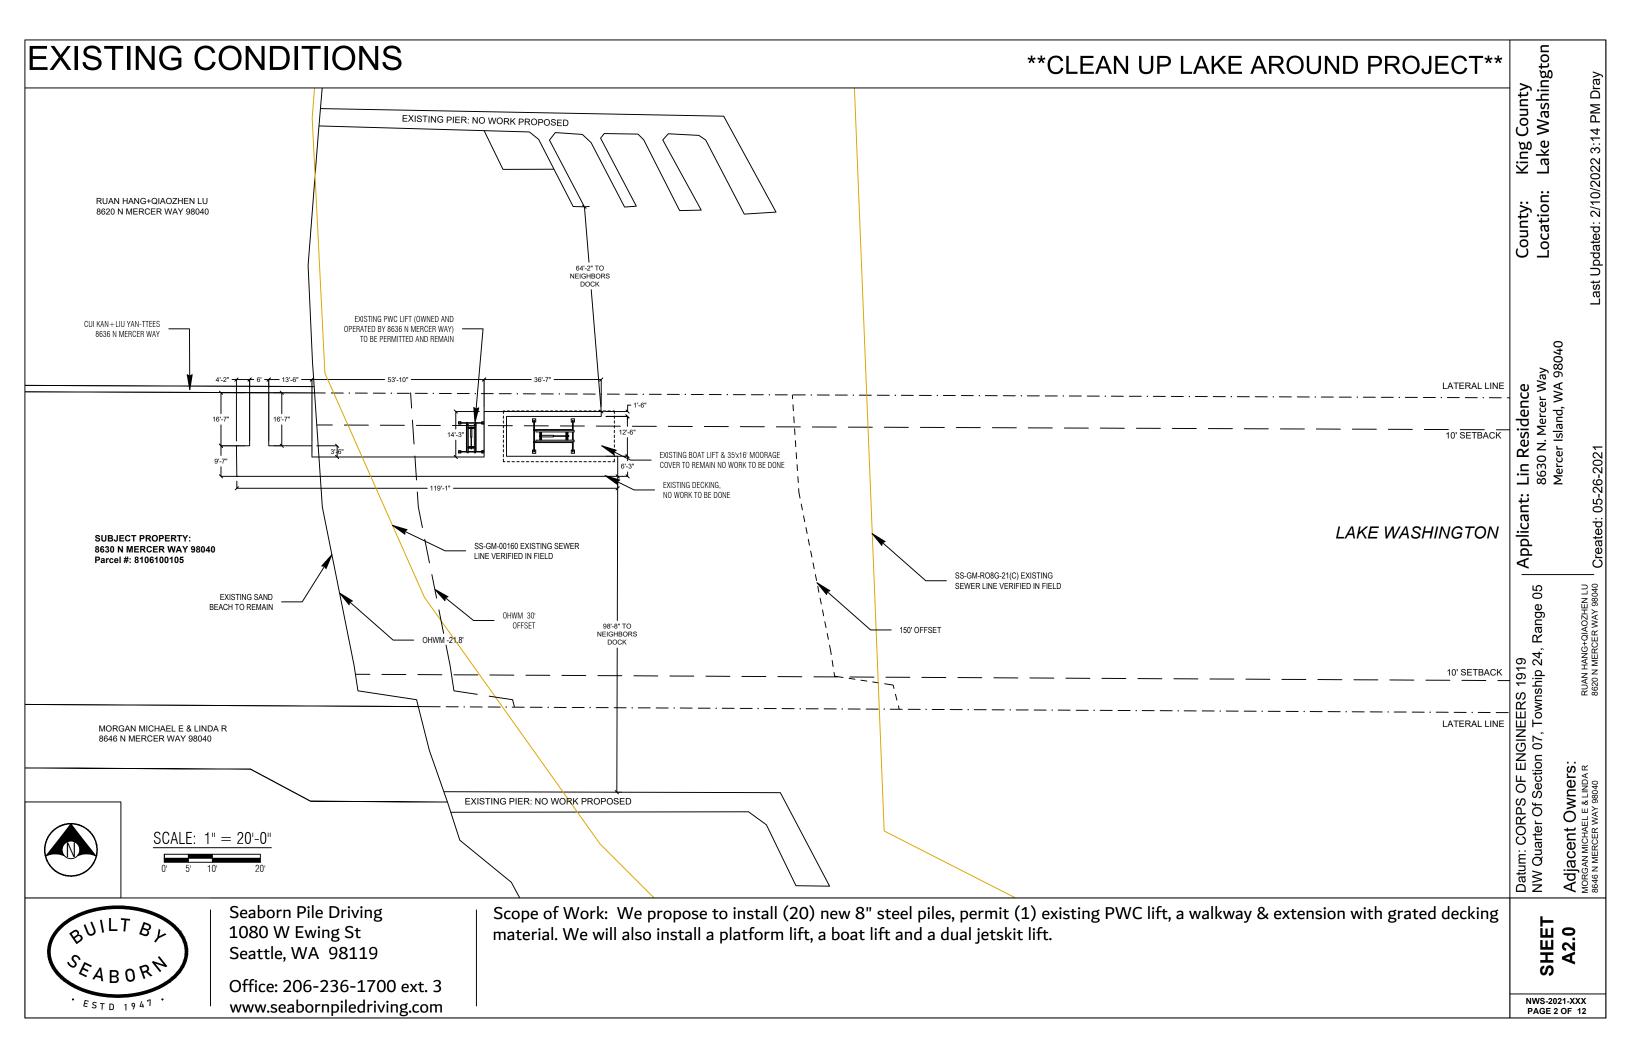

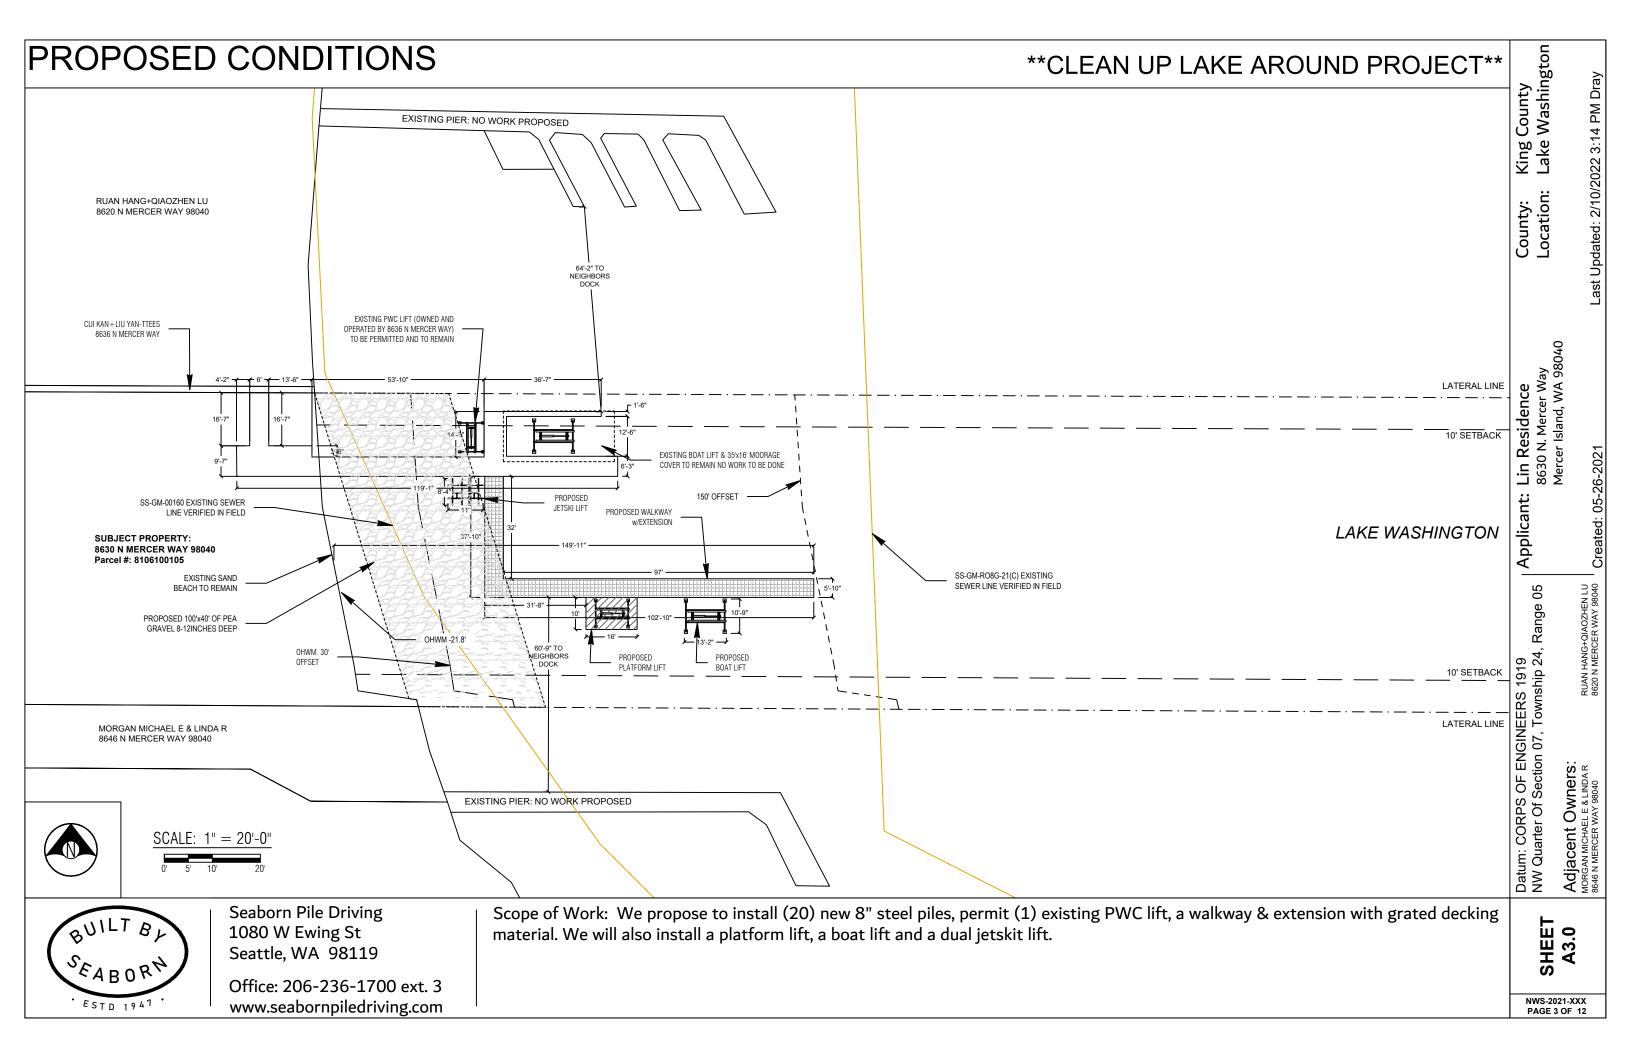

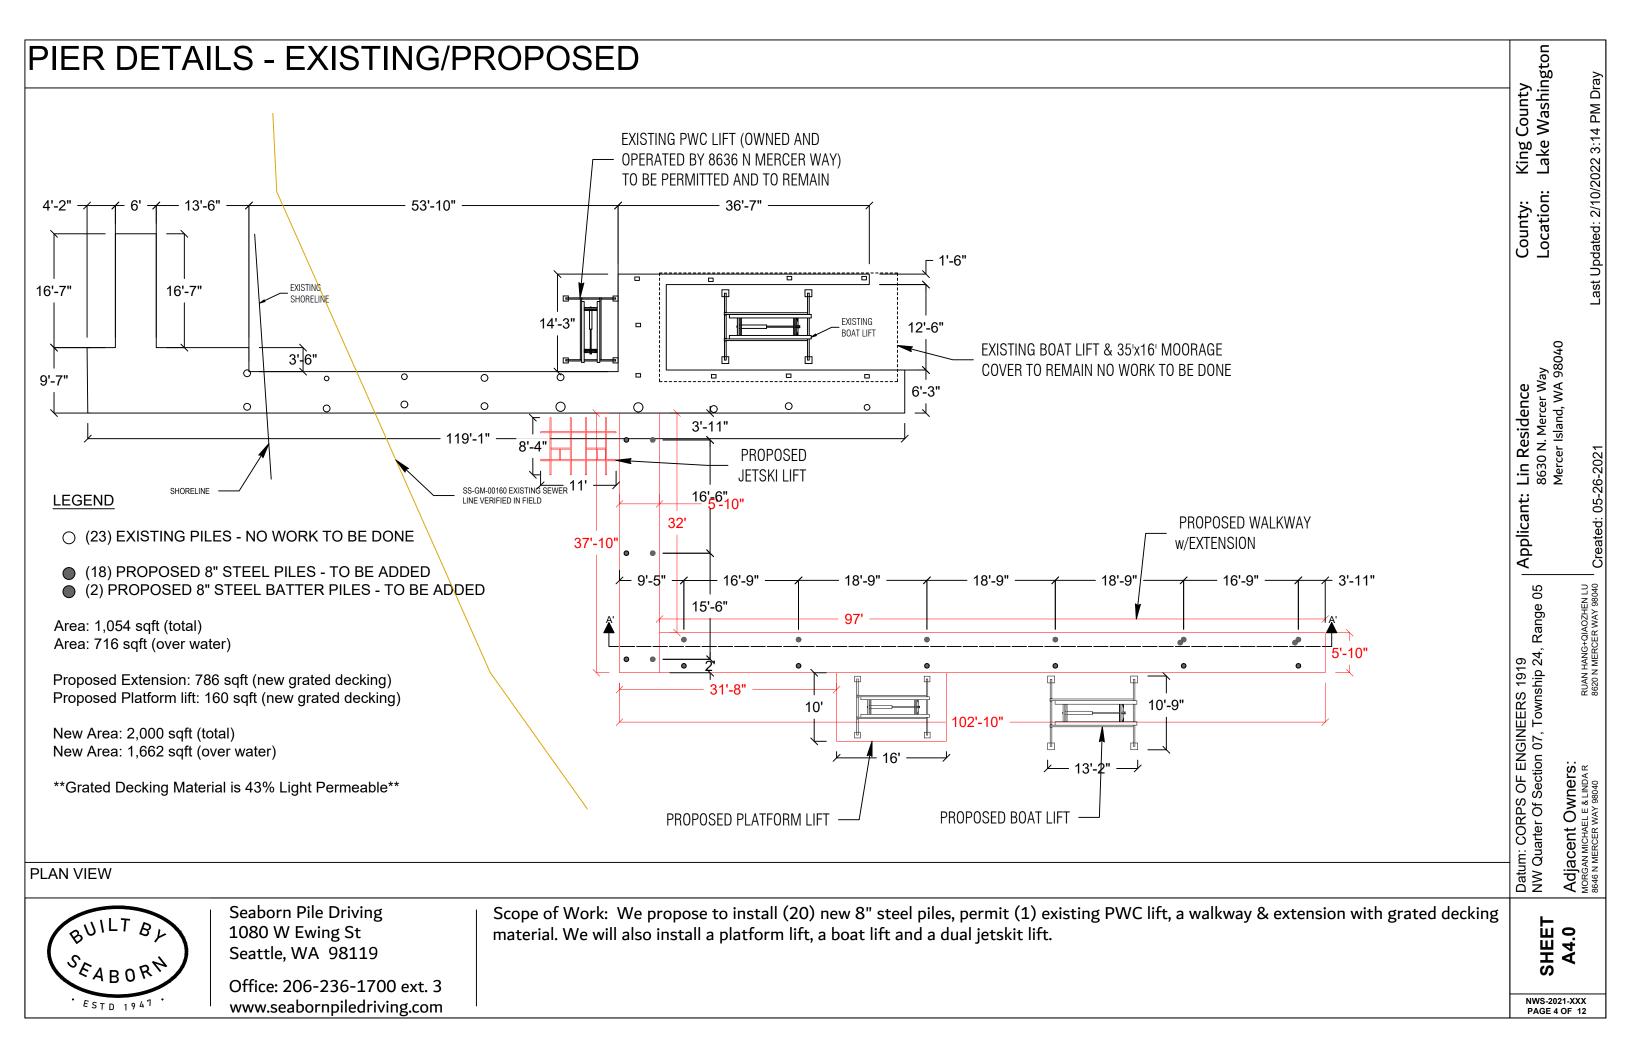

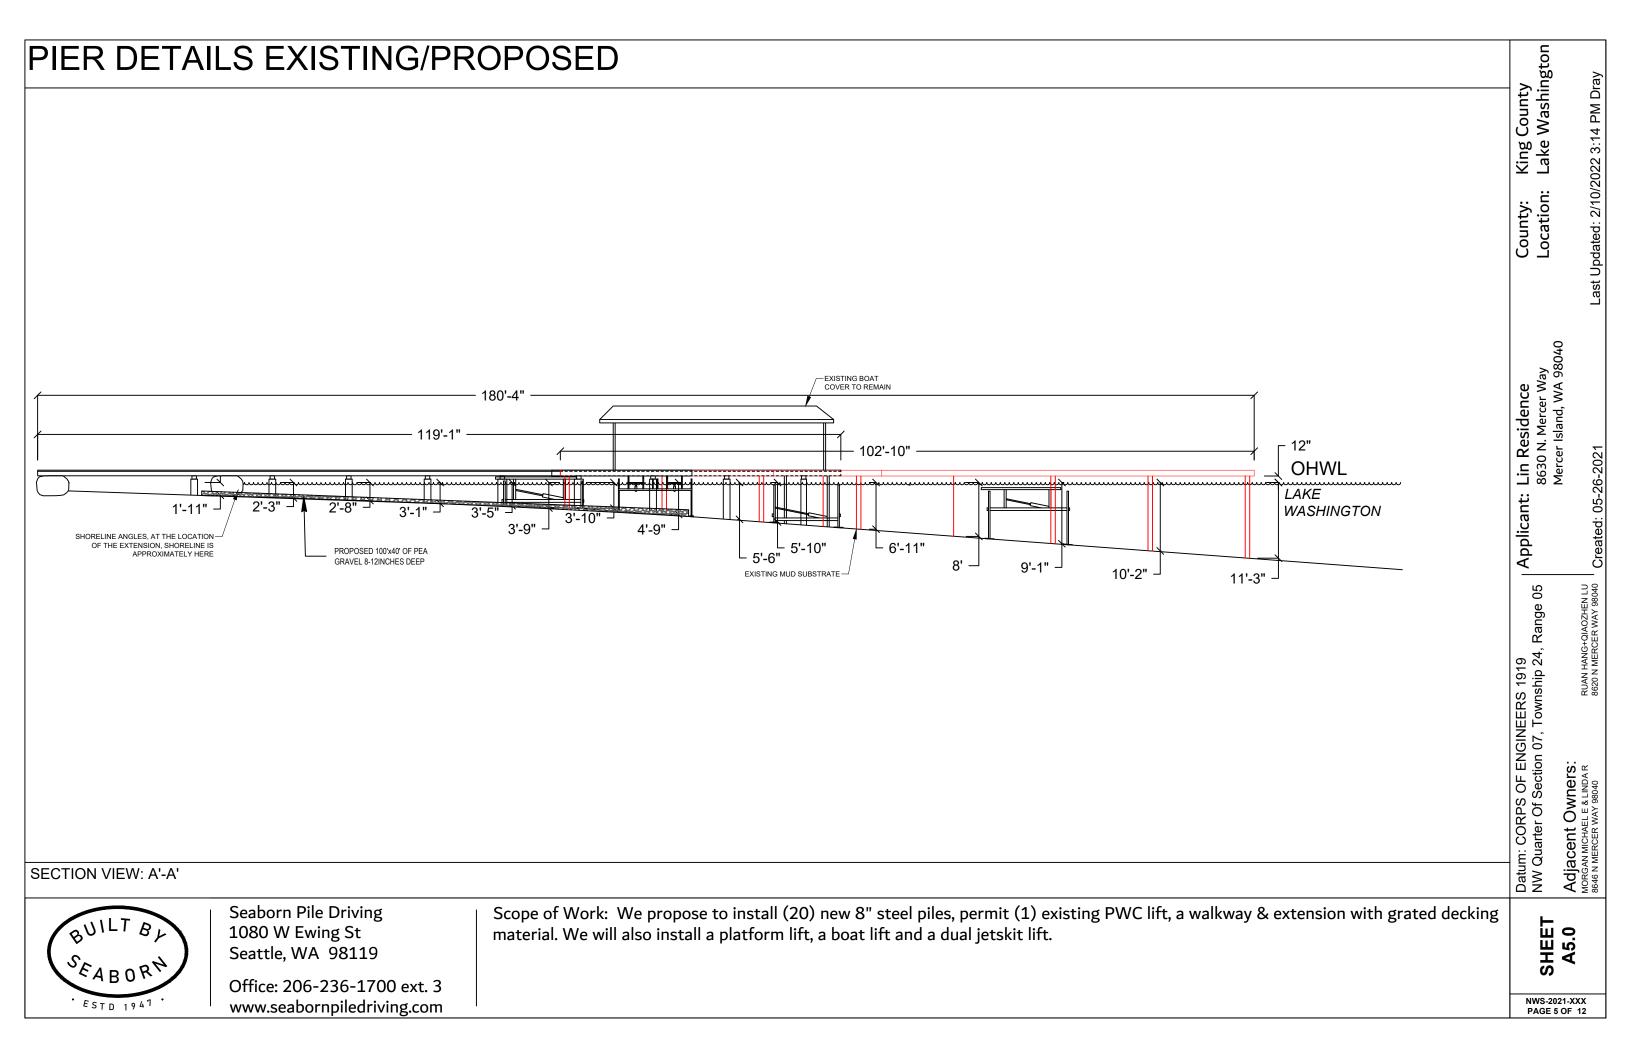

SHEET A6.0

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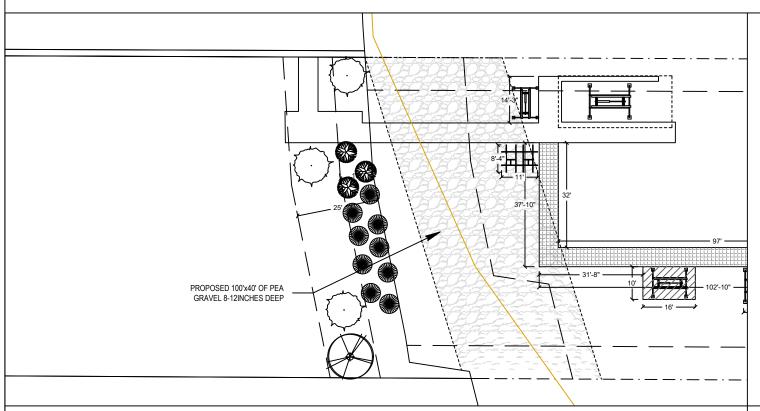
RUAN HANG+QIAOZHEN LU 8620 N MERCER WAY 98040


Owners:
AEL E & LINDA R
WAY 98040

Adjacent (MORGAN MICHAEL

NWS-2021-XXX

MITIGATION PLAN



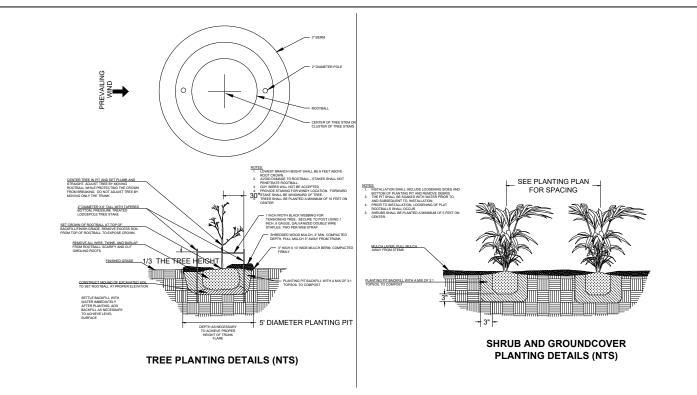

Notes:

- 1. Shrubs are show, and shall be planted, at least five feet on center. Trees are show, and shall be planted, at least ten feet to center.
- 2. The property owner will implement and abide by the shoreline planting plan. The plants shall be installed before or concurrent with the work authorized by this permit. A report, as-built drawing and photographs demonstrating the plants have been installed or a report on the status of project construction will be submitted to the U.S. Army Corps of Engineers, Seattle District, Regulatory Branch, within 12 months from the date of permit issuance. This reporting requirement may be met by completing and submitting a U.S. Army Corps of Engineers approved Report for Mitigation Work Completion form.
- 3. The property owner will maintain and monitor the survival of installed shoreline plantings for five years after the U.S. Army Corps of Engineers accepts the as-built report. Installed plants shall achieve 100% survival during monitoring Years 1 and 2. Installed plants shall achieve at least 80% survival during monitoring Years 3, 4 and 5. Percent survival is based on the total number of plants installed in accordance with the approved riparian planting plan. Individual plants that die will be replaced with native riparian species in order to meet the survival performance standards.
- 4. The property owner will provide annual monitoring reports for five years (Monitoring Years 1-5). Each annual monitoring report will include written and photographic documentation on plant mortality and replanting efforts and will document whether the performance standards are being met. Photos will be taken from established points and used repeatedly for each monitoring year. In addition to photos at designated points, photo documentation will include a panoramic view of the entire planting area. Submitted photos will be formatted on standard 8 1/2 x 11" paper, dated with the date the photo was taken, and clearly labeled with the direction from which the photo was taken. The photo location points will be identified on an appropriate drawing. Annual shoreline planting monitoring reports will be submitted to the U.S. Army Corps of Engineers, Seattle District, Regulatory Branch, by November 31 of each monitoring year. This reporting requirement may be met by completing and submitting a U.S. Army Corps of Engineers approved Mitigation Planting Monitoring Report form.

PROPOSED PLANTING SPECIES/QUANTITIES

SYMBOL	LATIN NAME	COMMON NAME	QTY	SIZE
	Thuja picatta	Western Redcedar	1	3 ft
	Rosa nutkana	Nootka Rose	3	1 Gallon
	Salix sitchensis	Sitka Willow	9	1 Gallon
\bigcirc	Salix lasiandra	Pacific Willow	3	3 ft

PLANTS: Shrubs to be installed 5ft on center and trees to be installed 10ft on center.

SEABORN

SEABORN

Seaborn Pile Driving 1080 W Ewing St Seattle, WA 98119

Office: 206-236-1700 ext. 3 www.seabornpiledriving.com

Scope of Work: We propose to install (20) new 8" steel piles, permit (1) existing PWC lift, a walkway & extension with grated decking material. We will also install a platform lift, a boat lift and a dual jetskit lift.

SHEET A7.0

Adjacent Owners:
MORGAN MICHAEL E & LINDA R
8646 N MERCER WAY 98040

King County Lake Washington


Lin Residence 8630 N. Mercer Way Mercer Island, WA 98040

Applicant:

Datum: CORPS OF ENGINEERS 1919 NW Quarter Of Section 07, Township 24, Range 05 3:14 PM Dray

-ast Updated: 2/10/2022

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GENERAL NOTES:

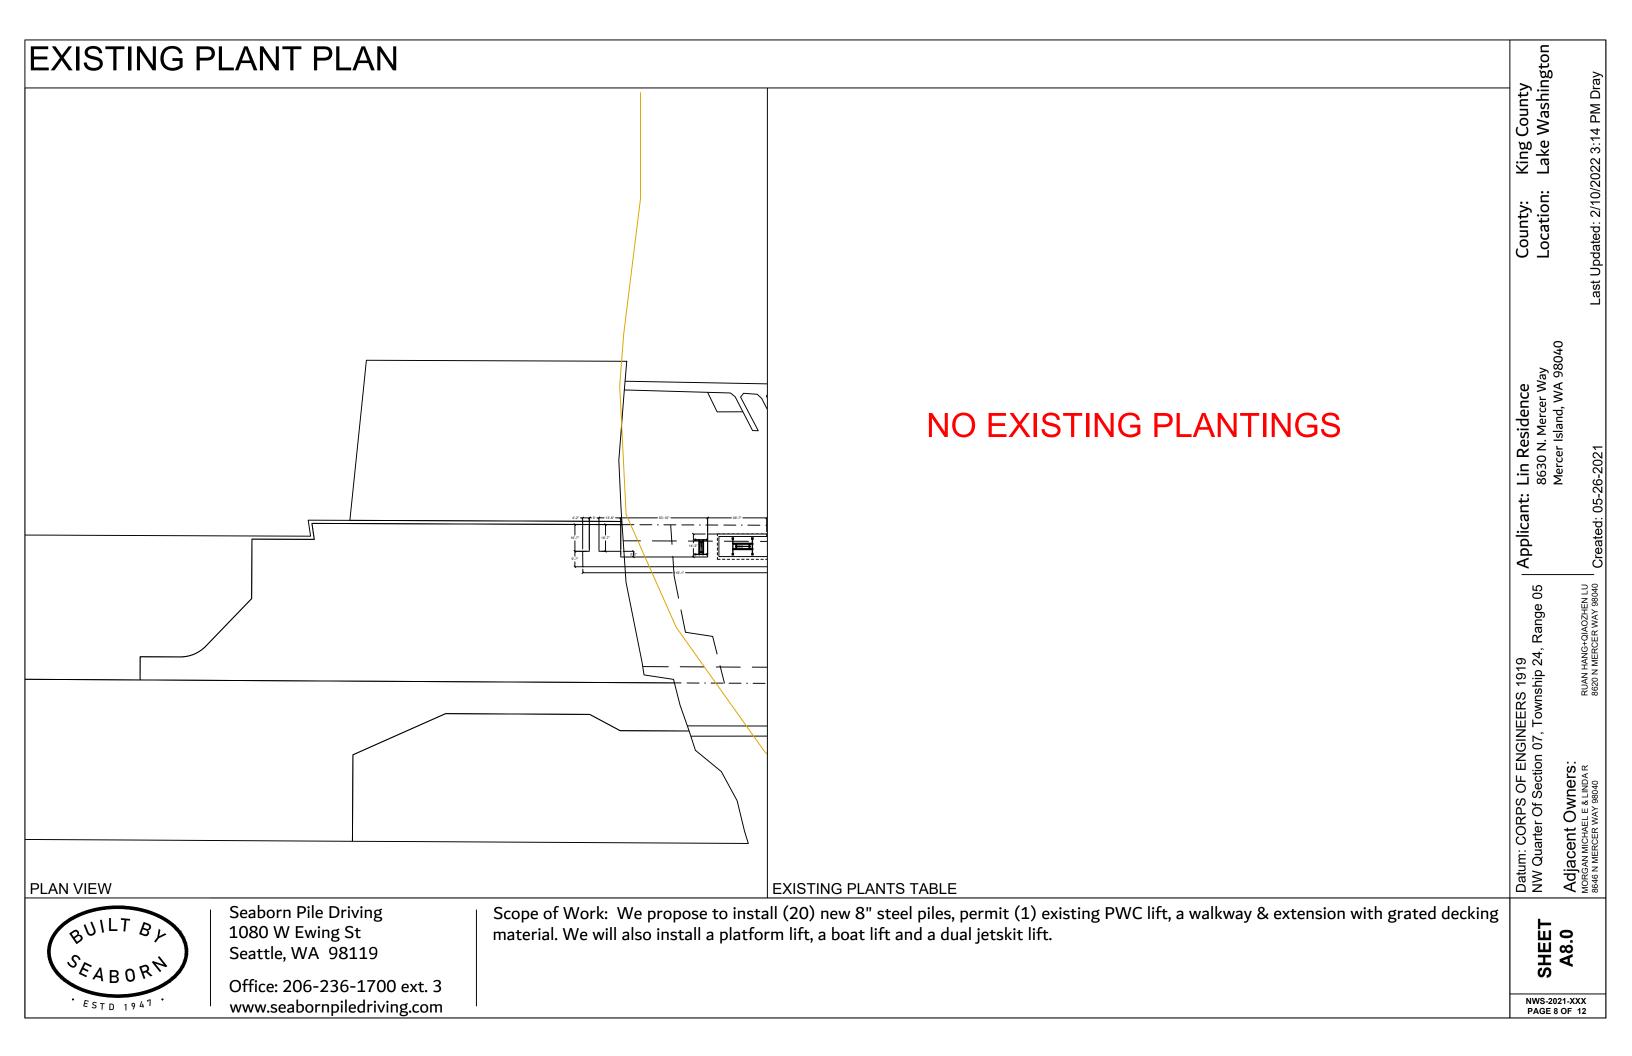MATERIALS SPEC LIST:

Boat Lifts:

- * SL10014ARW 158" x 129"
- * SL8012ARW 120" x 192"
- * SL2008AR2D2 100" x 132" (dual jet ski)
- * New canopy covers will be constructed with translucent material

Thruflow Decking Material: FRPP - Fiberglass reinforced polypropylene Light permeable percentage:

- * Surface 43%
- * 18" Dock Height 61%

PILES:

* All new piles are epoxy coated Steel piles *size varies, see plan set

SEWER:

* All sewer is field verified by probing the lake bed manually during the allowed work windows for the area.

CODE REFERENCES: Mercer Island

We are applying for the permit to be reviewed under the:

"Development Standards for New and Expanded Moorage Facilities" per MIMC 19.13050(F)(1).

"Alternative Development Standards" per MIMC 19.13050(F)(3).

Mitigation Disturbance of bank vegetation shall be limited to the minimum amount necessary to accomplish the project. Disturbed bank vegetation shall be replaced with native, locally adapted herbaceous and/or woody vegetation. Herbaceous plantings shall occur within 48 hours of the completion of construction. Woody vegetation components shall be planted in the fall or early winter, whichever occurs first. The applicant shall take appropriate measures to ensure revegetation success;

Last permit issued for property: BLDG Permit

Dock established/constructed: 1959 Sewer Easement

SEABORN . ESTD 1941.

Seaborn Pile Driving 1080 W Ewing St Seattle, WA 98119

Office: 206-236-1700 ext. 3 www.seabornpiledriving.com

Scope of Work: We propose to install (20) new 8" steel piles, permit (1) existing PWC lift, a walkway & extension with grated decking material. We will also install a platform lift, a boat lift and a dual jetskit lift.

SHEET A9.0

Adjacent (MORGAN MICHAEL

Datum: CORPS OF ENGINEERS 1919 NW Quarter Of Section 07, Township 24, Range 05

King County Lake Washington

Applicant: Lin Residence 8630 N. Mercer Way Mercer Island, WA 98040 ast Updated: 2/10/2022 3:14 PM Dray

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GENERAL

- 1. ALL CONSTRUCTION SHALL CONFORM TO THESE PLANS.
- 2. CONTRACTOR SHALL VERIFY ALL LEVELS, DIMENSIONS, AND EXISTING CONDITIONS IN THE FIELD BEFORE PROCEEDING. CONTRACTOR SHALL NOTIFY THE ENGINEER OF ANY DISCREPANCIES OR FIELD CHANGES PRIOR TO INSTALLATION OR FABRICATION. IN CASE OF DISCREPANCIES BETWEEN THE EXISTING CONDITIONS AND THE DRAWINGS, THE CONTRACTOR SHALL OBTAIN DIRECTION FROM THE ENGINEER BEFORE PROCEEDING. DIMENSIONS NOTED AS PLUS OR MINUS (±) OR REF INDICATE UNVERIFIED DIMENSIONS AND ARE APPROXIMATE. NOTIFY ENGINEER IMMEDIATELY OF CONFLICTS OR EXCESSIVE VARIATIONS FROM INDICATED DIMENSIONS, NOTED DIMENSIONS TAKE PRECEDENCE OVER SCALED DIMENSIONS - DO NOT SCALE DRAWINGS. DIMENSIONS OF EXISTING CONDITIONS ARE BASED ON RECORD DRAWINGS AND ARE TO BE FIELD-VERIFIED BY THE CONTRACTOR.
- CONTRACTOR SHALL PROVIDE ADEQUATE SHORING AND BRACING OF ALL STRUCTURAL MEMBERS AND EXISTING MEMBERS, AS REQUIRED, AND IN A MANNER SUITABLE TO WORK SEQUENCE. TEMPORARY SHORING AND BRACING SHALL NOT BE REMOVED UNTIL ALL FINAL CONNECTIONS HAVE BEEN COMPLETED IN ACCORDANCE WITH THE DRAWINGS AND MATERIALS HAVE ACHIEVED DESIGN STRENGTH.
- CONTRACTOR SHALL BE RESPONSIBLE FOR ALL SAFETY PRECAUTIONS AND THE METHODS. TECHNIQUES. SEQUENCES AND PROCEDURES REQUIRED TO PERFORM THE WORK.
- 5. ALL MATERIALS SHALL BE NEW, UNO.
- 6. ALL WORK SHALL BE PERFORMED IN STRICT ACCORDANCE WITH THE DRAWINGS, NOTES. AND MANUFACTURER RECOMMENDATIONS. IF THERE ARE ANY CONFLICTS BETWEEN THESE DOCUMENTS. THE ENGINEER SHALL BE CONTACTED FOR DIRECTION.
- THE CONTRACTOR SHALL CAREFULLY DECONSTRUCT EXISTING ELEMENTS AS NECESSARY TO ACCESS THE WORK AREAS. SUCH DECONSTRUCTION MAY INCLUDE, INTERIOR AND EXTERIOR FINISHES. ALL DECONSTRUCTION ELEMENTS SHALL BE RECONSTRUCTED TO MATCH THE ORIGINAL APPEARANCE AND MEET THE REQUIREMENTS OF THE INTERNATIONAL BUILDING CODE.
- 8. ALL BOAT COVERS AND LIFTS SHALL BE FREESTANDING AND SHALL NOT BE ATTACHED TO THE DOCK, UNLESS NOTED OTHERWISE.

CODES AND STANDARDS

- ALL METHODS AND MATERIALS SHALL CONFORM TO THE INTERNATIONAL BUILDING CODE, 2018 EDITION.
- 2. AMERICAN SOCIETY OF CIVIL ENGINEERS STANDARD 7-16 (ASCE) MINIMUM DESIGN LOADS FOR BUILDINGS AND OTHER STRUCTURES.
- WOOD WORK SHALL CONFORM TO THE NATIONAL DESIGN SPECIFICATION (NDS) 2018
- AMERICAN SOCIETY FOR TESTING AND MATERIALS, CURRENT EDITION

DESIGN CRITERIA

WIND LOAD IS BASED ON ASCE CHAPTER 29 WITH THE FOLLOWING WIND DESIGN:

 $EXPOSURE\ CATEGORY = D$ RISK CATEGORY = IIWIND IMPORTANCE FACTOR, $I_{W} = 1.0$ $V_{3S} = 98MPH$

VESSEL: LENGTH = 50 FTFREEBOARD = 15 FT

WAVE LOADS: P = 328 LBS

LIVE LOADS: LIVE LOAD = 40 PSFSNOW LOAD = 25 PSF

SEISMIC LOADS: DOCK PILING R = 2.0SEISMIC IMPORTANCE - 1.0

SD1 = 0.613q

STRUCTURAL STEEL

- 1. ALL MISCELLANEOUS STEEL SHAPES AND PLATES, EXCEPT AS NOTED BELOW. SHALL CONFORM TO ASTM 36.
- 2. ALL WF SHAPES SHALL CONFORM TO ASTM A992, Fy = 50 KSI
- 3. ALL PILES SHALL CONFORM TO ASTM A252 GRADE 3, Fy = 45 KSI
- 4. ALL BOLTS SHALL BE ASTM A307, UNO.
- 5. ALL NUTS SHALL BE ASTM A563, UNO.
- 6. ALL WASHERS SHALL BE ASTM F436, UNO.
- 7. ALL THREADED RODS SHALL CONFORM TO ASTM F155, GRADE 36.
- 8. ALL STEEL MEMBERS AND FASTENERS THAT ARE NOT COATED SHALL BE HOT DIPPED GALVANIZED IN ACCORDANCE WITH ASTM A153 AS APPLICABLE.

WELDING

- 1. ALL WELDING SHALL PERFORMED BY WELDERS QUALIFIED FOR THE WELD AND POSITION SHOWN IN ACCORDANCE WITH AWS AND HAVING CURRENT CERTIFICATION FROM WABO.
- 2. ALL WELDS SHALL BE PERFORMED WITH PROCEDURES PREQUALIFIED OR QUALIFIED IN ACCORDANCE WITH AWS D1.1.
- 3. THE WELDS SHOWN ARE FOR THE FINAL CONNECTIONS, FIELD WELD SYMBOLS ARE SHOWN WHERE FIELD WELDS ARE REQUIRED BY THE STRUCTURAL DESIGN. THE CONTRACTOR IS RESPONSIBLE FOR DETERMINING IF A WELD SHOULD BE SHOP OR FIELD WELDED IN ORDER TO FACILITATE THE STRUCTURAL STEEL ERECTION.
- 4. WELDING ELECTRODES SHALL BE 70 KSI STRENGTH AND SHALL BE "LOW-HYDROGEN ELECTRODES."

WOOD

- 1. EACH PIECE OF LUMBER SHALL BEAR A STAMP INDICATING A GRADE MARK OF THE WEST COAST LUMBER INSPECTION BUREAU (WCLIB), WESTERN WOOD PRODUCTS ASSOCIATION (WWPA), OR OTHER AGENCY ACCREDITED BY THE AMERICAN STANDARD COMMITTEE (ALSC).
- 2. DIMENSION LUMBER SHALL BE P.T. DOUG-FIR NO 2 OR BETTER.
- 3. STRUCTURAL GLUED LAMINATED TIMBER SHALL BE AC.AC 20F-V12.
- 4. WOOD SHALL BE SEASONED DRY WITH A MAXIMUM MOISTURE CONTENT OF 19%.
- 5. PRESERVATIVE TREATED WOOD SHALL CONFORM TO THE AMERICAN WOOD PROTECTION ASSOCIATION (AWPA) UC4A. ALL WOOD SHALL BEAR A TREATMENT IDENTIFICATION MARK BY THE CERTIFYING AGENCY.
- 6. ALL BOLT HOLES IN WOOD MEMBERS SHALL BE A MINIMUM OF 1/32" TO MAXIMUM OF 1/16" LARGER THAN THE BOLT DIAMETER. PROVIDE PLATE WASHERS WHERE NUTS BEAR ON WOOD. CUT WASHERS SHALL MEASURE 2 1/4"ø x 3/16" THICK.

DECKING

1. GRATED DECKING SHALL BE SUNWALK 90 SERIES OR APPROVED EQUAL.

SPECIAL INSPECTION

1. ALL FULL PENETRATION WELDS SHALL BE UT TESTED BY A CERTIFIED TESTING

ABBEVIATIONS

AMERICAN WELDING SOCIETY CENTER LINE **CLR** CLEAR COL COLUMN CONT CONTINUOUS DOUG FIR EACH **EXISTING** EX OR (E) GLULAM BEAM LONG LEG HORIZONTAL MINIMUM MANUFACTURER ON CENTER PLATE POUNDS PER SQUARE INCH POUNDS PER SQUARE FOOT PRESERVATIVE TREATED SQUARE FOOT REFERENCE SS STAINLESS STEEL THICK TYP TYPICAL **UNO** UNLESS NOTED OTHERWISE VIF VERIFY IN FIELD


WABO WASHINGTON ASSOCIATION OF BUILDING OFFICIALS

WIDE FLANGE

W/

Tacoma, Washington 98407

(253) 396-0150 Fax (253) 396-0162

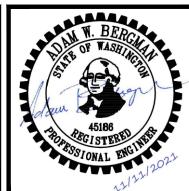

	NO.	DATE	BY	REVISION
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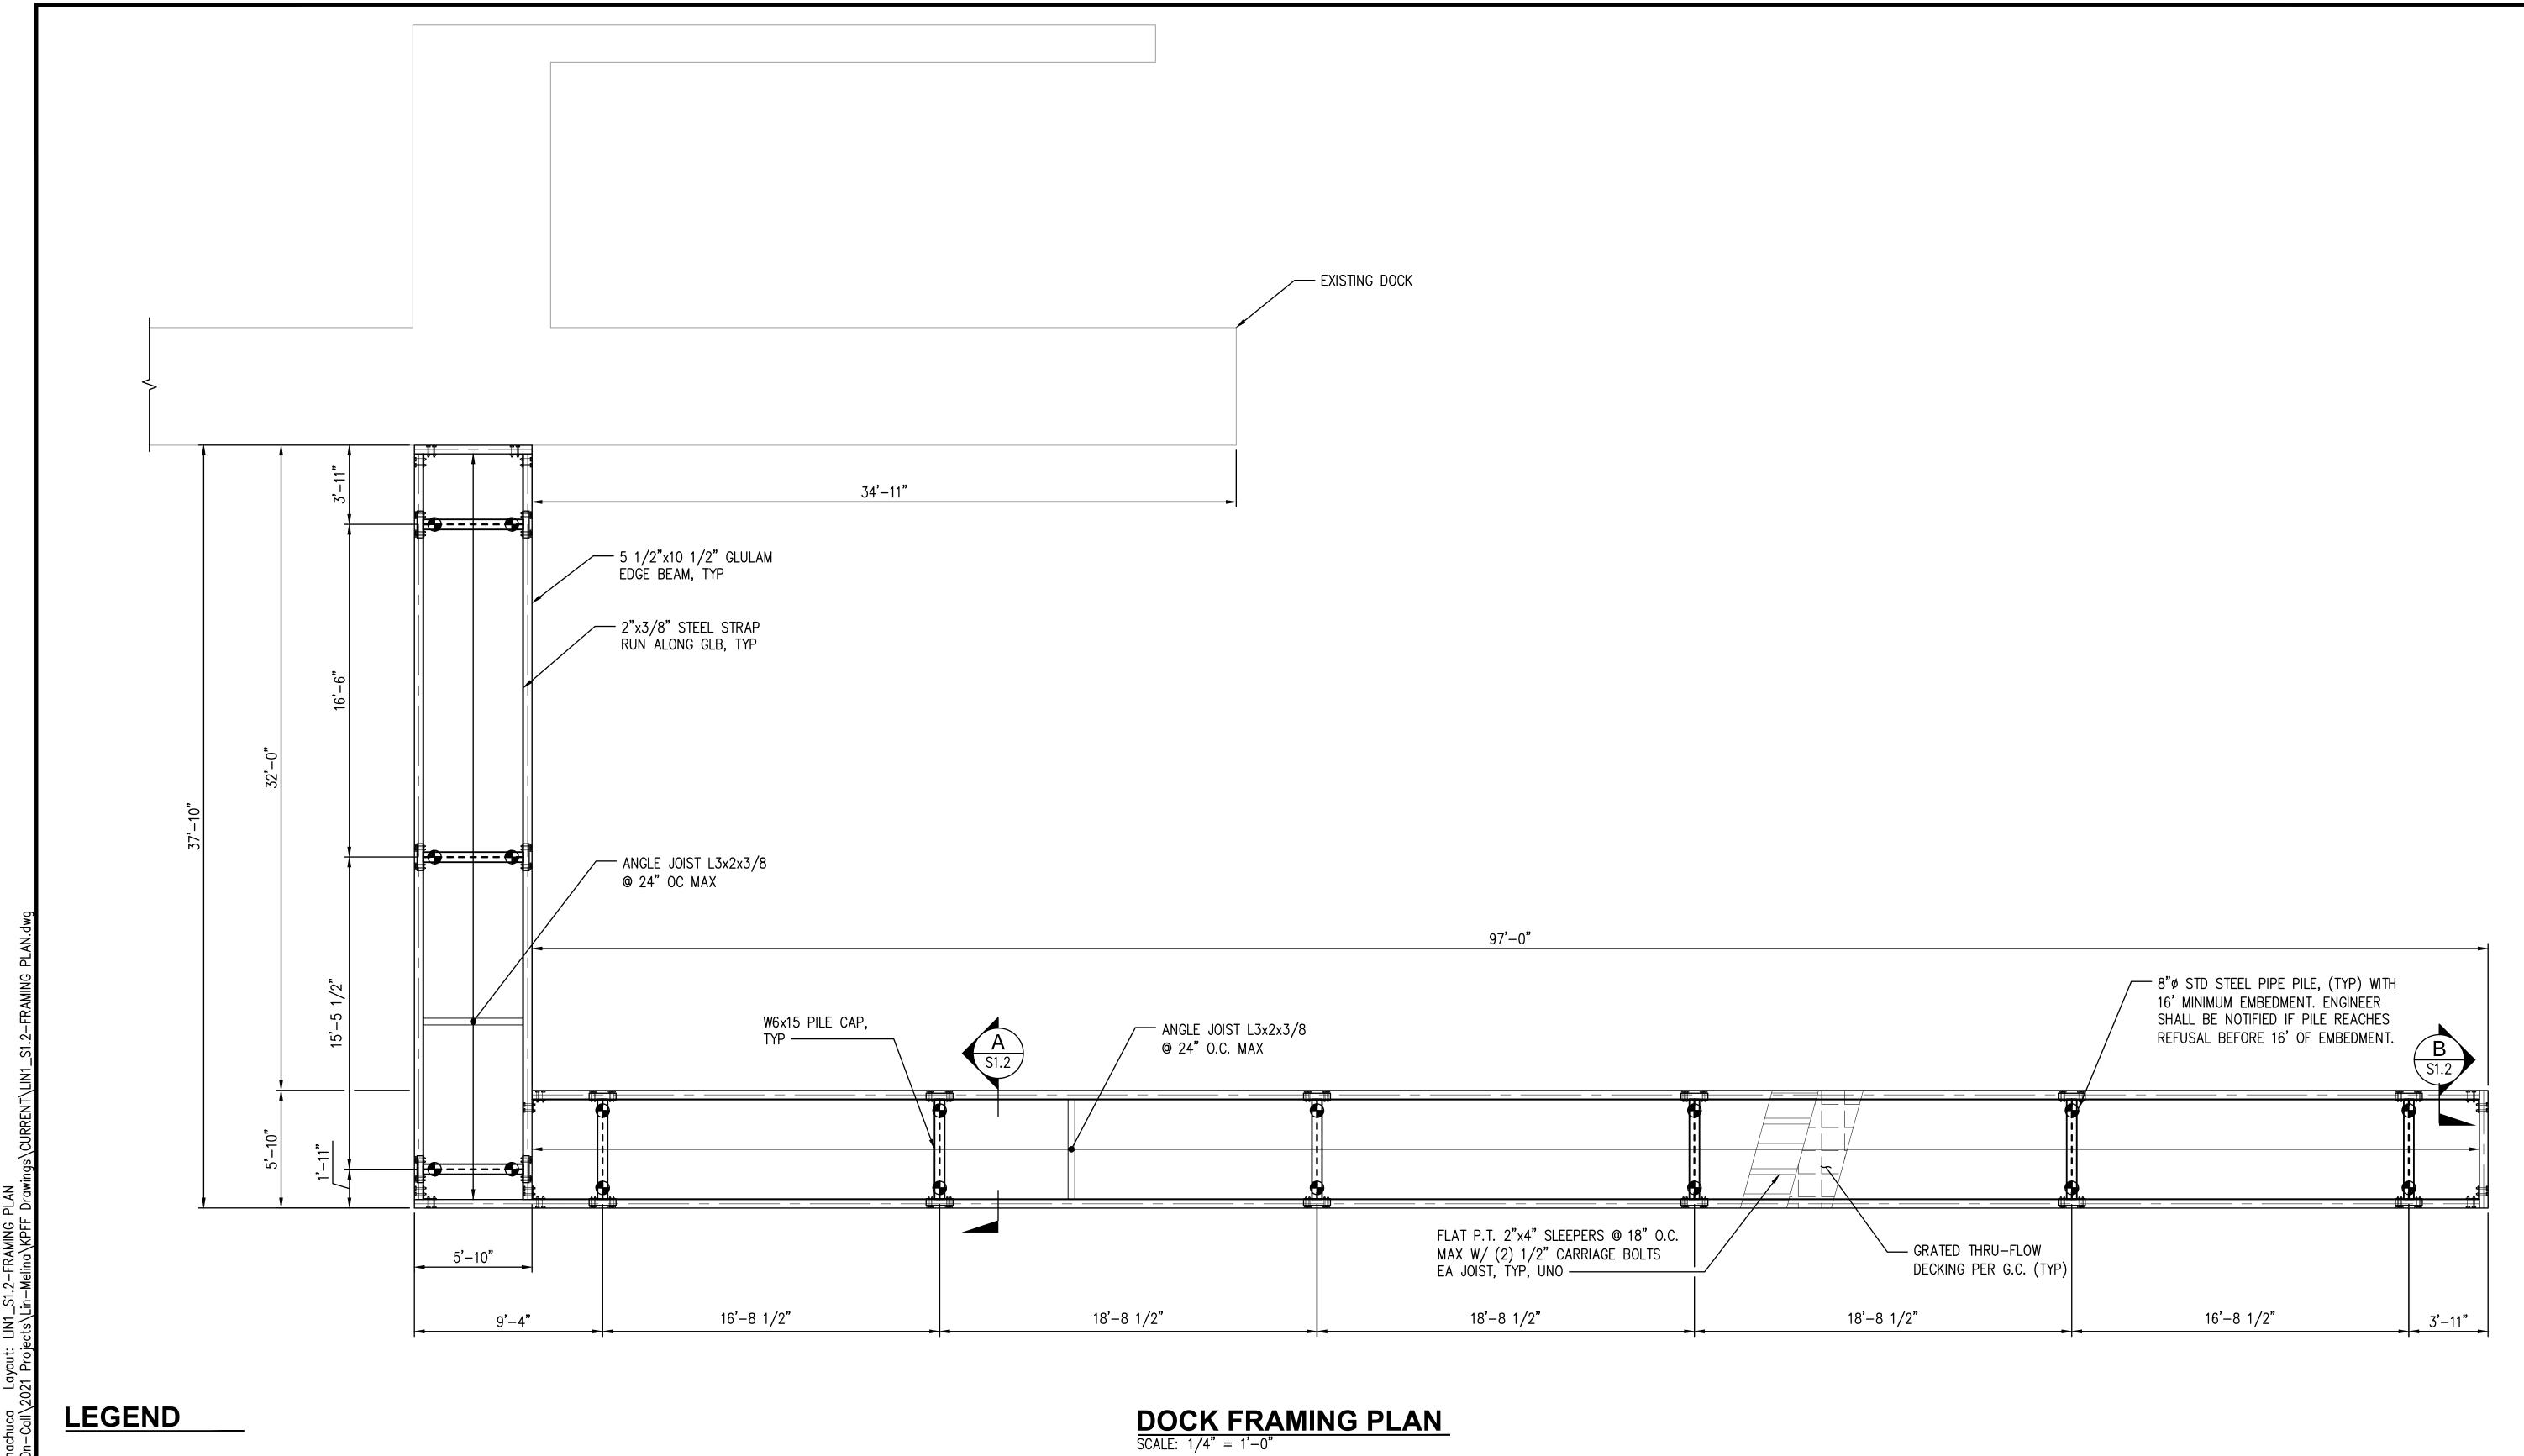
LIN RESIDENCE 8630 N. MERCER WAY MERCER ISLAND, WA 98040

STRUCTURAL NOTES

DRAWING N	١٥.	S1.1
CHECKED:	AWB	DATE: 11-11-2021
DESIGN:	DMR	SCALE: AS SHOWN
DRAWN:	GM	PROJECT NO.: 2100134


SHEET NO.

01 OF 03



PROPOSED 8"Ø STEEL PIPE PILES

2407 North 31st Street, Suite 100 Tacoma, Washington 98407 (253) 396-0150 Fax (253) 396-0162

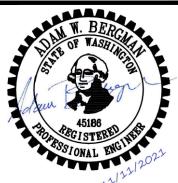

W. BERC	NO.	DATE	BY	REVISION
DATE OF WASHINGS				
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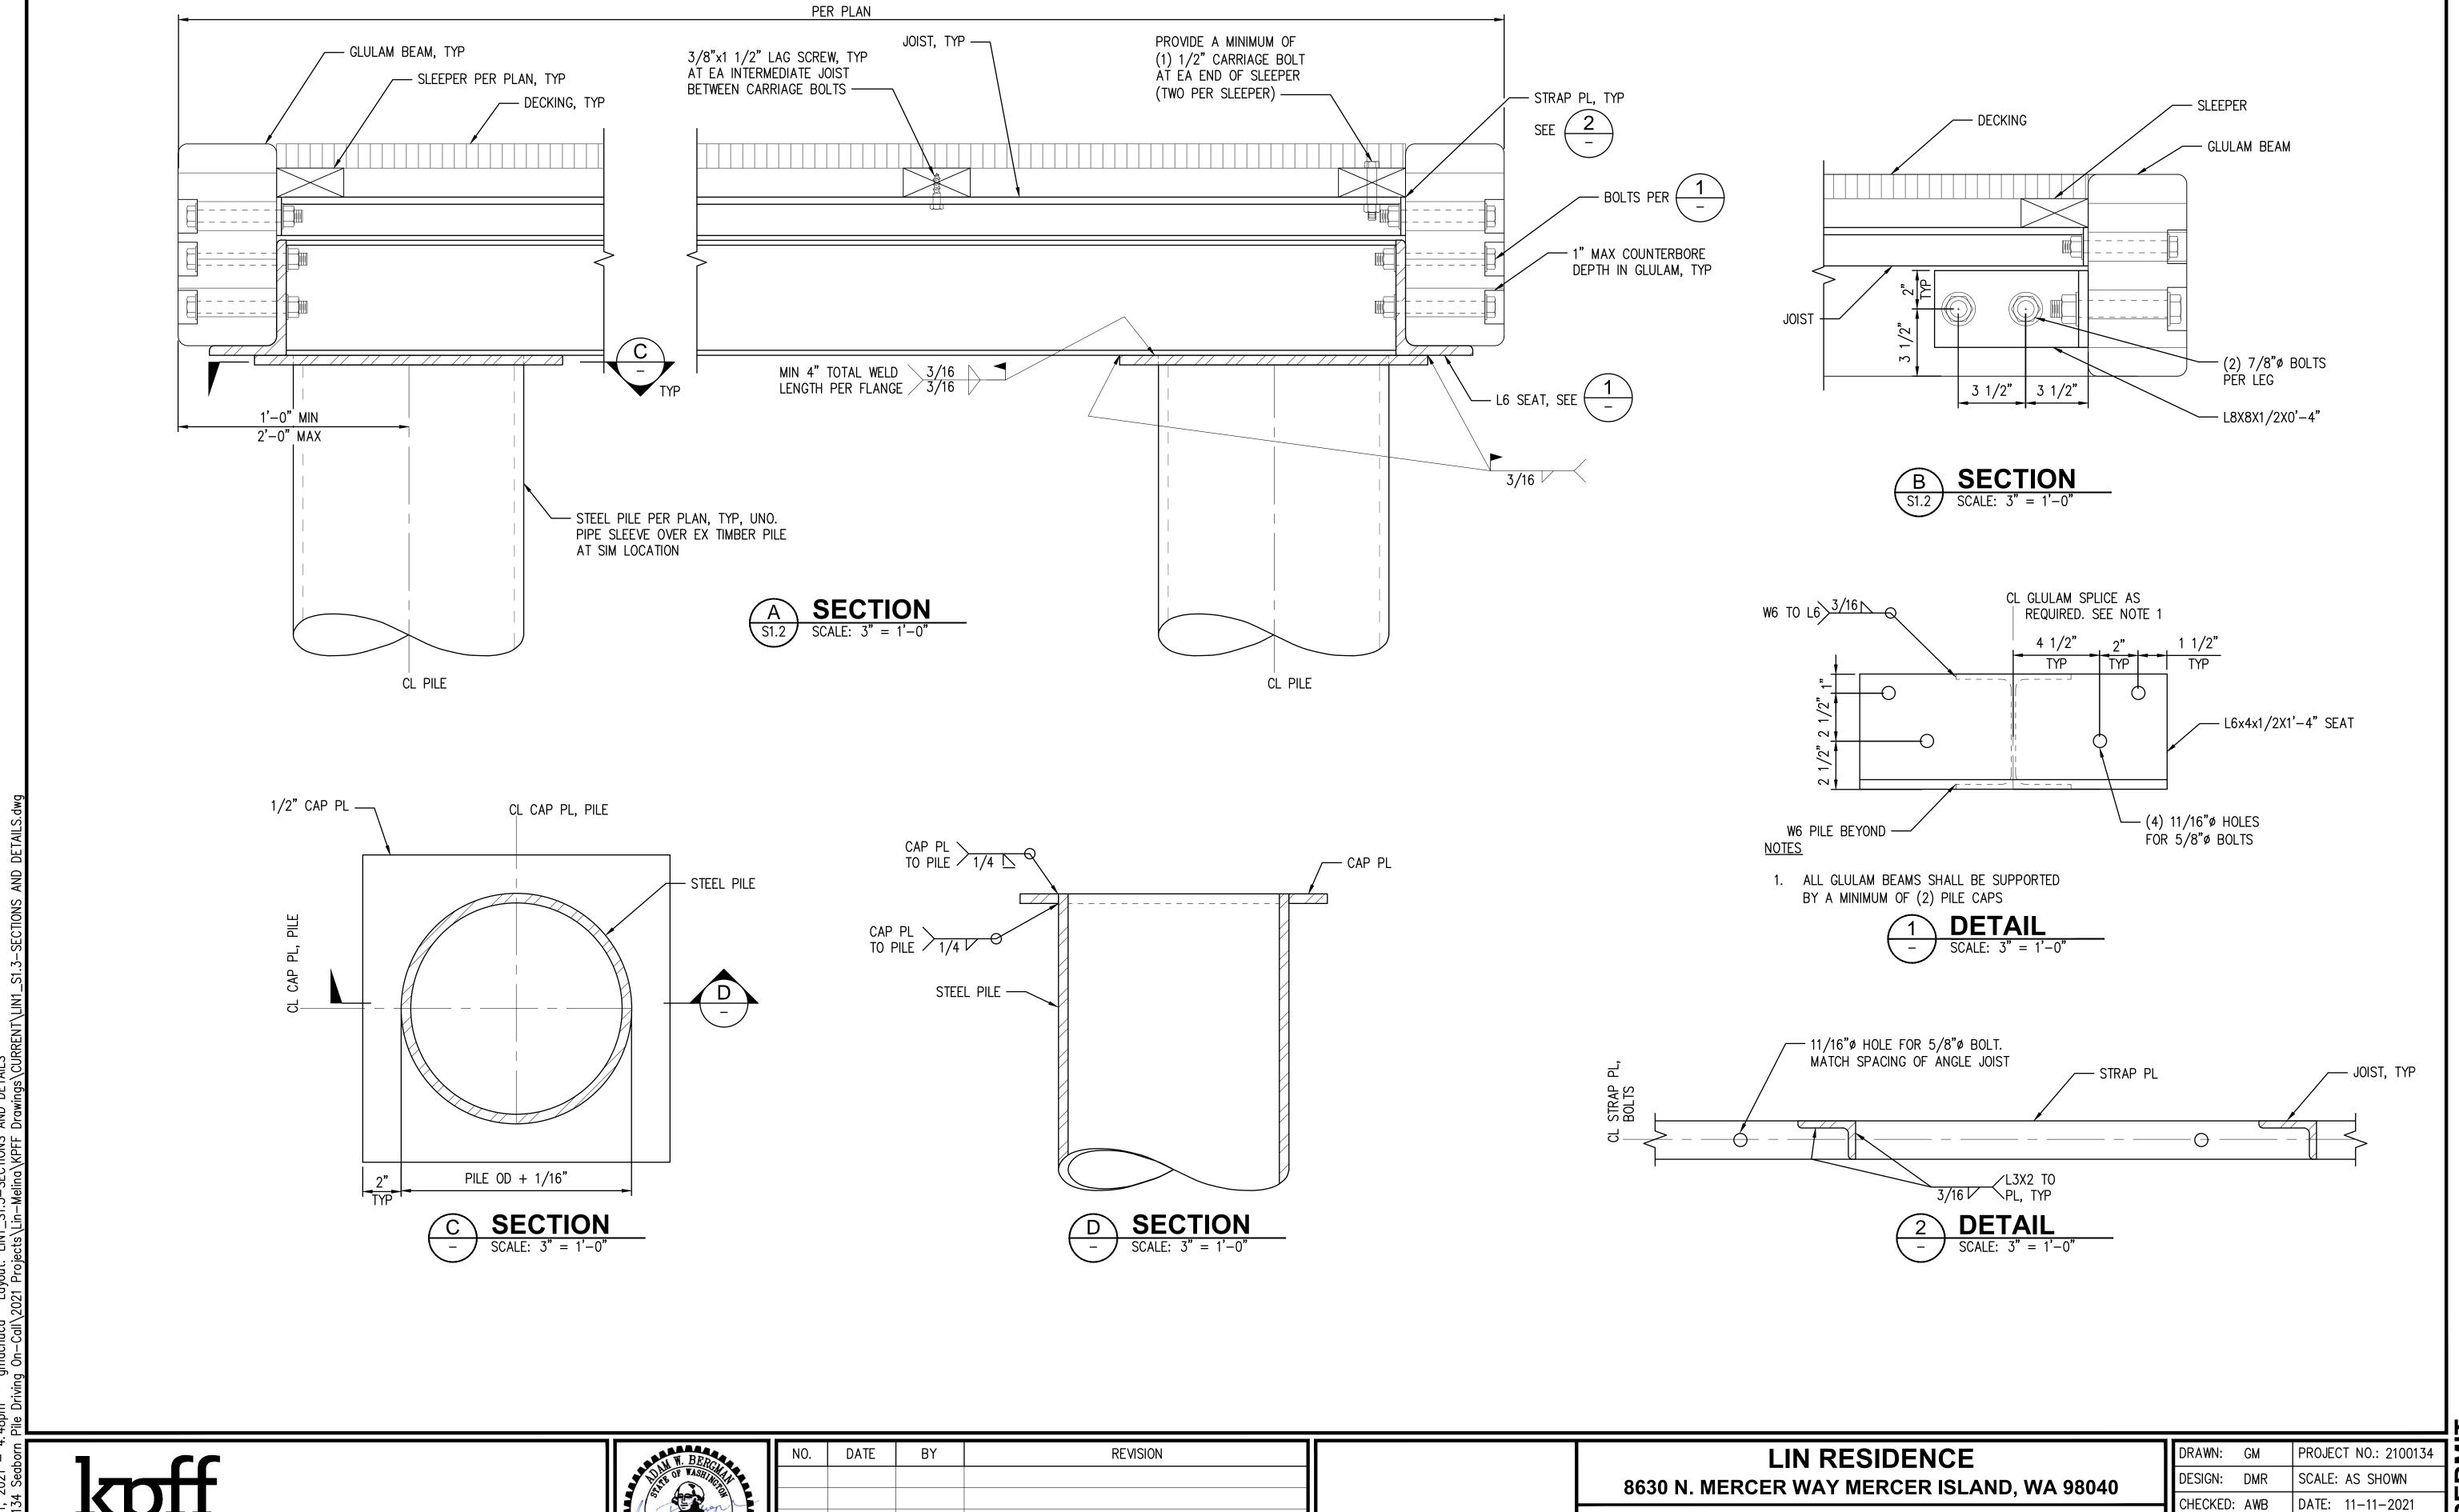
LIN RESIDENCE
8630 N. MERCER WAY MERCER ISLAND, WA 98040

DOCK FRAMING PLAN

	DRAWING NO.	S1.2	
┨	CHECKED: AWB	DATE: 11-11-2021	
ı	DESIGN: DMR	SCALE: AS SHOWN	
1	DRAWN: GM	PROJECT NO.: 2100134	2
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SHEET NO.

02 OF **03**



2407 North 31st Street, Suite 100 Tacoma, Washington 98407 (253) 396-0150 Fax (253) 396-0162

ı	NO.	DATE	BY	REVISION
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SECTIONS AND DETAILS

	DRAWING NO.	S1.3	
\dashv	CHECKED: AWB	DATE: 11-11-2021	
ı	DESIGN: DMR	SCALE: AS SHOWN	Ω
	DRAWN: GM	PROJECT NO.: 2100134	Σ

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03 OF **03**